## ITEM 1

Page 1 of 2

## Town of Kittery Planning Board Meeting February 27, 2020

#### ITEM 1 - 459 U.S. Route One - Major Modification to a Subdivision/Site Plan Review

<u>Action: Accept/deny application. Approve/deny application.</u> Owner and applicant, DSS Land Holdings LLC, requests consideration of a major modification to a mixed-use development consisting of a hotel, and three residential buildings located at 459 U.S. Route 1 (Tax Map 60 Lot 24) in the Mixed Use (MU) Zone. Agents are Ken Wood and Brian Nielsen, Attar Engineering.

#### PROJECT TRACKING

REQ'D	ACTION	COMMENTS	STATUS						
YES	Decision								
YES	Minor Modification and     Hotel Design Review     December 19, 2019     APPROVED       (condition of approval)     (condition of approval)     (condition of approval)								
NO	NO Major Modification Set for February 27, 2020 PENDING								
Applicant: Prior to the signing of the approved Plan any Conditions of Approval related to the Findings of Fact along with waivers and variances (by the BOA) must be placed on the Final Plan and, when applicable, recorded at the York County Registry of Deeds. PLACE THE MAP AND LOT NUMBER IN 1/4" HIGH LETTERS AT LOWER RIGHT BORDER OF ALL PLAN SHEETS. As per Section 16.4.4.L - Grading/construction final plan required. Grading or construction of roads, grading of land or lots, or construction of buildings is prohibited until the original copy of the approved final plan endorsed has been duly recorded in the York County registry of deeds when applicable.									

#### Background

This major modification concerns a previously Planning Board approved (Feb 14, 2019) mixed-use development located at 459 State Route 1 in the Mixed-Use Zone, including 32 age-restricted apartments and 12 single-family dwelling units in 3 buildings and a 112-room hotel. The property was to be divided into two separate parcels. Lot 1 would be 590,468 sf and have 552 feet of street frontage. Lot 2 would be 285,904 sf and have 1104 feet of street frontage.

When the finished grade was calculated for the plans that were approved previously, the elevation of the former nursing home (now demolished) was used. The Applicant is requesting to raise the finished grade of the site by two feet because when estimating construction costs, it was determined that under the approved plans, approximately 25k cubic yards of soil would need to be removed from the site. By adding two feet to the finished grade of the site, the Applicant believes that the environmental and financial burdens of the large-scale soil removal will be avoided. The Applicant will determine the average grade within the development envelope for the hotel and then do the same for the development envelope of the apartment building complex to comply with the 40-foot maximum building height.

#### **Staff Review**

16.10.9.3 Modifications to Approved Plans,

The Board must hear this application because the proposed grade change is greater than 1% as stated in 16.10.9.3. The Applicant's engineer told Staff that the previous finished grade was 62 feet for the hotel so any grade change greater than about 6 inches would exceed the 1%.

#### Stormwater Management

- 1. Because grading affects stormwater, a complete stormwater management plan along with the previously approved plans and the revised plans were submitted for review by staff and CMA Engineers.
- 2. Staff also consulted the Public Works Inspector on retaining the soil on-site versus removing it and its associated stormwater effects and she believes that retaining the soil on-site will be less impactful provided CMA did not find any problems with the stormwater management plans. A copy of the CMA report was sent to her.

#### Peer Review

CMA's review (sent via email) is included. CMA found that there were slight variations to the stormwater calculations which were adjusted to reflect the increased height as compared to the original approved stormwater plan but nothing impactful enough to change the overall stormwater management system design and functionality.

#### **Recommendation / Action**

If the Planning Board finds that no further information is needed, the Board may vote to accept and approve the major modification application.

Move to accept and approve the major modification dated 2/6/2020 to a mixed-use development site plan/subdivision plan originally approved on February 14, 2019 prepared by Attar Engineering, Inc. for owner DSS Land Holdings LLC, for 459 U.S. Route 1 (Tax Map 60 Lot 24) in the Mixed-Use Zone.



Ms. Kathy Conner, Interim Planner Town of Kittery P.O. Box 808 Kittery, Maine 03904 February 6, 2020 Project No.: C052-20

### Re: 459 US Route 1 - Kittery Major Modification

Dear Ms. Conner:

We respectfully request the Planning Board review our Application for Major Modification in regards to The Homestead property.

Both the owner of the hotel property and the owner of apartment property at The Homestead have expressed the desire to raise the proposed finished grade of the site. While pricing the project it was noted that constructing the project per the approved design would result in roughly 25,000 cubic yards of exported soils from the site.

A large export of soils, like the one noted above, is both a financial and environmental burden. As part of this application we have provided updated Site, Grading and Stormwater Plans to reflect the new proposed grade. The areas surrounding the hotel and apartments have been raised approximately 2 feet where setbacks and drainage conditions allow.

Thank you for taking the time to review our application and we look forward to discussing the project with you at the next available Planning Board Meeting.

Sincerely,

Brian Nielsen, EIT Staff Engineer

cc: Landmark Hill, LLC David Trahan Jayesh Patel

2020-02-06 - C052-20 The Homestead Major Modification

## TOWN OF KITTERY, MAINE TOWN PLANNING AND DEVELOPMENT DEPARTMENT

200 Rogers Road, Kittery, Maine 03904 PHONE: (207) 475-1323 FAX: (207) 439-6806



## www.kittery.org

## **APPLICATION:**

## MAJOR MODIFICATION TO AN APPROVED PLAN-SITE PLAN

					Storage Storag				\$5.00/100 SQ FT OF ADDITIONAL GROSS FLOOR AREA				Application Fee Paid:	
FEE FOR SITE PLAN AMENDMENT REVIEW: (TITLE 16.10.9.3)		☐ \$300. 00 PLUS THE GREATER OF		IE   C	☐ \$0.50/LINEAR FOOT OF ADDITIONAL DOCK, SLIP & FLOAT; OR			INTE	Steeping AccomodationsAsa Fee PaiAsa Fee Pai(TITLE 3.3 TO)					
PROPERTY P DESCRIPTION		Parcel ID M		Мар	60	Lot	24		Zone(s): Overlay: MS4:		MU, R-RL Shoreland X YES NO		Land Area are Feet)	876,427.2
		Physi Addr		459 L	IS Route	1								
PROPERTY OWNER'S			Name Phone		DSS Land Holdings LLC 207-363-4088			Mailing		PO Box 242 York, ME				
INFORMATION			Fax Ema	dss@maine.rr.com			Address			03909				
			Nam	ne J	Kenneth Wood, P.E.			Nam Busin		Attai	Attar Engineering, Inc.			
	CANT'S		Phor	ne 2	207-439-6023									
AGEN INFOR	MATION		Fax				Mailing Address		1284 State Road Eliot, ME 03903					
			Ema	il ke	ken@attarengineering.com									
	Project Name:	Tł	ne Ho	mest	ead									
z	Existing Use:	V	acant,	previo	usly use	d as nu	rsing hom	ie.						
ΡΤΙΟ														
ECT DESCRIPTION	Proposed Ame the Town Code											nown a	reas of non-con	pliance to
ECT D	Propose to raise the final grade of the site.													
PROJ														
l certif	fy, to the best	of my	knowl	edge,	this app	lication	informat	ion is	true and o	correct a	nd I will not	devia	te from the pla	an
	tted without n													

Applicant's		Owner's	Agant
Signature:	2///2020	Signature:	,Agent
Date:	2/6/2020	Date:	2/6/2020

	Minimum	Plan	<b>Submittal</b>	Requirements
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	5 COPIES OF THIS APPLICATION						
	5 COPIES OF THE APPROVED SITE PLAN – 12 REDUCED S 5 COPIES OF THE PROPOSED AMENDED SITE PLAN– 12						
	PDF OF THE SITE PLAN SHOWING GPS COORDINATES						
BOARD WI BEEN PR COMPLETE	BEGINNING THE REVIEW PROCESS, THE PLANNING LL DECIDE WHETHER SUFFICIENT INFORMATION HAS OVIDED AND WILL VOTE TO <i>DETERMINE</i> ENESS/ACCEPTANCE. APPLICANT IS RESPONSIBLE TO PRESENT A <u>CLEAR</u>	NOTE TO APPLICANT: PRIOR TO THE SITE WALK, TEMPORARY MARKERS MUST BE ADEQUATELY PLACED THAT ENABLE THE PLANNING BOARD TO READILY LOCATE AND APPRAISE THE LAYOUT OF DEVELOPMENT. Waiver Request					
	ERSTANDING OF THE PROPOSED AMENDMENT.		Ordinance	Describe why this request is being			
A) Pape	er size:		Section	made.			
	No less than 11" X 17" (reduced) or greater than 24" X 36"		*** <i>EXAMPLE***</i> 16.32.560 (B)- OFFSTREET	***EXAMPLE*** Requesting a waiver of this ordinance since the proposed professional offices have a written			
,	e size:	NO	PARKING.	agreement with the abutting Church owned property to share parking.			
	Under 10 acres: no greater than 1" = 30' 10 + acres: 1" = 50'	IT					
	e block: Applicant's name and address Name of preparer of plans with professional information and professional seal Date of plan preparation PARCEL'S TAX MAP ID (MAP/LOT) 1/4" TALL IN LOWER RIGHT	DESCRIPTION					
	SITE PLAN AMENDMENT' CLEARLY PART OF TITLE						
D) Clea	arly show how the approved plan will be amended.						
E) Prov	vide signature blocks for amended approval.						
, that	vide all associated reference material and or documentation c clarifies and or supports the purpose of the proposed endment.	<b>16.10.8.2.5 Conditions or Waivers.</b> Conditions required by the Planning Board at the final plan review phase must have been met before the final plan may be given final approval unless so specified in the condition or specifically waived, upon written request by the applicant, by formal Planning Board action wherein the character and extent of such waivers which may have been requested are such that they may be waived without jeopardy to the public health, safety and general welfare.					
	isions to the boundary, internal lots and or parcels must be ed and sealed by a surveyor licensed in the State of Maine.						
<ul> <li>Revisions to the proposed site must be signed and sealed by a professional engineer licensed in the State of Maine.</li> </ul>			•	granting modifications or waivers, the Planning Board ns as will, in its judgment, substantially meet the			
SEE TITLE 10	6.10.5.2 FOR COMPLETE LIST OF SUBMITTAL INFORMATION	objecti	ves of the requireme	ents so waived or modified.			

## SUBMITTALS THE TOWN PLANNER DEEMS SUFFICIENTLY LACKING IN CONTENT WILL NOT BE SCHEDULED FOR PLANNING BOARD REVIEW.

#### COMPLETED BY OFFICE STAFF

ASA CHARGE		AMOUNT	ASA CHARGE	AMOUNT	
REVIEW			SERVICES		
LEGAL FEES	(TBD)		RECORDER	\$35	
ENGINEERS REVIEW	(TBD)		FACT FINDING (TBD)		
ABUTTER NOTICES			<b>3<sup>RD</sup> PARTY INSPECTIONS</b> (TBD)		
Postage		\$20	OTHER PROFESSIONAL SERVICES	\$50	
LEGAL NOTICES			PERSONNEL		
		\$300	SALARY CHARGES IN EXCESS OF 20 HOURS		
SUPPLIES					
OFFICE		\$5			
S	UB TOTAL		SUB TOTAL		
			TOTAL ASA REVIEW FEES		

Jayesh Patel (774)262-8150 1

February 6, 2020

Kathy Connor, Project Planner Town of Kittery PO BOX 808 Kittery, ME 03904

Dear Ms. Connor:

Please be informed that Kenneth A. Wood P.E. and Brian Nielsen E.I.T. of Attar Engineering, Inc. will be acting as my agents for the applications for 459 US Route One, Kittery, Maine.

Please contact me if I can provide any additional information.

Sincerely; Jorigen latel

Jayesh Patel

cc: Kenneth A. Wood, P.E. Attar Engineering, Inc.

### David Trahan One Bridgeview Circle Tyngsboro, MA 01879 (978)815-3662

February 6, 2020

Kathy Connor, Project Planner Town of Kittery PO BOX 808 Kittery, ME 03904

Dear Ms. Connor:

Please be informed that Kenneth A. Wood P.E. and Brian Nielsen E.I.T. of Attar Engineering, Inc. will be acting as my agents for the applications for 459 US Route One, Kittery, Maine.

Please contact me if I can provide any additional information.

Sincerely;

David Trahan

cc: Kenneth A. Wood, P.E. Attar Engineering, Inc.

From:	William Straub
To:	Kathy Connor; Adam Causey
Cc:	Jodie Bray Strickland
Subject:	Kittery 459 US Route 1- Homestead Revised Subdivision Design
Date:	Wednesday, February 19, 2020 10:16:13 AM
Attachments:	image003.png

Kathy and Adam,

We have reviewed the application for a major modification to the design of the Homestead property at 459 US Route 1 in Kittery. The application was made February 6, 2020, and included the application form, revised design drawings, and an updated stormwater report. The materials were prepared by Attar Engineering of Eliot.

The project was originally approved in 2019. As you know the project includes a hotel and separate multi-unit residential buildings, and associated roadways, drainage, and utilities. The modified design was completed to reduce the amount of net cut material that would have needed to be removed from the site to reach the designed subgrade. The applicant described that the previous design required that over 20,000 cubic yards of soil material would have been trucked from the site. The revised design increases the surficial grades of much of the project by 2-3 feet, thereby decreasing the overall excavation required for the project.

This modified design is essentially the same as the approved 2019 design:

- The horizontal layout of all major facilities, including buildings, roadways, and drainage features does not change,
- There are the minor vertical modifications (increases) as described above,
- The horizontal configuration of site drainage, and stormwater management features such swales, pipes, treatment ponds, and discharge locations is essentially the same between the designs. The vertical elevations of some have been modified slightly to accommodate the increased elevations of the project.
- We have reviewed the revised stormwater report in comparison to the report approved for the 2019 design. There are no significant changes to the calculated performance between the original and modified designs.

Accordingly, based on this review, the technical issues of the original approval do not change in any significant way relative to the Kittery LUDC.

Should you have any questions or comments, please do not hesitate to call.


Best,


Bill

William A. Straub, P.E. Principal/Project Manager



**CMA Engineers, Inc.** 35 Bow Street Portsmouth, NH 03801 603-431-6196 www.cmaengineers.com

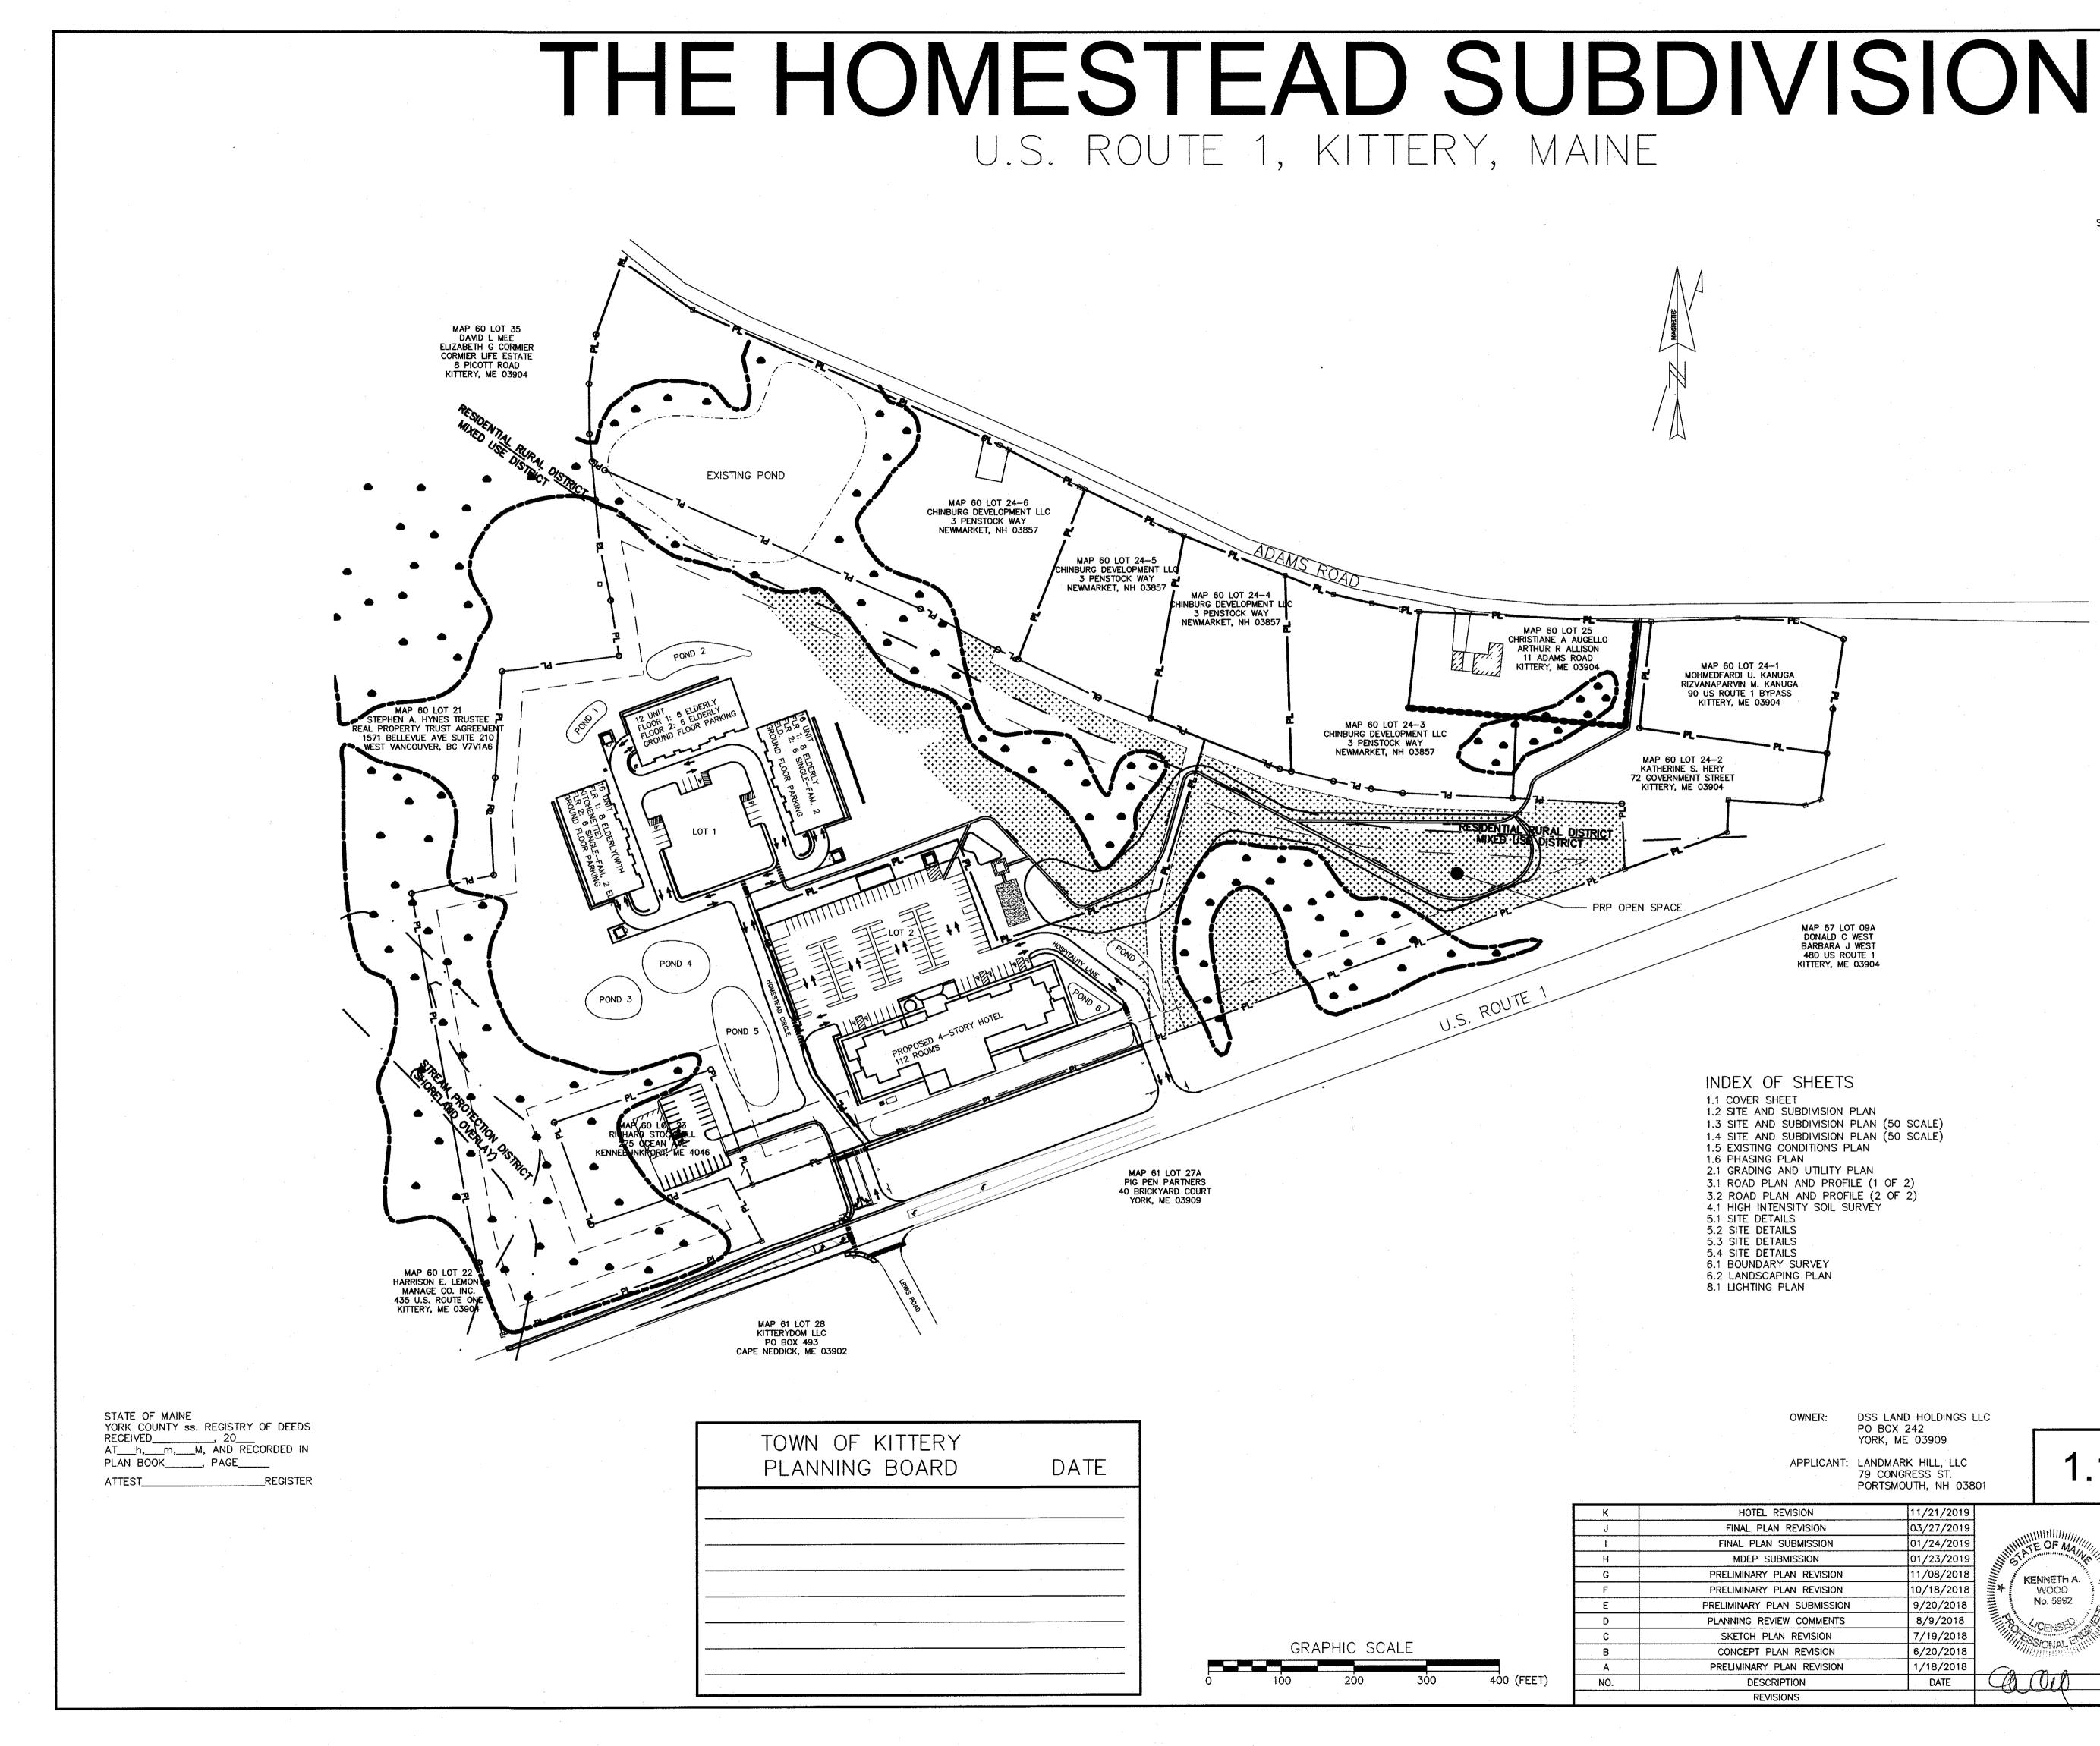

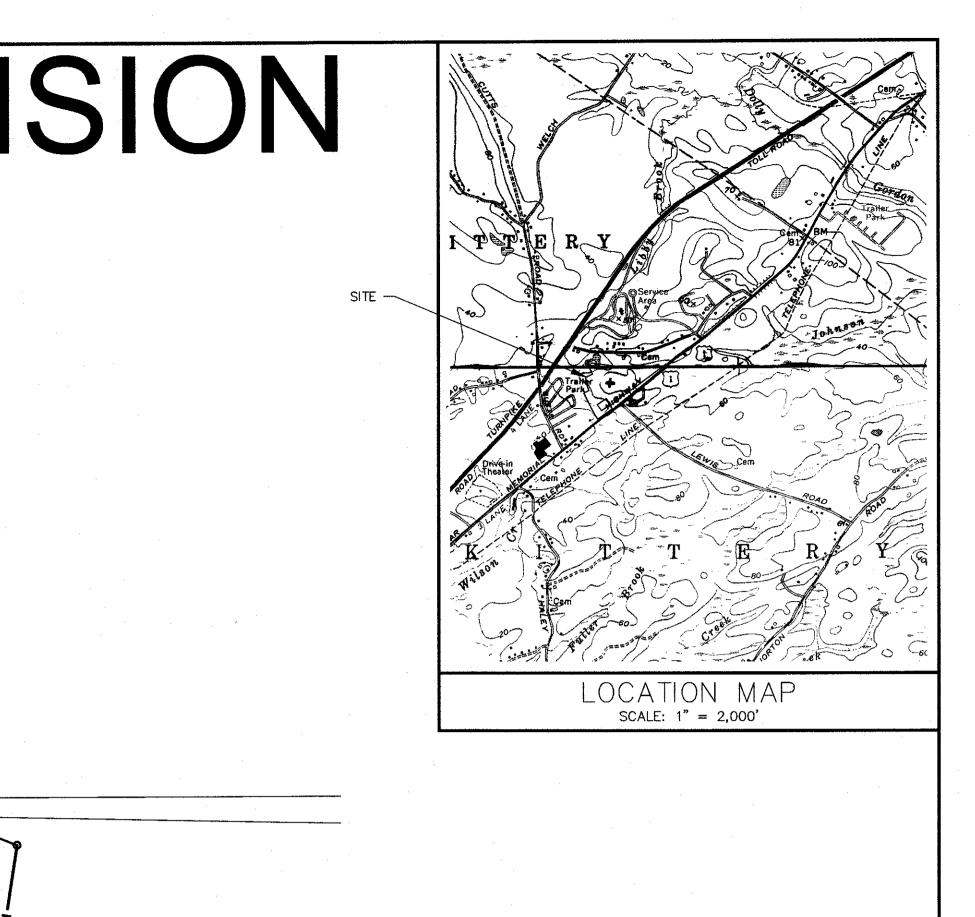


MAP 67 LOT 09A DONALD C WEST BARBARA J WEST 480 US ROUTE 1 KITTERY, ME 03904

1.3 SITE AND SUBDIVISION PLAN (50 SCALE) 1.4 SITE AND SUBDIVISION PLAN (50 SCALE) 1.5 EXISTING CONDITIONS PLAN

3.1 ROAD PLAN AND PROFILE (1 OF 2) 3.2 ROAD PLAN AND PROFILE (2 OF 2) 4.1 HIGH INTENSITY SOIL SURVEY

OWNER: DSS LAND HOLDINGS LLC PO BOX 242 YORK, ME 03909 COVER SHEET 1.1 APPLICANT: LANDMARK HILL, LLC THE HOMESTEAD 79 CONGRESS ST. 459 US ROUTE 1 KITTERY, MAINE PORTSMOUTH, NH 03801 11/21/2019 FOR: LANDMARK HILL, LLC 79 CONGRESS ST PORTSMOUTH, NH 03801 03/27/2019 TE OF MA 01/24/2019 01/23/2019 ATTAR ENGINEERING, INC. 1/08/2018 KENNETH A. 10/18/2018 W000 No. 5992 9/20/2018 8/9/2018 ~<u>~</u>08/3 SCALE: DRAWN BY: APPROVED BY 7/19/2018 1159SIONAL' 1" = 100' BRN 6/20/2018 DATE: REVISION : DATE 1/18/2018 w K: 11/21/2019 02/08/2018 (0)DATE 170/104 JOB NO: C052-18 FILE: THE HOMESTEAD BASE SHEET 1.1 TAX MAP 60, LOT 24

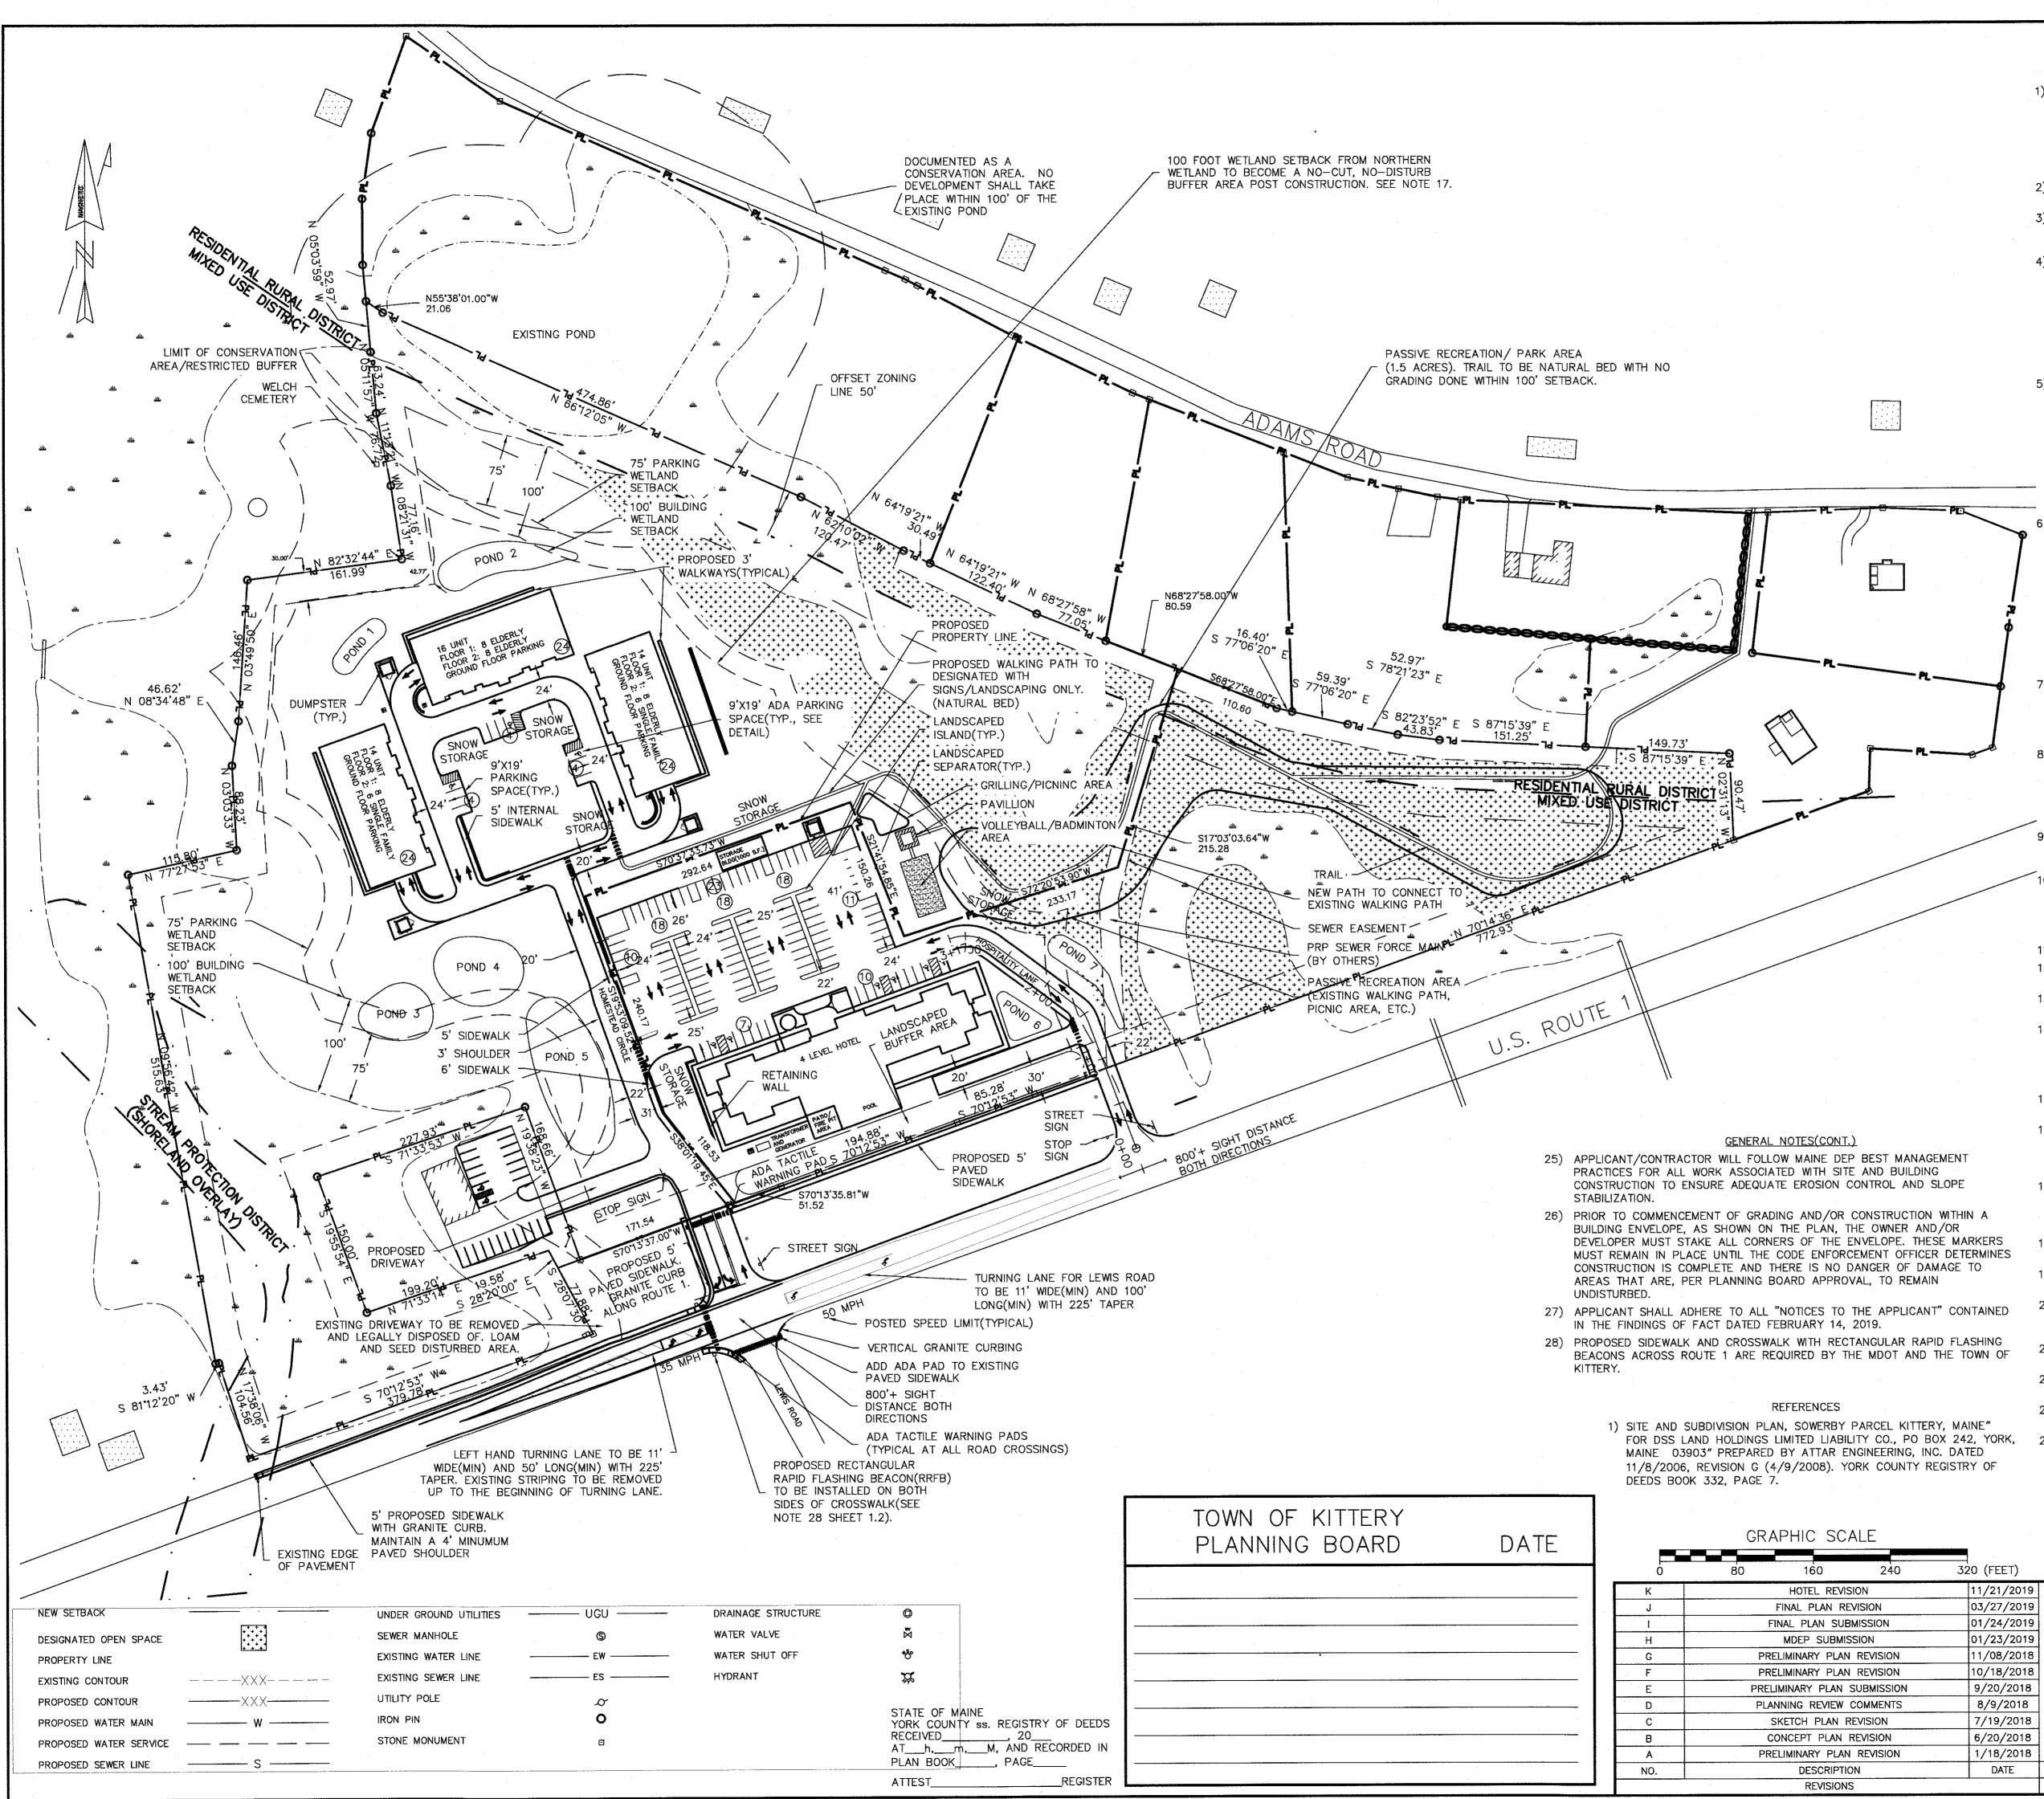

GENERAL NOTES

- 1) THIS PLAN PROVIDES DETAILS FOR A MIXED USE DEVELOPMENT AT 459 U.S. ROUTE 1 CONSISTING OF 32 SINGLE-FAMILY (ELDERLY) APARTMENTS AND 12 SINGLE-FAMILY RESIDENTIAL UNITS IN 3 BUILDINGS AND A 112 ROOM HOTEL. SINGLE-FAMILY RESIDENTIAL UNITS ON THE UPPER FLOORS OF A MIXED-USE BUILDING ARE A "PERMITTED USE". HOUSING FOR THE ELDERLY AND A HOTEL ARE "SPECIAL EXCEPTION USES". THE PROPERTY IS TO BE SUBDIVIDED INTO TWO SEPARATE PROPERTIES (SEE PROPOSED PROPERTY LINE ON SITE PLANS). LOT 1 HAS 590,468 SF OF AREA AND 552' OF STREET FRONTAGE. LOT 2 HAS 285,904 SF OF AREA AND 1104' OF STREET FRONTAGE. 2) THIS SITE WAS PREVIOUSLY APPROVED AS THE SOWERBY MIXED-USE PROJECT IN 2008. SEE REF.
- 3) THE PARCEL, IDENTIFIED AS LOT 24 ON TAX MAP 60, CONTAINS APPROXIMATELY 20.12 ACRES; AND
- IS LOCATED WITHIN THE MIXED-USE (MU), RESIDENTIAL RURAL (R-RL) AND SHORELAND OVERLAY ZONING DISTRICTS. THE PARCEL IS SERVED BY MUNICIPAL WATER AND SEWER SYSTEMS. 4) SPACE AND BULK REQUIREMENTS FOR THE MIXED USE ZONING DISTRICT ARE AS FOLLOWS:

MIXED USE DISTRICT MIN. LOT AREA MIN. STREET FRONTAGE MIN. FRONT SETBACK MIN. SIDE SETBACK MIN. REAR SETBACK MAX BUILDING HEIGHT PARKING IS CALCULATED AS	200,000 SF (LOT 1: 590,468 SF, LOT 2: 285,904 SF) 250' (LOT 1: 552', LOT 2: 1104') 30' 40' (100' WETLAND SETBACK SUPERCEDES) 40' (100' WETLAND SETBACK SUPERCEDES) 40' 5 FOLLOWS;

UNIT TYPE		NO. OF UNITS	S./SF	SPACES/UNIT	SF/UNIT	REQUIRED
ELDERLY	32	UNITS	1.5		N/A	48
APARTMENTS	12	UNITS	2		N/A	24
HOTEL	112		1		N/A	115(CONF.ROOM)

TOTAL REQUIRED SPACES = 187 WITH 199 PROVIDED(24 ON GROUND FLOOR OF RESIDENTIAL BUILDINGS, EACH WITH 2 ADA SPACES, 12 EXTERIOR GUEST SPACES (3 ADA), 6 ADA SPACES AT HOTEL)

6) BUILDABLE AREA/RESIDENTIAL DENSITY

=> 413,987.5 S.F. = 9.50 AC. NET RESIDENTIAL AREA \*INCLUDES WETLANDS, POORLY DRAINED AND VERY POORLY DRAINED SOILS


\*\*INCLUDING TRAVELED WAYS AND PARKING <u>NET RESIDENTIAL DENSITY</u> = 413,987.5 - (32 ELD. X 10,000) - (12 SINGLE X 7,500) = 3987.5 => 0K


- MIXED-USE REQUIREMENT IS CALCULATED AS FOLLOWS:
- APARTMENTS = 11,232 S.F. X 2 FLOORS = 22,464 S.F. APARTMENTS(ELD.) = 11,232 S.F. X 4 FLOORS = 44,928 S.F.
- = 15,712 S.F. X 4 FLOORS = 62,848 S.F. HOTEL

22,464/130,240 = 17.2% WHICH IS GREATER THAN 10% (REQUIRED).


- PROPERTY LINES, WETLANDS, EXISTING CONDITIONS AND TOPOGRAPHY ARE FROM REFERENCE 1 WETLANDS WERE IDENTIFIED IN THE FIELD BY KENNETH A. WOOD, CWS IN DECEMBER, 1999 AND MICHAEL R. CUOMO, CWS, CSS IN MARCH, 2000. WETLANDS WERE LOCATED WITH SURVEY INSTRUMENT BY ATTAR ENGINEERING, INC. FROM DECEMBER, 1999 THROUGH APRIL, 2000. WETLAND DELINEATION WAS VERIFIED IN 2017 BY KENNETH A. WOOD, CWS. NO CHANGES WERE NOTED FROM THE PREVIOUS DELINEATION
- 9) TOTAL OPEN SPACE REQUIRED IS 35%; 25% OF OPEN SPACE MUST BE IN FRONT 50% OF THE PARCEL: 20.23 AC X 0.35 = 7.08 AC REQUIRED WITH 7.29 AC PROVIDED: 7.08 AC X 0.25 =1.77 AC REQUIRED WITH 5.58 AC PROVIDED IN THE FRONT OF THE PARCEL.
- 10) LANDSCAPING ALONG THE FRONTAGE OF US ROUTE 1 SHALL CONSIST OF A MIXTURE OF EVERGREEN AND DECIDUOUS TREES AND SHRUBS. TREES TO BE ON 25' C.L. SPACING AND A MIX OF 10 SHRUBS AND/OR FLOWERING PERENNIAL PLANT SPECIES FOR EVERY 40' OF FRONTAGE. 66 TOTAL TREES AND 410 SHRUBS TO BE PLANTED IN LANDSCAPED PLANTER STRIP ALONG STREET FRONTAGE. TREES TO BE A MINIMUM 2.5" CALIPER AND 12' HIGH AT TIME OF PLANTING.
- 11) ALL BUILDINGS WILL BE SPRINKLED FOR FIRE PROTECTION. 12) TOTAL AREA TO BE DISTURBED: 8.92 ACRES, TOTAL IMPERVIOUS AREA: 3.89 ACRES, TOTAL LOT STREET FRONTAGE 1655.7 FT.
- 13) A 50' ZONE BOUNDARY EXTENSION IS REQUESTED FOR THE MIXED-USE BOUNDARY TO THE NORTH(SHOWN ON SITE PLAN).
- 14) EXPECTED ANNUAL AVERAGE DAILY TRAFFIC(AADT) = 32 X 3.48(ELDERLY, ITE 252) + 12 X 6.59(RESIDENTIAL/APARTMENT, ITE 221) + 112 X 8.92(HOTEL, ITE 310/320) = 1,190 TRIPS/DAY. 190 TRIPS WILL BE GENERATED BY THE RESIDENTIAL AND ELDERLY UNITS ON HOMESTEAD CIRCLE. AM AND PM PEAK HOUR TRIPS ESTIMATED AT 115 AND 133 RESPECTIVELY(DEVELOPMENT AND ABUTTING MEDICAL OFFICE). SEE TRAFFIC STUDY FOR ADDITIONAL INFORMATION.
- 15) RESIDENTS OF THE ELDERLY AND APARTMENT UNITS WILL BE ALLOWED TO PURCHASE HEALTH CLUB/POOL MEMBERSHIPS FROM THE HOTEL.
- 16) HOMESTEAD CIRCLE AND HOSPITALITY LANE TO BE AND MUST REMAIN PRIVATE ROADS, WITH THE PROPERTY OWNERS OR OTHER SUCH ENTITIES BEARING ALL RESPONSIBILITY FOR MAINTENANCE INCLUDING BUT NOT LIMITED TO, SNOWPLOWING, PAVING AND STORMWATER SYSTEM OPERATION AND REPAIR. NO ON-STREET PARKING WILL BE PERMITTED.
- 17) WITH THE EXCEPTION OF THE PROPOSED CONSTRUCTION IN THIS PLAN THE 100 FT SETBACK FROM THE NORTHERN WETLAND WILL BECOME A NO CUT, NO DISTURB RESTRICTED BUFFER AREA AND MUST REMAIN UNDEVELOPED AND UNDISTURBED IN PERPETUITY, INCLUDING NO MOWING OR REMOVAL OF ANY VEGETATION WITHOUT A PERMIT FROM THE CODE ENFORCEMENT OFFICER.
- 18) IF ON-SITE SNOW STORAGE AREAS DO NOT HAVE ENOUGH CAPACITY ADDITIONAL SNOW SHALL BE REMOVED FROM THE SITE.
- 19) KITCHENETTE/MEETING SPACE TO BE INCLUDED ON FIRST FLOOR OF WESTERN APARTMENT BUILDING.
- 20) SEE THE APPROVED "THE HOMESTEAD-MIXED USE DEVELOPMENT, OPERATION AND MAINTENANCE PROGRAM STORMWATER MANAGEMENT BMP'S" FOR MAINTENANCE OF ALL STORMWATER BEST MANAGEMENT PRACTICES.
- 21) A ROAD ACCESS EASEMENT SHALL BE PROVIDED TO LOT 2(HOTEL) FOR THE USE OF HOMESTEAD CIRCLE IN ORDER TO ENTER AND EXIT THE HOTEL PARKING LOT.
- 22) BUILDING DESIGN PLANS FOR THE HOTEL MUST BE APPROVED BY THE PLANNING BOARD PRIOR TO ISSUANCE OF A BUILDING PERMIT FOR THE HOTEL BUILDING.
- 23) A MAINTENANCE PLAN AND AGREEMENT MUST BE PROVIDED TO THE SATISFACTION OF THE TOWN PEER REVIEW ENGINEER AND THE TOWN ATTORNEY. 24) NO CHANGES, ERASURES, MODIFICATIONS, OR REVISIONS MAY BE MADE TO THE APPROVED PLAN,
- INCLUDING NO FURTHER LAND DIVISION OR ADDITIONAL DWELLING UNITS MAY BE ESTABLISHED WITHOUT PLANNING BOARD APPROVAL.

SCALE 240	320 (FEET)	1.2	SITE AND SUBDIVISION PLAN THE HOMESTEAD 459 US ROUTE 1 KITTERY, MAINE
REVISION N REVISION SUBMISSION JBMISSION	11/21/2019 03/27/2019 01/24/2019 01/23/2019	TATE OF MAN	FOR: LANDMARK HILL, LLC 79 CONGRESS ST PORTSMOUTH, NH 03801
PLAN REVISION PLAN REVISION LAN SUBMISSION IEW COMMENTS	11/08/2018 10/18/2018 9/20/2018 8/9/2018	KENNETH A. WOOD No. 5992	ATTAR ENGINEERING, INC. CIVIL • STRUCTURAL • MARINE 1284 STATE ROAD - ELIOT, MAINE 03903 PHONE: (207)439-6023 FAX: (207)439-2128
AN REVISION AN REVISION	7/19/2018 6/20/2018	SSIONAL ESTIMATION	SCALE: 1'' = 80' $APPROVED BY:$ $DRAWN BY:$ $BRN$ $BRN$
PLAN REVISION	1/18/2018 DATE	A = 00	DATE: 02/08/2018 U/20/2019 REVISION : DATE K: 11/21/2019
SIONS		Un vin	JOB NO: C052-18 FILE: THE HOMESTEAD BASE SHEET 1.2
		·	TAX MAP 60, LOT 24

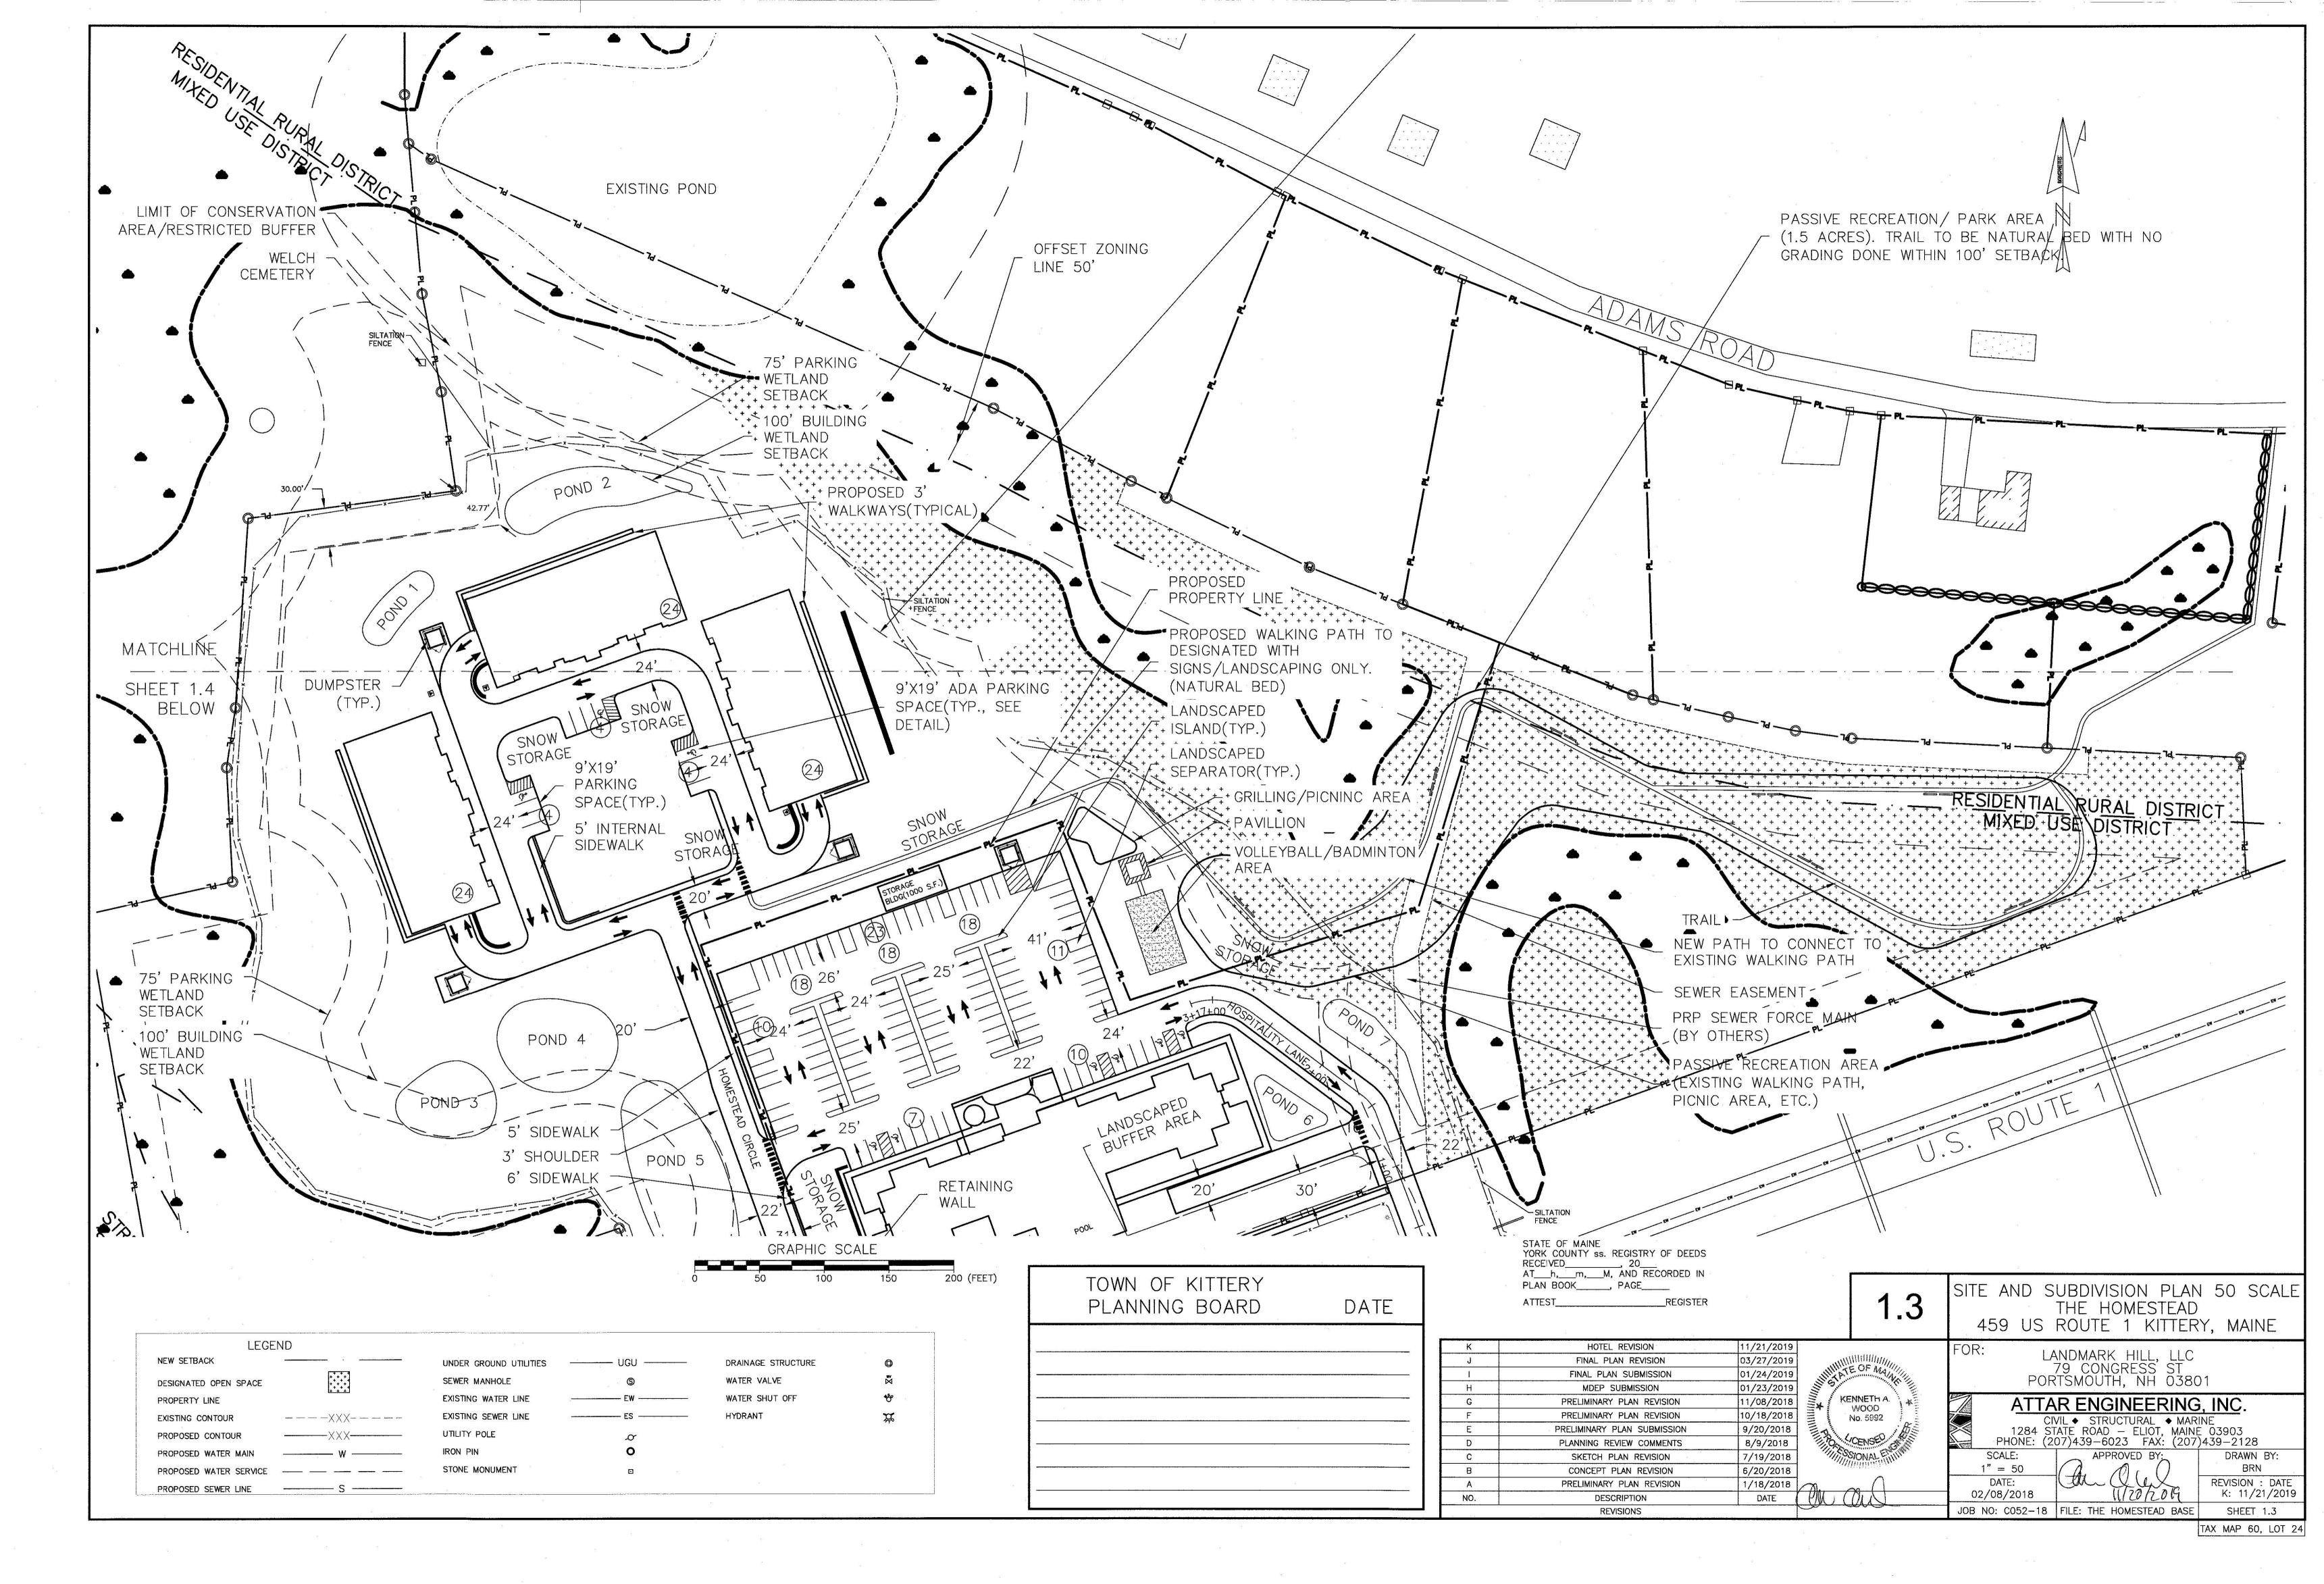

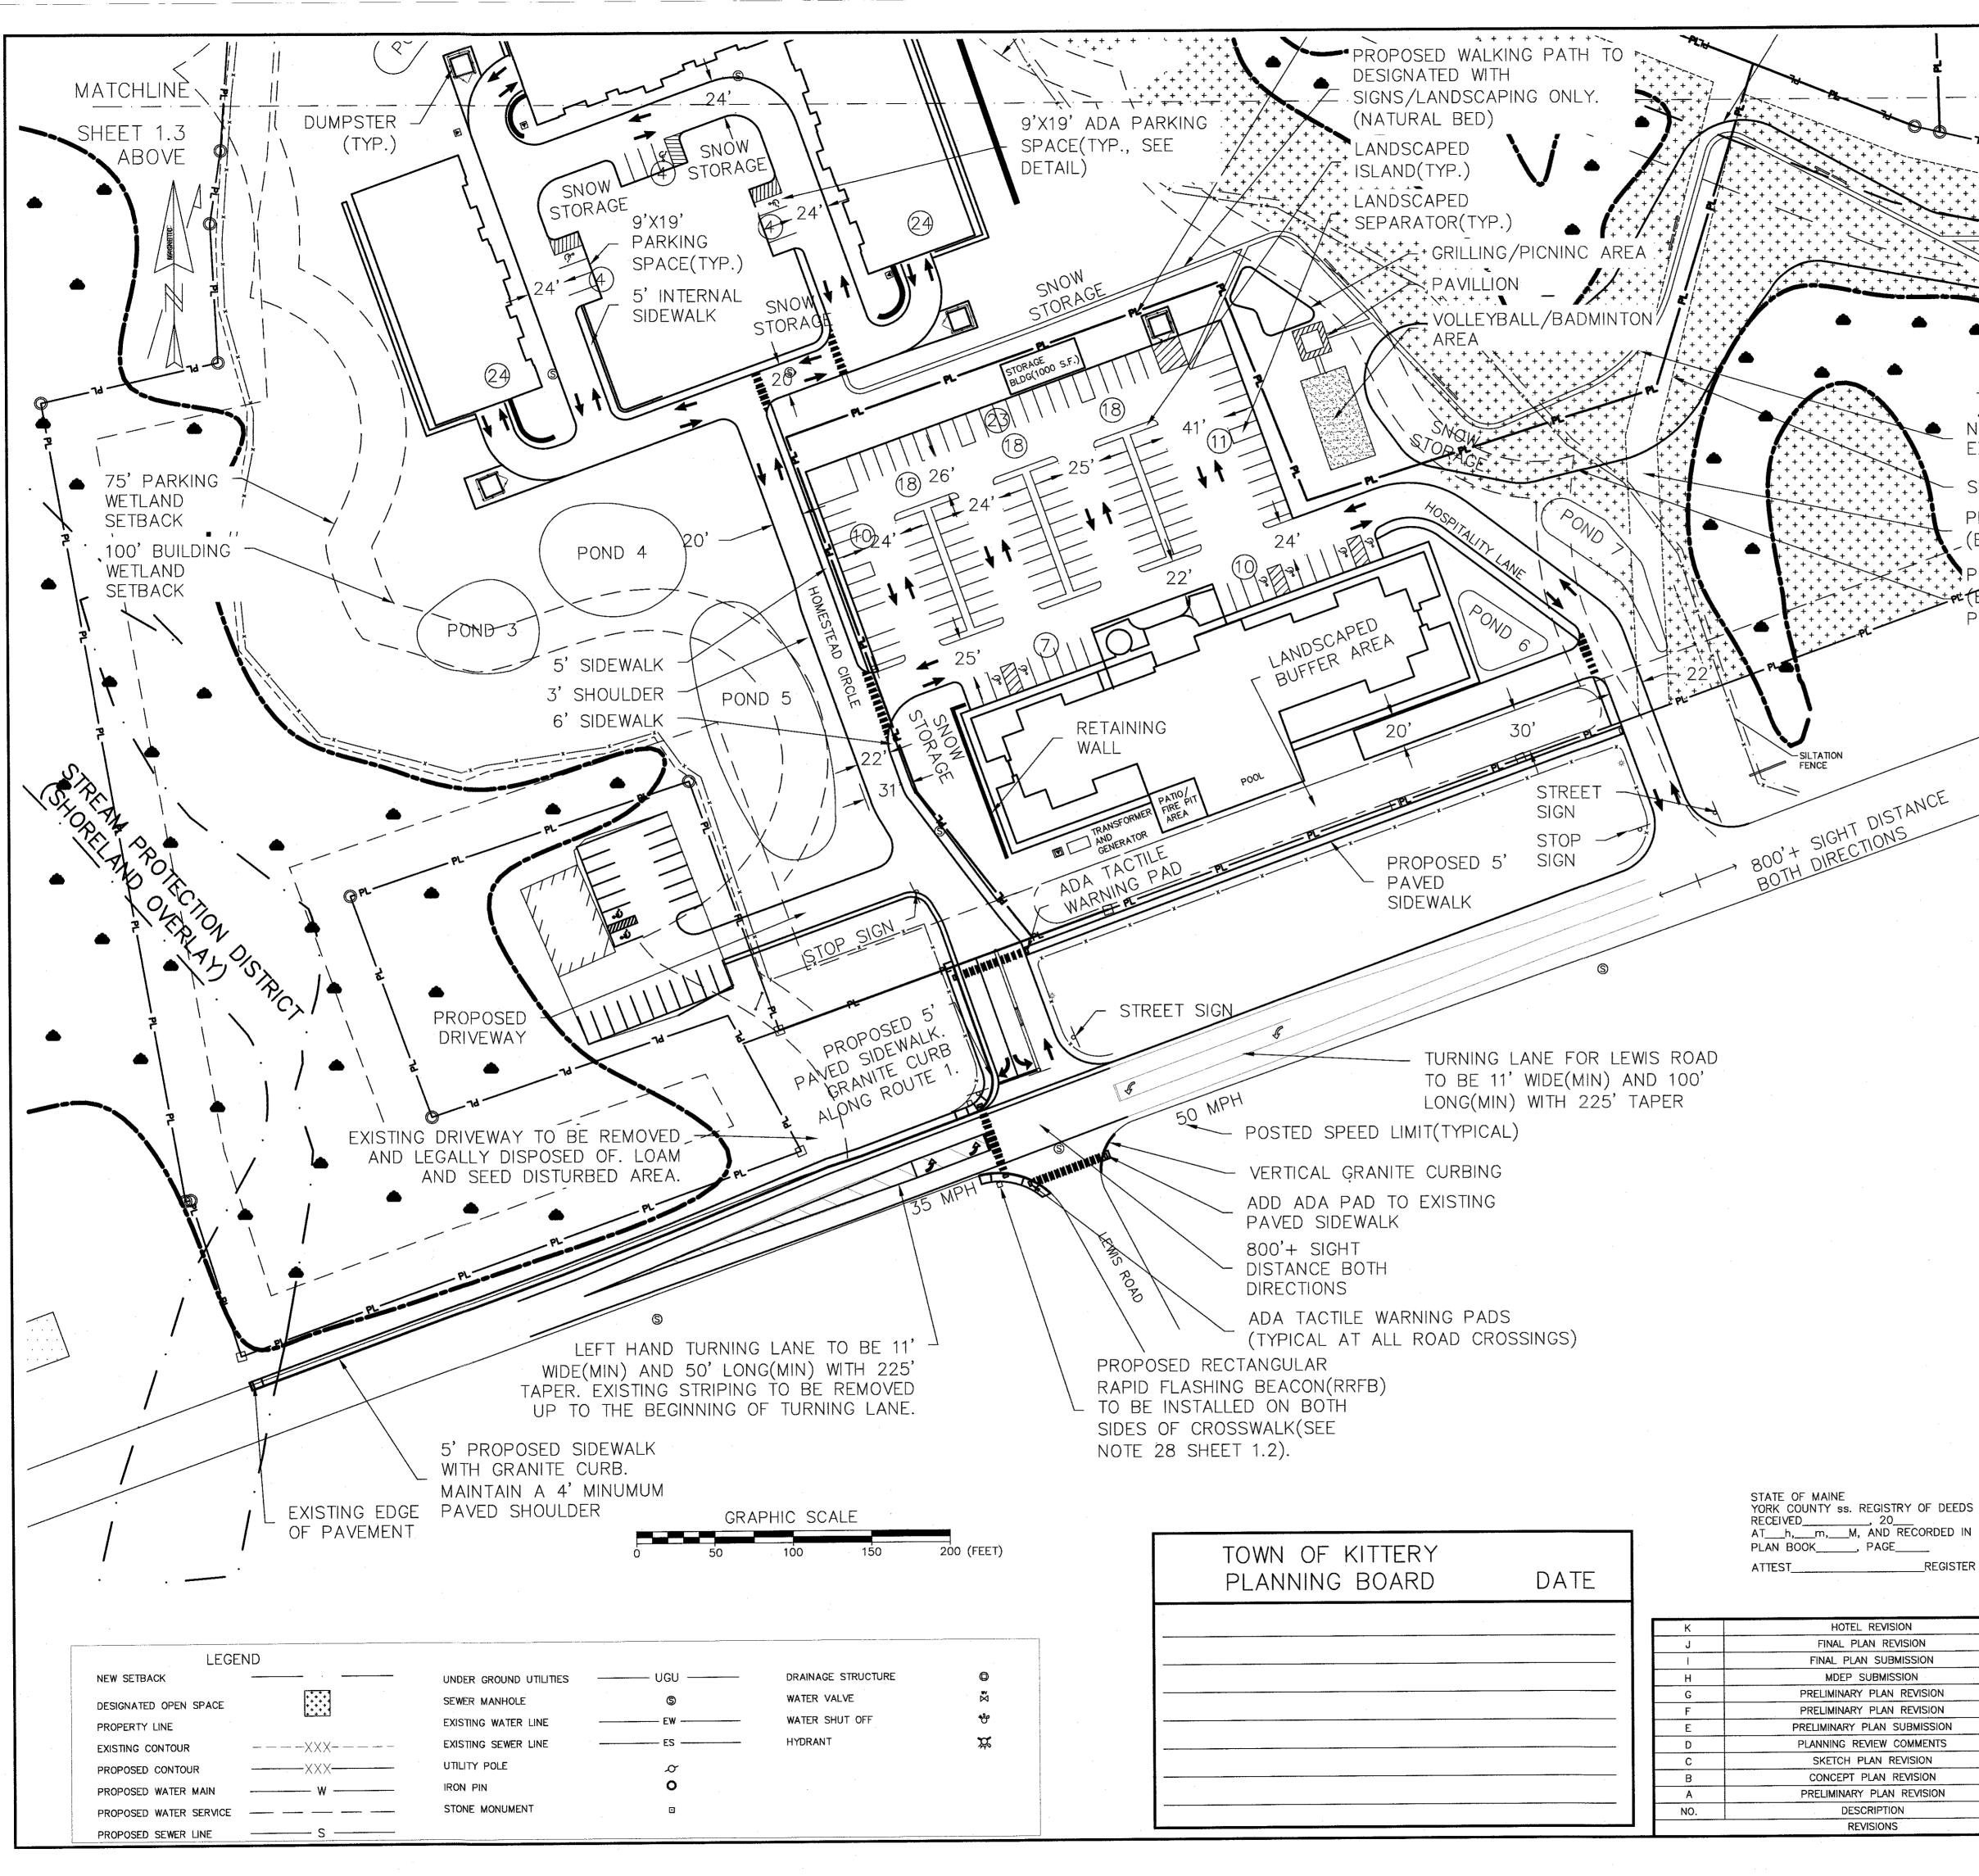

RURAL DISTRICT TRAIL NEW PATH TO CONNECT EXISTING WALKING PATH SEWER EASEMENT PRP SEWER FORCE M (BY OTHERS) PASSIVE RECREATION ARI EXISTING WALKING PATH, U.S. ROUTE PICNIC AREA, ETC.) O'T SIGHT DISTANCE d and and later PROPOSED DRIVEWAY EASEMEN 11/ DRIVEWAY EASEMENT STATE OF MAINE YORK COUNTY ss. REGISTRY OF DEEDS SITE AND SUBDIVISION 50 SCALE 1.4 ATTEST REGISTER THE HOMESTEAD 459 US ROUTE 1 KITTERY, MAINE FOR: HOTEL REVISION 11/21/2019 LANDMARK HILL, LLC 79 CONGRESS ST PORTSMOUTH, NH 03801 03/27/2019 FINAL PLAN REVISION 01/24/2019 FINAL PLAN SUBMISSION ITE OF MAIN 01/23/2019 MDEP SUBMISSION ATTAR ENGINEERING, INC. 1/08/2018 PRELIMINARY PLAN REVISION KENNETH A CIVIL STRUCTURAL MARINE 1284 STATE ROAD ELIOT, MAINE 03903 PHONE: (207)439-6023 FAX: (207)439-2128 10/18/2018 PRELIMINARY PLAN REVISION WOOD No. 5992 9/20/2018 PRELIMINARY PLAN SUBMISSION 8/9/2018 PLANNING REVIEW COMMENTS (CENSE? DRAWN BY: APPROVED BY SCALE: 7/19/2018 SKETCH PLAN REVISION BRN SONAL 1" = 50' 6/20/2018 CONCEPT PLAN REVISION **REVISION : DATE** DATE: 1/18/2018 PRELIMINARY PLAN REVISION K: 11/21/2019 1/29/2019 02/08/2018 h all DATE DESCRIPTION JOB NO: C052-18 | FILE: THE HOMESTEAD BASE | SHEET 1.4 REVISIONS TAX MAP 60, LOT 24

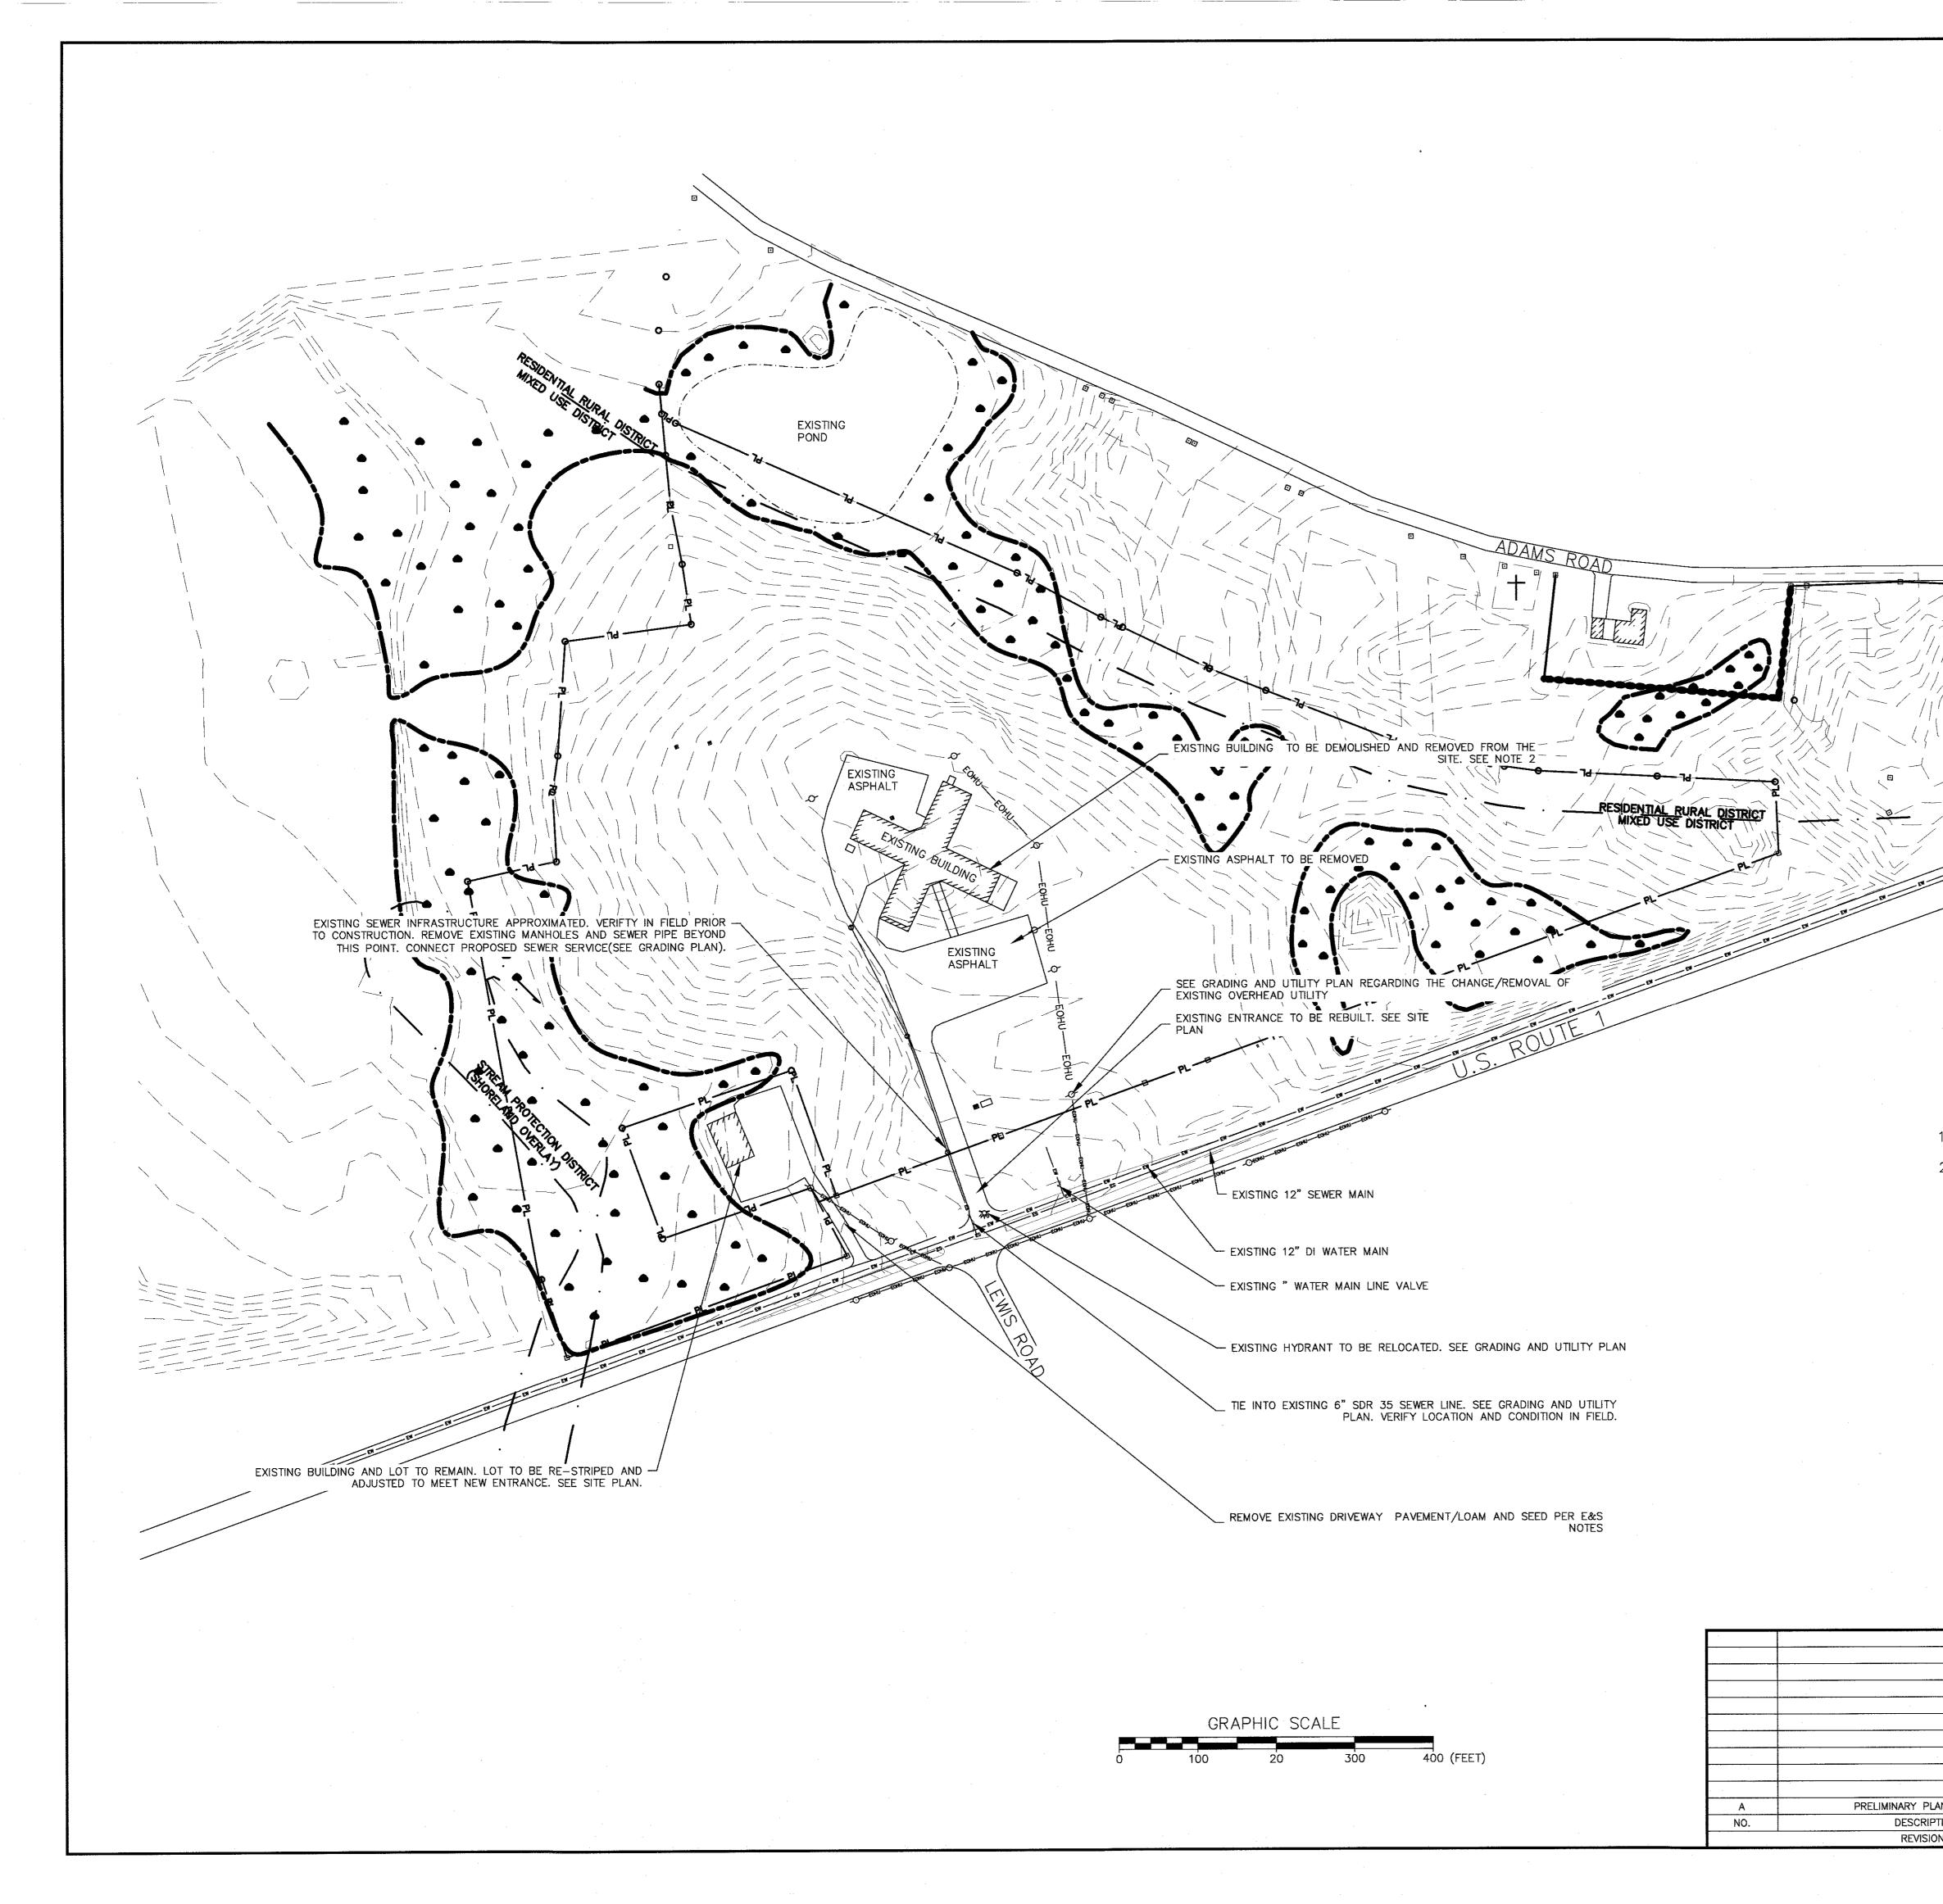




## GENERAL NOTES

 LEGAL, OFFSITE DISPOSAL OF DEMOLISHED MATERIALS SHALL BE THE RESPONSIBILITY OF THE GENERAL CONTRACTOR.
 FILLING OF EXISTING EXCAVATED AREAS AFTER DEMOLITION SHALL BE ACCOMPLISHED IN ACCORDANCE WITH PRACTICES RECOMMENDED BY A LICENSE GEOTECHNICAL ENGINEER.

		1.5		NG CONDITION THE HOMESTE ROUTE 1 KITT	AD
			-	NDMARK HILL, L 79 CONGRESS S TSMOUTH, NH O	T
				R ENGINEERI /IL ◆ STRUCTURAL ◆ ATE ROAD – ELIOT, N D7)439-6023 FAX: (	MARINE
		The second s	SCALE: 1" = 100'	APPROVED BY:	DRAWN BY: BRN
AN REVISION	5/8/2018		DATE: 1/18/2018	Stor Cal	REVISION : DATE A: 05/08/2018
TION	DATE		JOB NO: C052-18	FILE: THE HOMESTEAD E	
		· · · · · · · · · · · · · · · · · · ·			TAX MAP 60, LOT 24

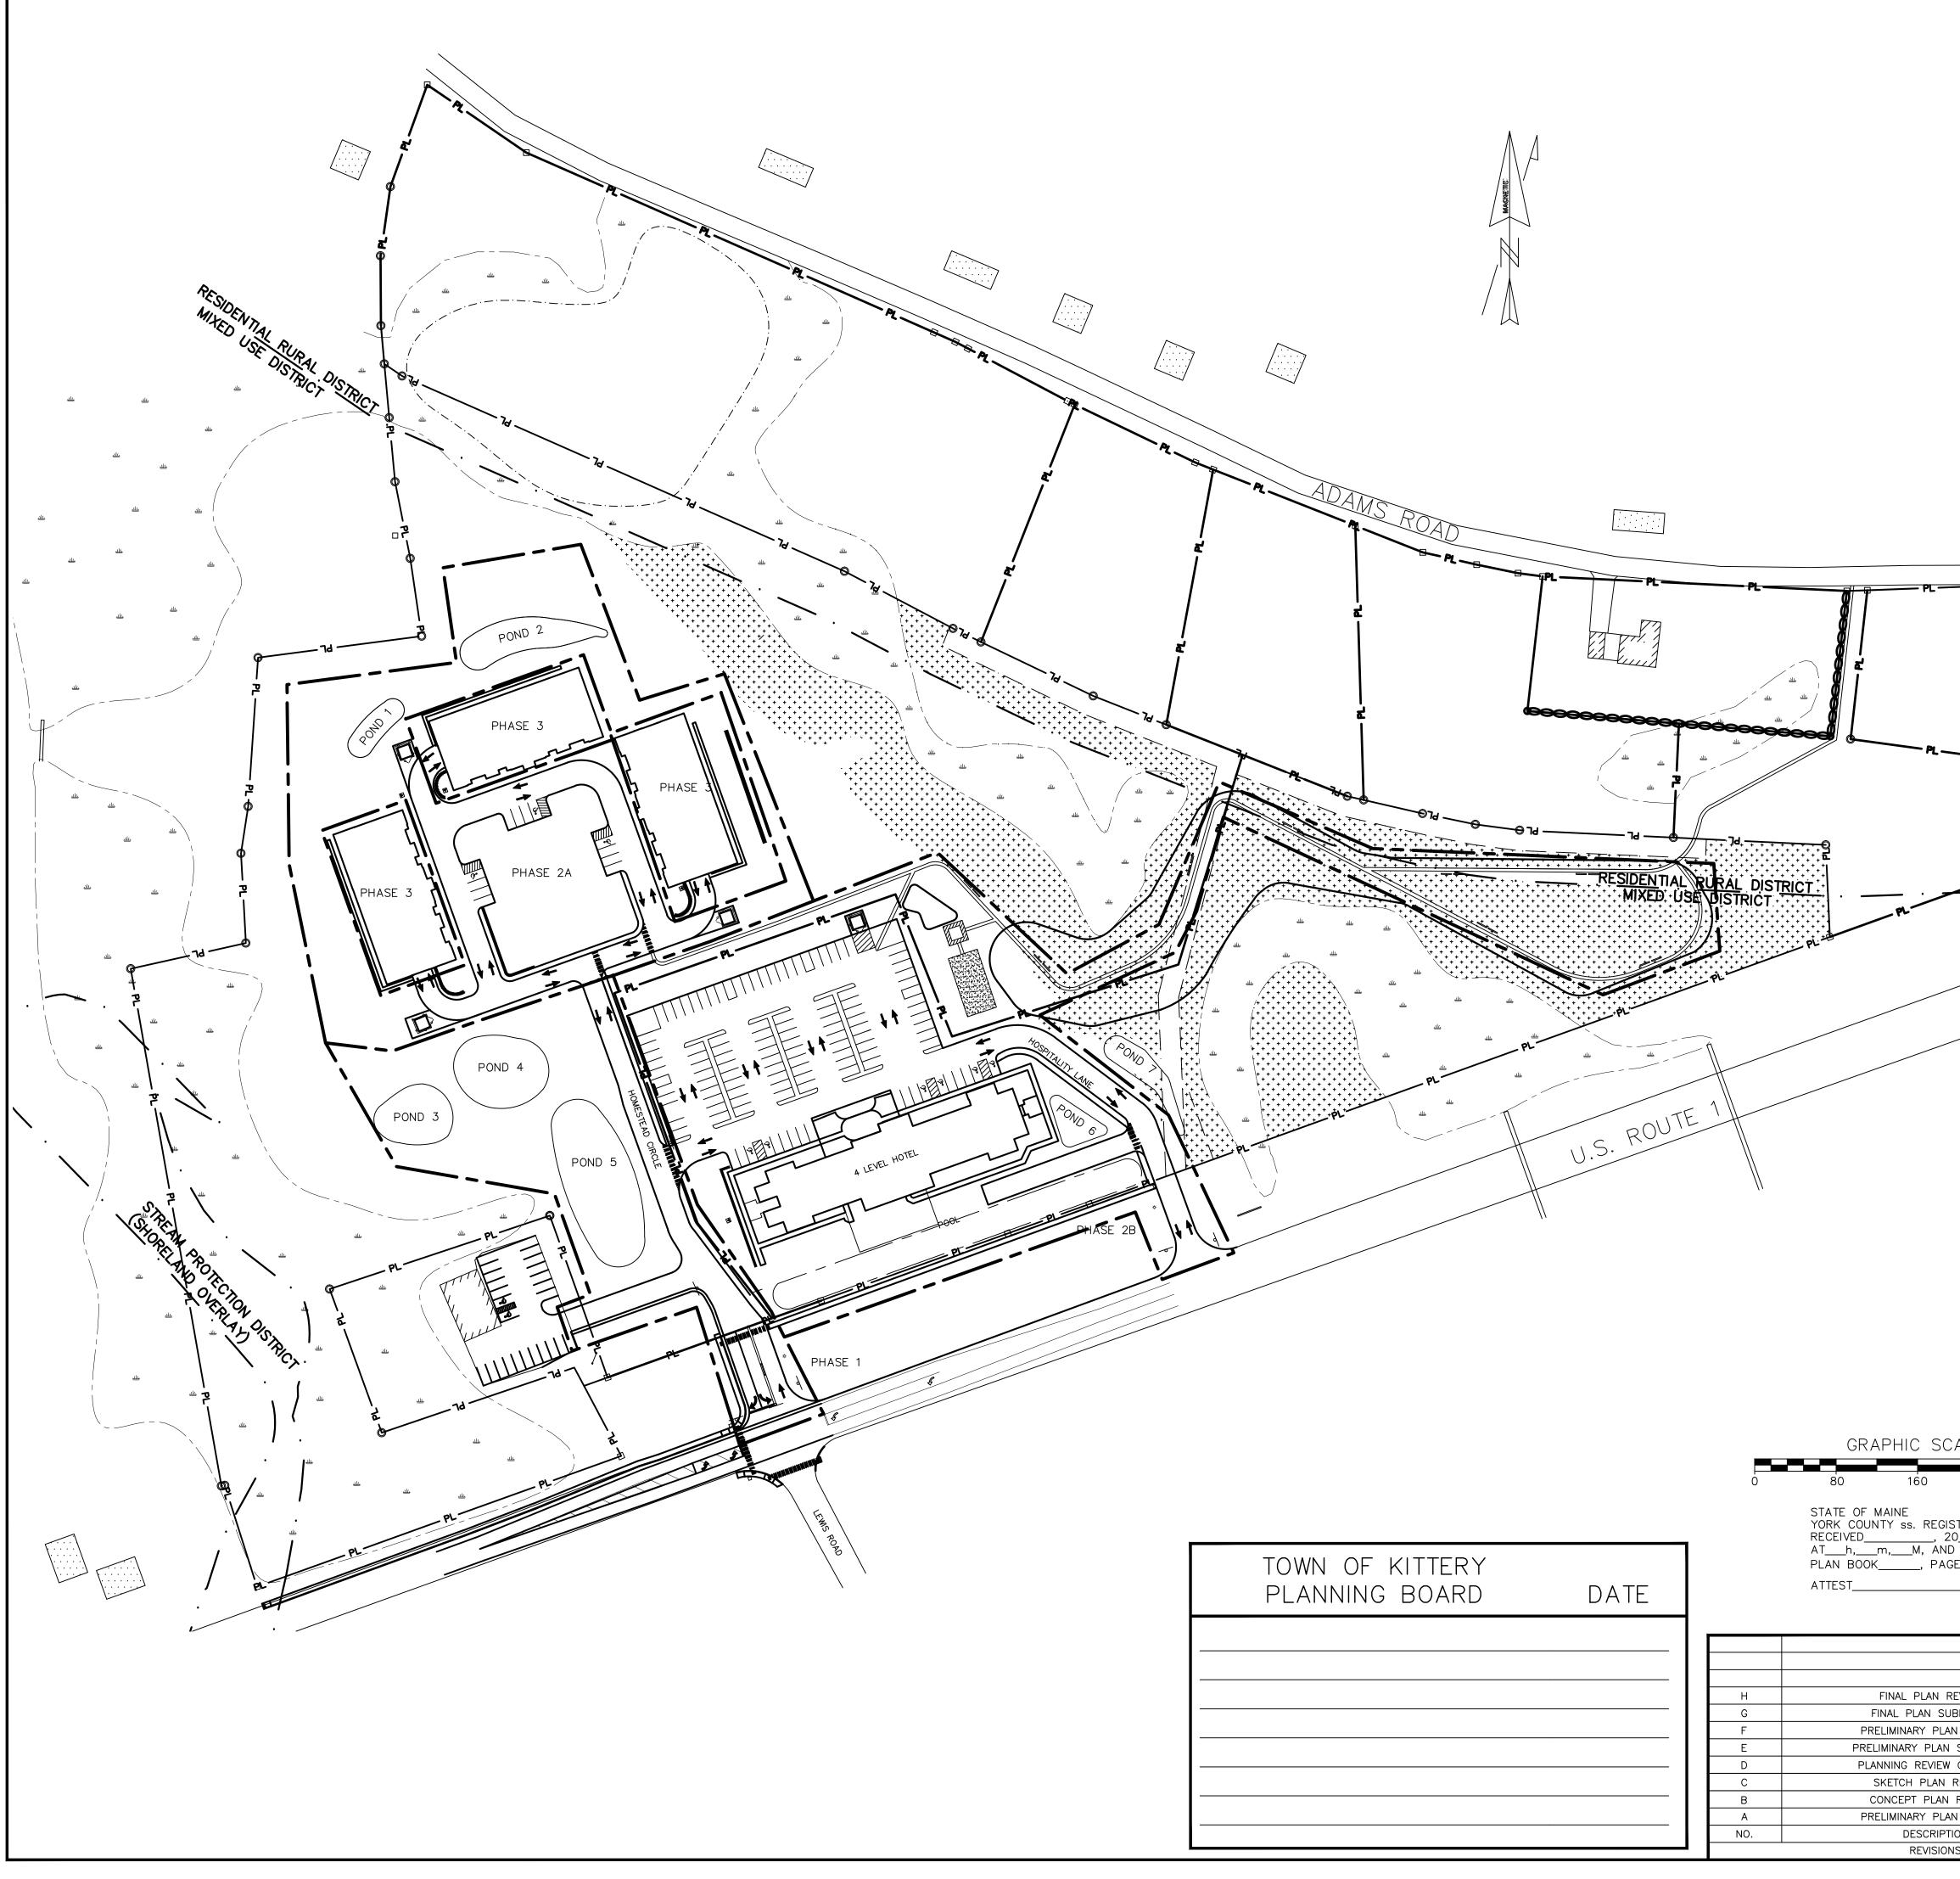

### <u>PHASING NOTES</u>

## CONSTRUCTION PHASING TO BE AS FOLLOWS:

NOTE: PHASING LINES ARE FOR PLANNING AND COORDINATION PURPOSES ONLY. THEY ARE NOT INTENDED TO DEPICT THE LIMITS OF PROPOSED CONSTRUCTION.


- 1) PHASE 1: PROPOSED ROAD, PROPOSED DRIVEWAY TO ABUTTER(OFFICE), ABUTTER PARKING LOT RE-STRIPING, WATER, SEWER, ELECTRICAL SITE CONNECTIONS, AND UNDERDRAINED SOIL FILTERS (POND 3, POND 4 AND POND 5) TO BE CONSTRUCTED.
- 2) PHASE 2A: APARTMENT BUILDING FOUNDATIONS AND UNDERDRAINED SOIL FILTERS (PONDS 1 AND 2) TO BE CONSTRUCTED. PHASE 2A AND 2B CAN OCCUR SIMULTANEOUSLY.
- 3) PHASE 2B: HOTEL, UNDERDRAINED SOIL FILTER (POND 7), LANDSCAPED BUFFER AREA AND PASSIVE RECREATION AREA TO BE CONSTRUCTED.
- 4) PHASE 3: INDIVIDUAL APARTMENT BUILDINGS TO BE CONSTRUCTED ON A SCHEDULE PROVIDED BY THE OWNER.

SCALE 240	320 (FEET)	74	DRIVEW	VEWAY SEMENT AY EASEMENT ALE: 1" = 40'	
GISTRY OF DEEDS 20 ND RECORDED IN					
AGE REGISTER		1.6		PHASING PLAN THE HOMESTEAD ROUTE 1 KITTER	
REVISION	03/27/2019	STATE OF MAMA	FOR: LA	NDMARK HILL, LLC 79 CONGRESS ST TSMOUTH, NH 0380	)1
SUBMISSION LAN REVISION AN SUBMISSION EW COMMENTS	01/24/2019 10/18/2018 9/20/2018 8/9/2018	A KENKET ALAE	CIN 1284 ST	R ENGINEERING /IL ◆ STRUCTURAL ◆ MAR ATE ROAD – ELIOT, MAINE D7)439–6023 FAX: (207	INE E 03903
N REVISION AN REVISION LAN REVISION	7/19/2018 6/20/2018 1/18/2018	The second se	SCALE: 1" = 80' DATE: 02/08/2018	APPROVED BY:	DRAWN BY: BRN REVISION : DATE H: 03/27/2019
PTION ONS	DATE		JOB NO: C052-18	FILE: THE HOMESTEAD BASE	SHEET 1.5

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-PROPOSED

TAX MAP 60, LOT 24

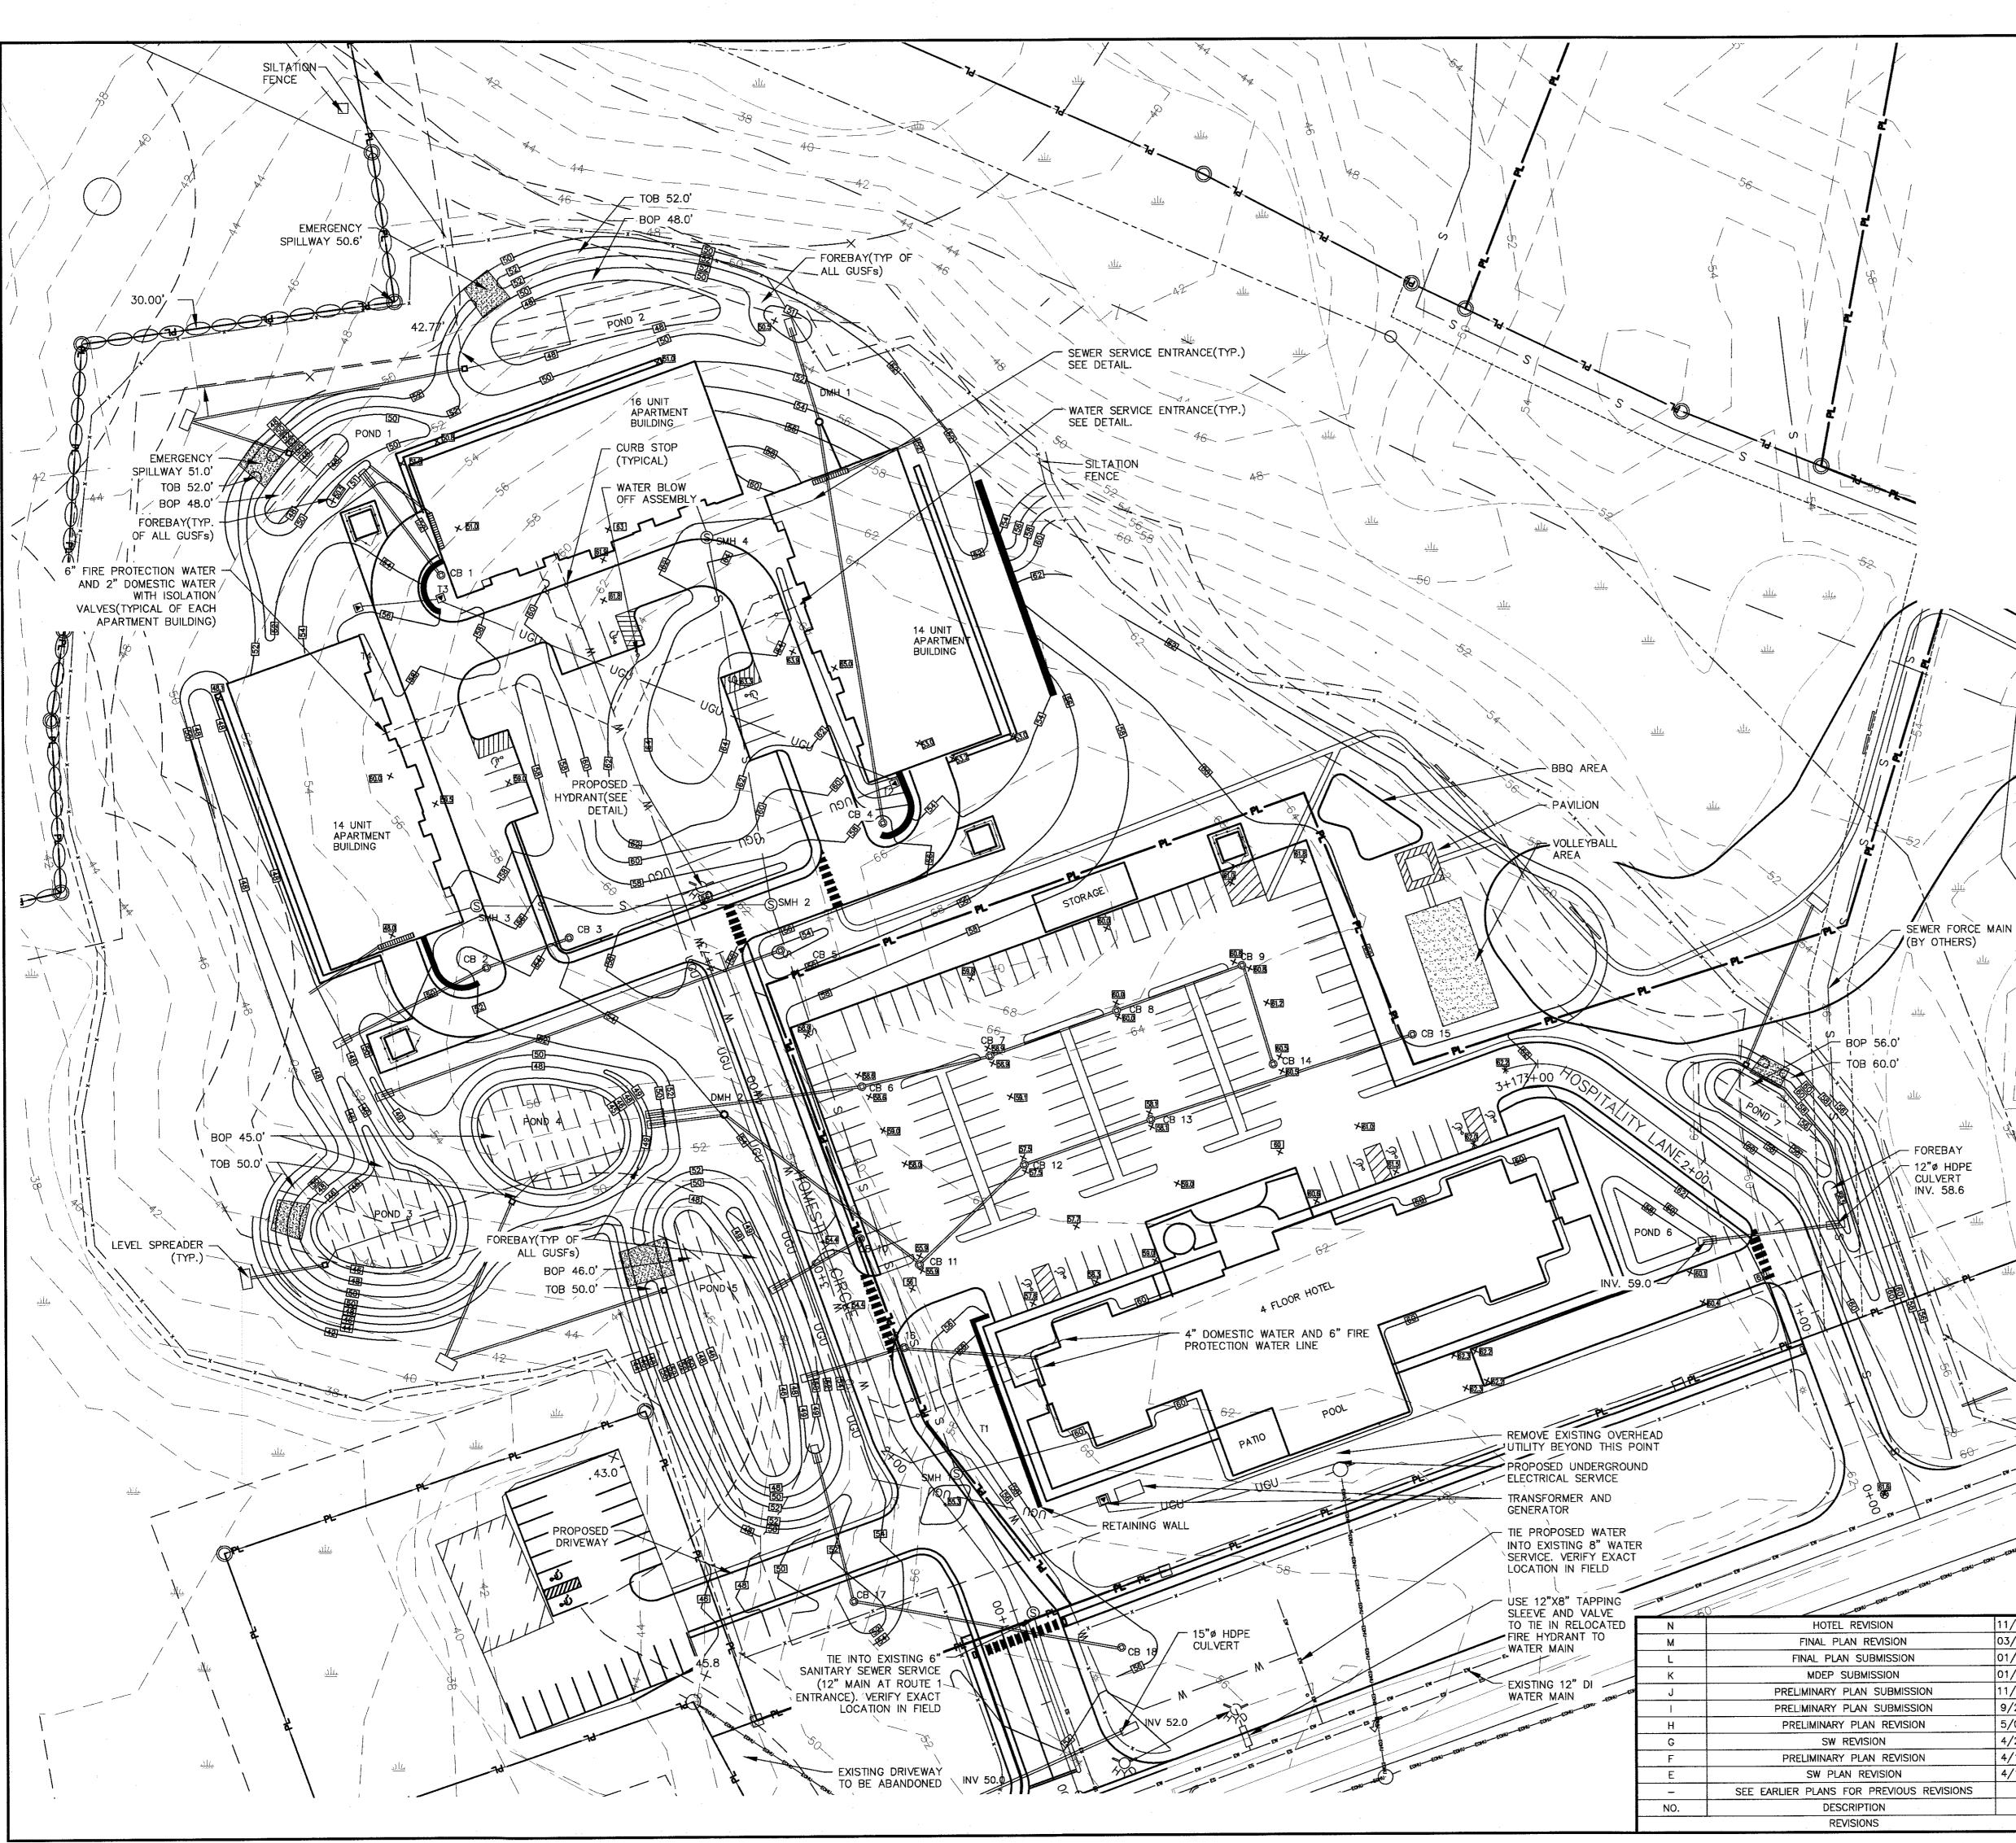

## GENERAL NOTES

1. SEWER MAINS TO BE 8" SDR 35 PVC. ALL OTHER APPURTENANCES SHALL MEET KITTERY SEWER DISTRICT STANDARDS. SEE DETAIL FOR TYPICAL INDIVIDUAL SERVICE SIZES.

2. ALL PIPES, VALVES, FITTINGS, AND CONNECTIONS SHALL MEET CURRENT KITTERY WATER DISTRICT STANDARDS.

3. ALL WATER SERVICES TO BE EQUIPPED WITH CURB STOPS.

4. ALL STORM DRAINS TO BE ADS N-12 (PE) OR APPROVED EQUAL.

5. A MINIMUM OF 5.0' OF COVER SHALL BE MAINTAINED OVER ALL WATER LINES.


6. CENTRAL MAINE POWER COMPANY WILL PREPARE THE ELECTRICAL PLAN FOR CONSTRUCTION. ALL ELECTRICAL, TELEPHONE, AND CABLE SERVICES WILL BE UNDERGROUND.

7. NEW WATER AND SEWER LINES SHALL BE TESTED IN ACCORDANCE WITH RESPECTIVE DISTRICT REQUIREMENTS.

8. EACH E & S CELL REPRESENTS A LIMITED AREA TO BE CONSTRUCTED WITH ALL EROSION & SEDIMENT CONTROL MEASURES IN PLACE. ALL "CELLS" SHALL BE PROTECTED BY EROSION & SEDIMENT CONTROL BEST MANAGEMENT PRACTICES AS REQUIRED BY THE E & S PLAN. EROSION & SEDIMENT CONTROL SHALL BE MAINTAINED FOR EACH CELL THROUGH-OUT THE COMPLETION OF THE ENTIRE PROJECT. THE CELLS SHALL BE ESTABLISHED IN THERE NUMERICAL ORDER.

DRAINAGE	STRUCTURE	SCHEDULE

DESC	RIM ELEV	INV IN	INV OUT	PIPE SIZE(IN.)		
CB 1	57.0		52.0	12		
CB 2	53.9	48.3	48.2	12		
CB 3	53.80		51.0	12		
DMH 1	53.8	50.4	50.3	12		
CB 4	57.9		51.5	12		
CB 5	53.9	_	50.8	12		
CB 6	58.5	50.9	50.8	12		
CB 7	59.4	55.0	54.9	12		
CB 8	60.0	55.7	55.6	12		
CB 9	60.8	56.6	56.5	12		
CB 10	53.9	50.6	50.5	12		
CB 11	55.8	52.8	52.7	12		
CB 12	57.3	54.3	54.2	12		
CB 13	58.0	55.1	55.0	12		
DMH 2	54.0	49.5	49.4	12		
CB 14	60.4	57.5	57.4	12		
CB 15	59.8		56.7	12		
CB 16	53.5		50.5	12		
CB 17	54.0	48.6	48.5	12		
CB 18	55.5		51.0	12		

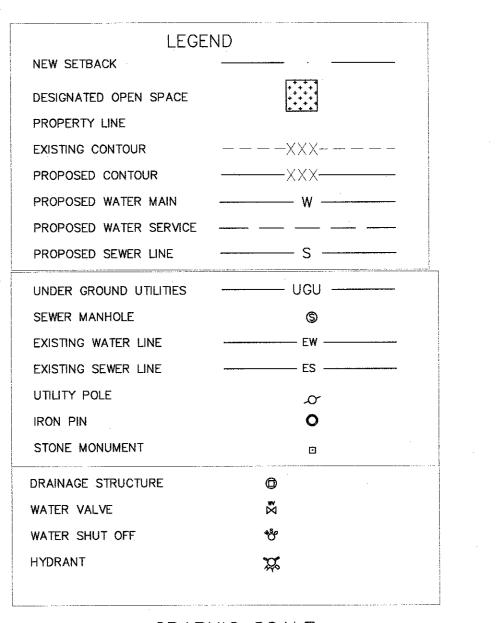

(BY OTHERS)

FOREBAY

─ 12"ø HDPE

CULVERT

INV. 58.6

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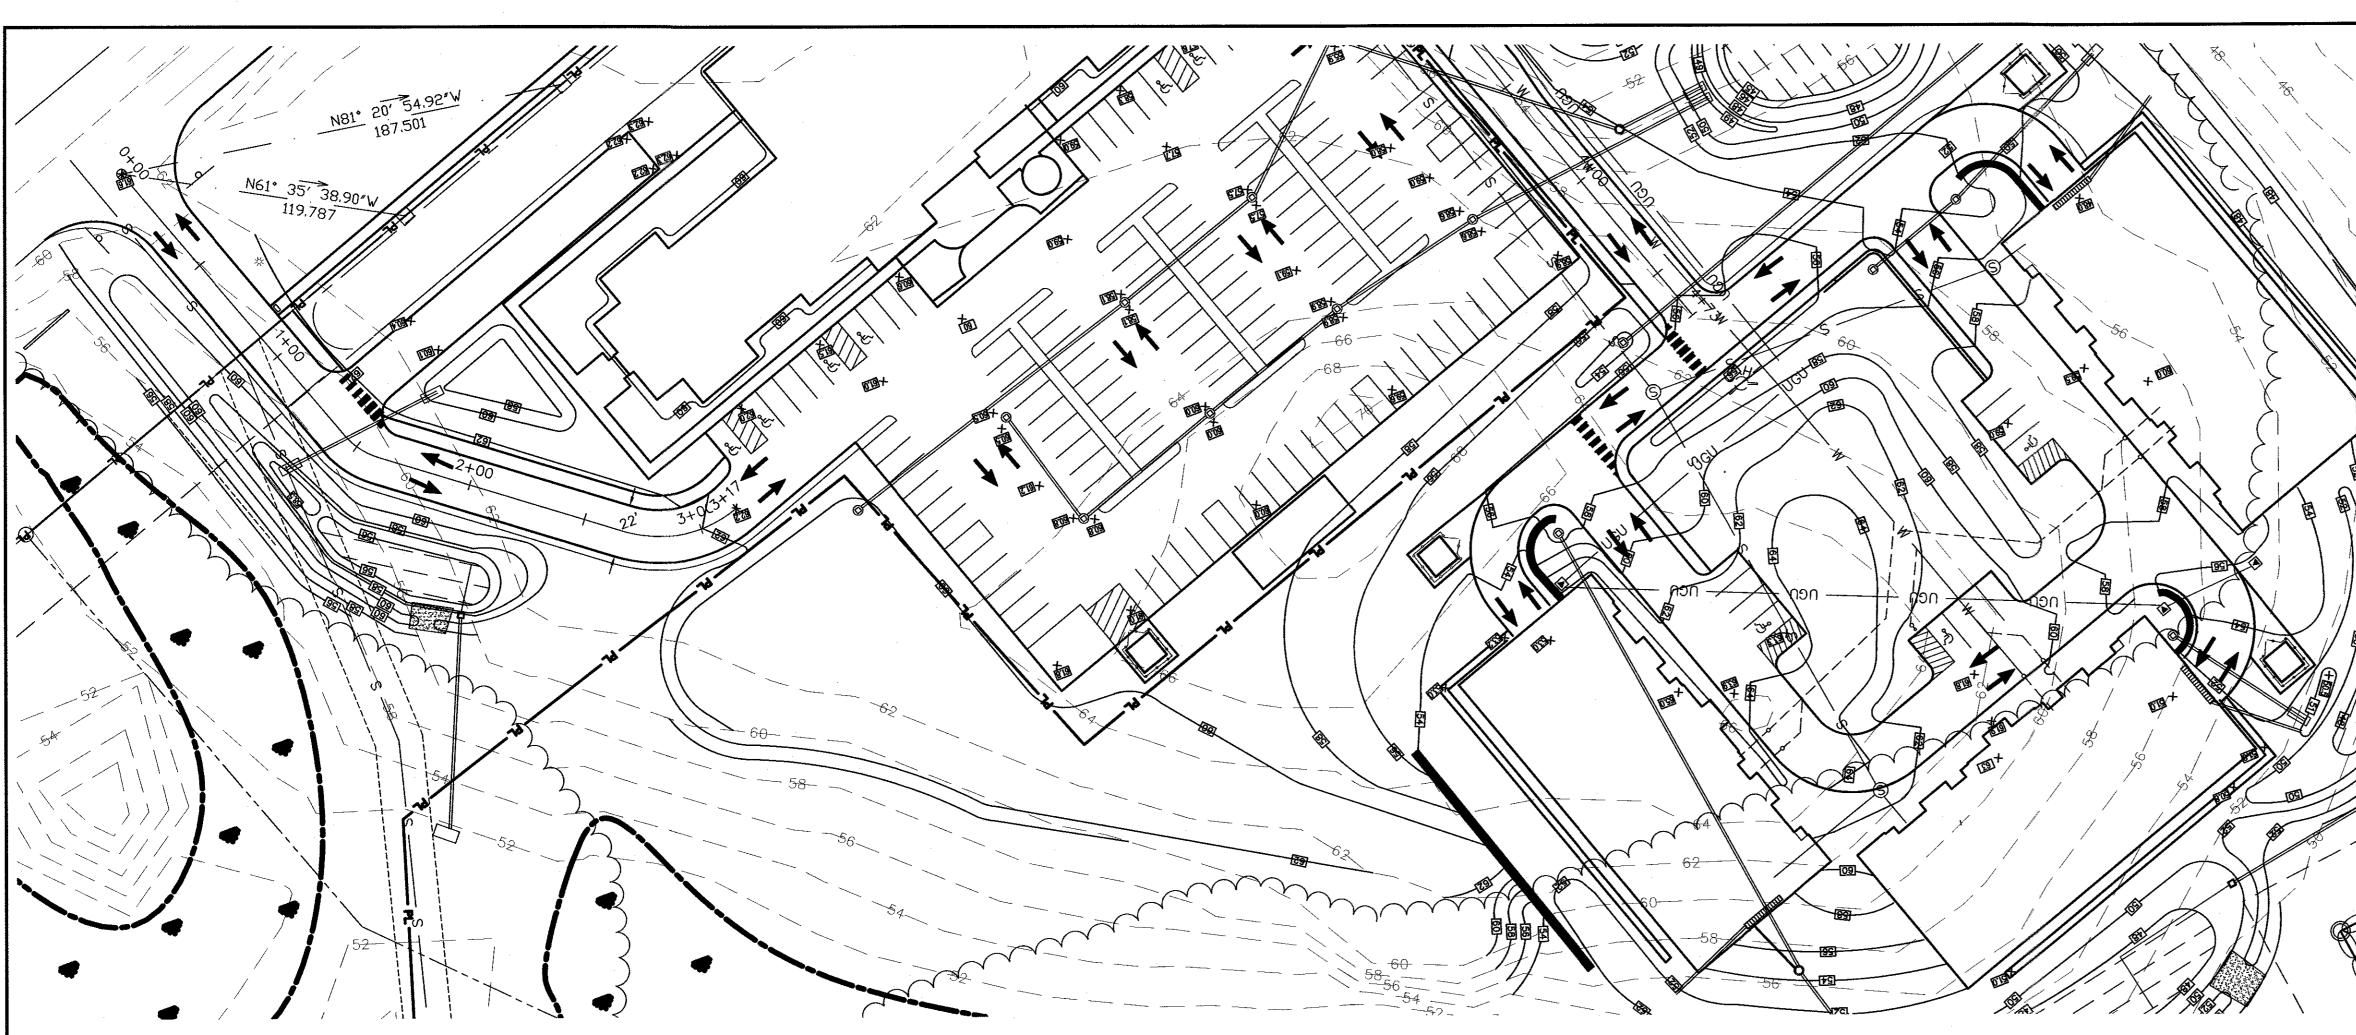
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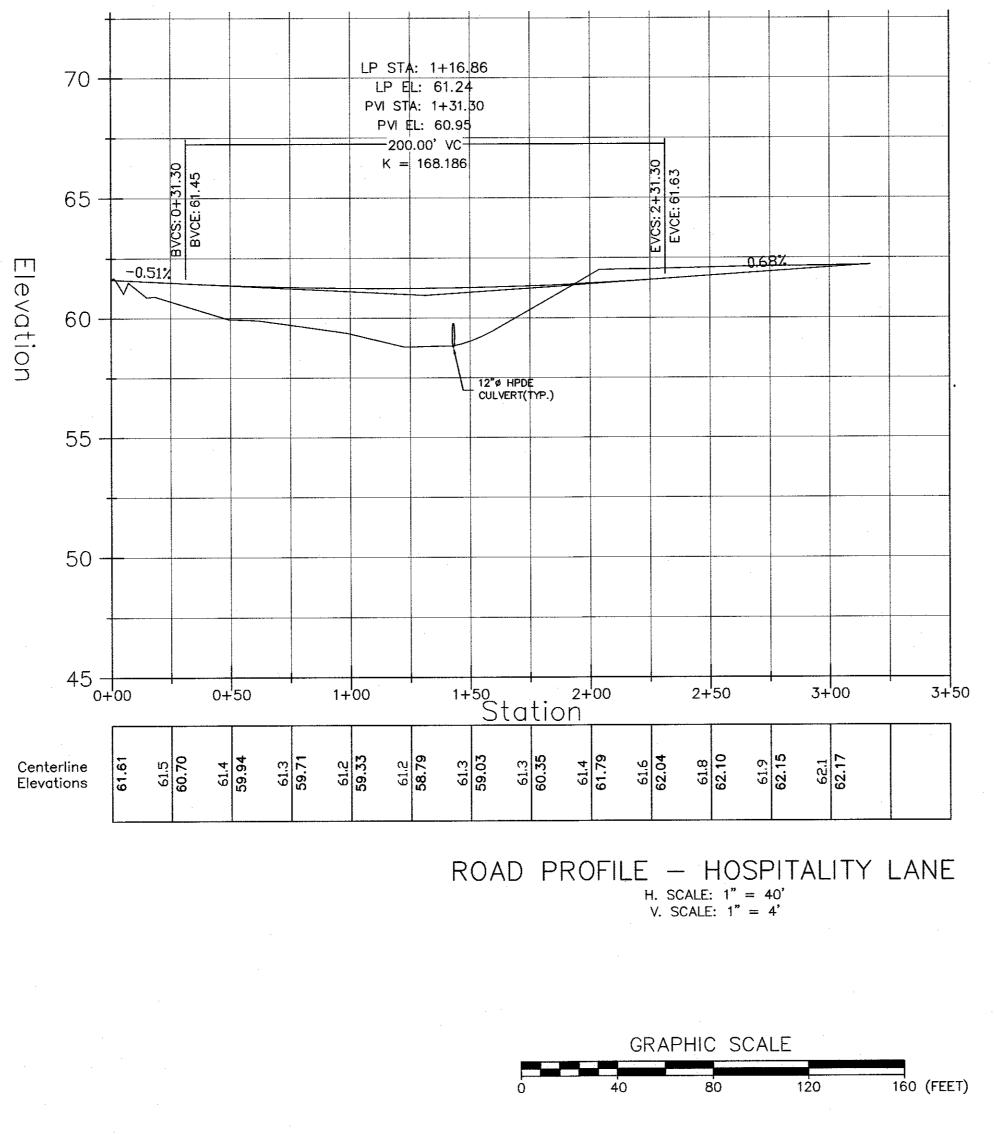
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ION	11/21/2019		FOR:	NDMARK HILL, LLC	
VISION	03/27/2019	WINTE OF Ma		79 CONGRESS ST	
MISSION	01/24/2019	ING A MARKEN AND	POR	TSMOUTH, NH 0380	71
SION	01/23/2019	KENNETH A	1885 Martin and	· · · · · · · · · · · · · · · · · · ·	
SUBMISSION	11/08/2018	EX WOOD	ATTA	R ENGINEERING	G. INC.
SUBMISSION	9/20/2018	No. 5992		/IL ♦ STRUCTURAL ♦ MAR	
REVISION	5/08/2018	KENNETH A. WOOD No. 5992	1284 ST	ATE ROAD – ELIOT, MAIN 07)439–6023   FAX: (207	E 03903
N	4/20/2018	O ENS	A \$26.54		
REVISION	4/19/2018	THURSDALL HUNN	SCALE:	APPROVED BY:	DRAWN BY:
SION	4/16/2018		1" = 40'	(h, O())	BRN
REVIOUS REVISIONS	-	$-(A_1())$	DATE: 02/08/2018	Con 44/20/2019	REVISION : DATE N: 11/21/2019
N	DATE	- un cline	JOB NO: C052-18	FILE: THE HOMESTEAD BASE	SHEET 2.1
			000 110 0002 10		


TAX MAP 60, LOT 24







ROAD DESIGN NOTES 1) TOTAL ROAD LENGTH OF HOMESTEAD CIRCLE IS: 473' 2) TOTAL ROAD LENGTH OF HOSPITALITY LANE IS: 317'

	· · · · · · · · · · · · · · · · · · ·
М	HOTEL REVISION
L	FINAL PLAN REVISION
K	FINAL PLAN SUBMISSION
J	MDEP SUBMISSION
ł	PRELIMINARY PLAN SUBMISSI
Н	PRELIMINARY PLAN REVISIO
G	SW REVISION
F	PRELIMINARY PLAN REVISIO
E	SW PLAN REVISION
D	PRELIMINARY PLAN REVISIO
С	SW POND ADJUSTMENT
NO.	DESCRIPTION
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AD AD	
	ROAD PLAN AND PROFILE
3.2	THE HOMESTEAD 459 US ROUTE 1 KITTERY, MAINE
11/21/2019 03/27/2019	
01/24/2019	FOR: LANDMARK HILL, LLC 79 CONGRESS ST PORTSMOUTH, NH 03801
01/23/2019 9/20/2018 5/08/2018 4/19/2018 4/16/2018 03/27/2018	ATTAR ENGINEERING, INC. CIVIL • STRUCTURAL • MARINE 1284 STATE ROAD - ELIOT, MAINE 03903 PHONE: (207)439-6023 FAX: (207)439-2128
	PHONE: $(207)439-6023$ FAX: $(207)439-2128$ SCALE:         APPROVED BY:         DRAWN BY:           1" = 40'         BRN
02/08/2018 02/06/2018 DATE	DATE: 02/08/2018 DATE: 02/08/2018 DATE: 02/08/2018
	JOB NO: C052-18 FILE: THE HOMESTEAD BASE SHEET 3.2 TAX MAP 60, LOT 24

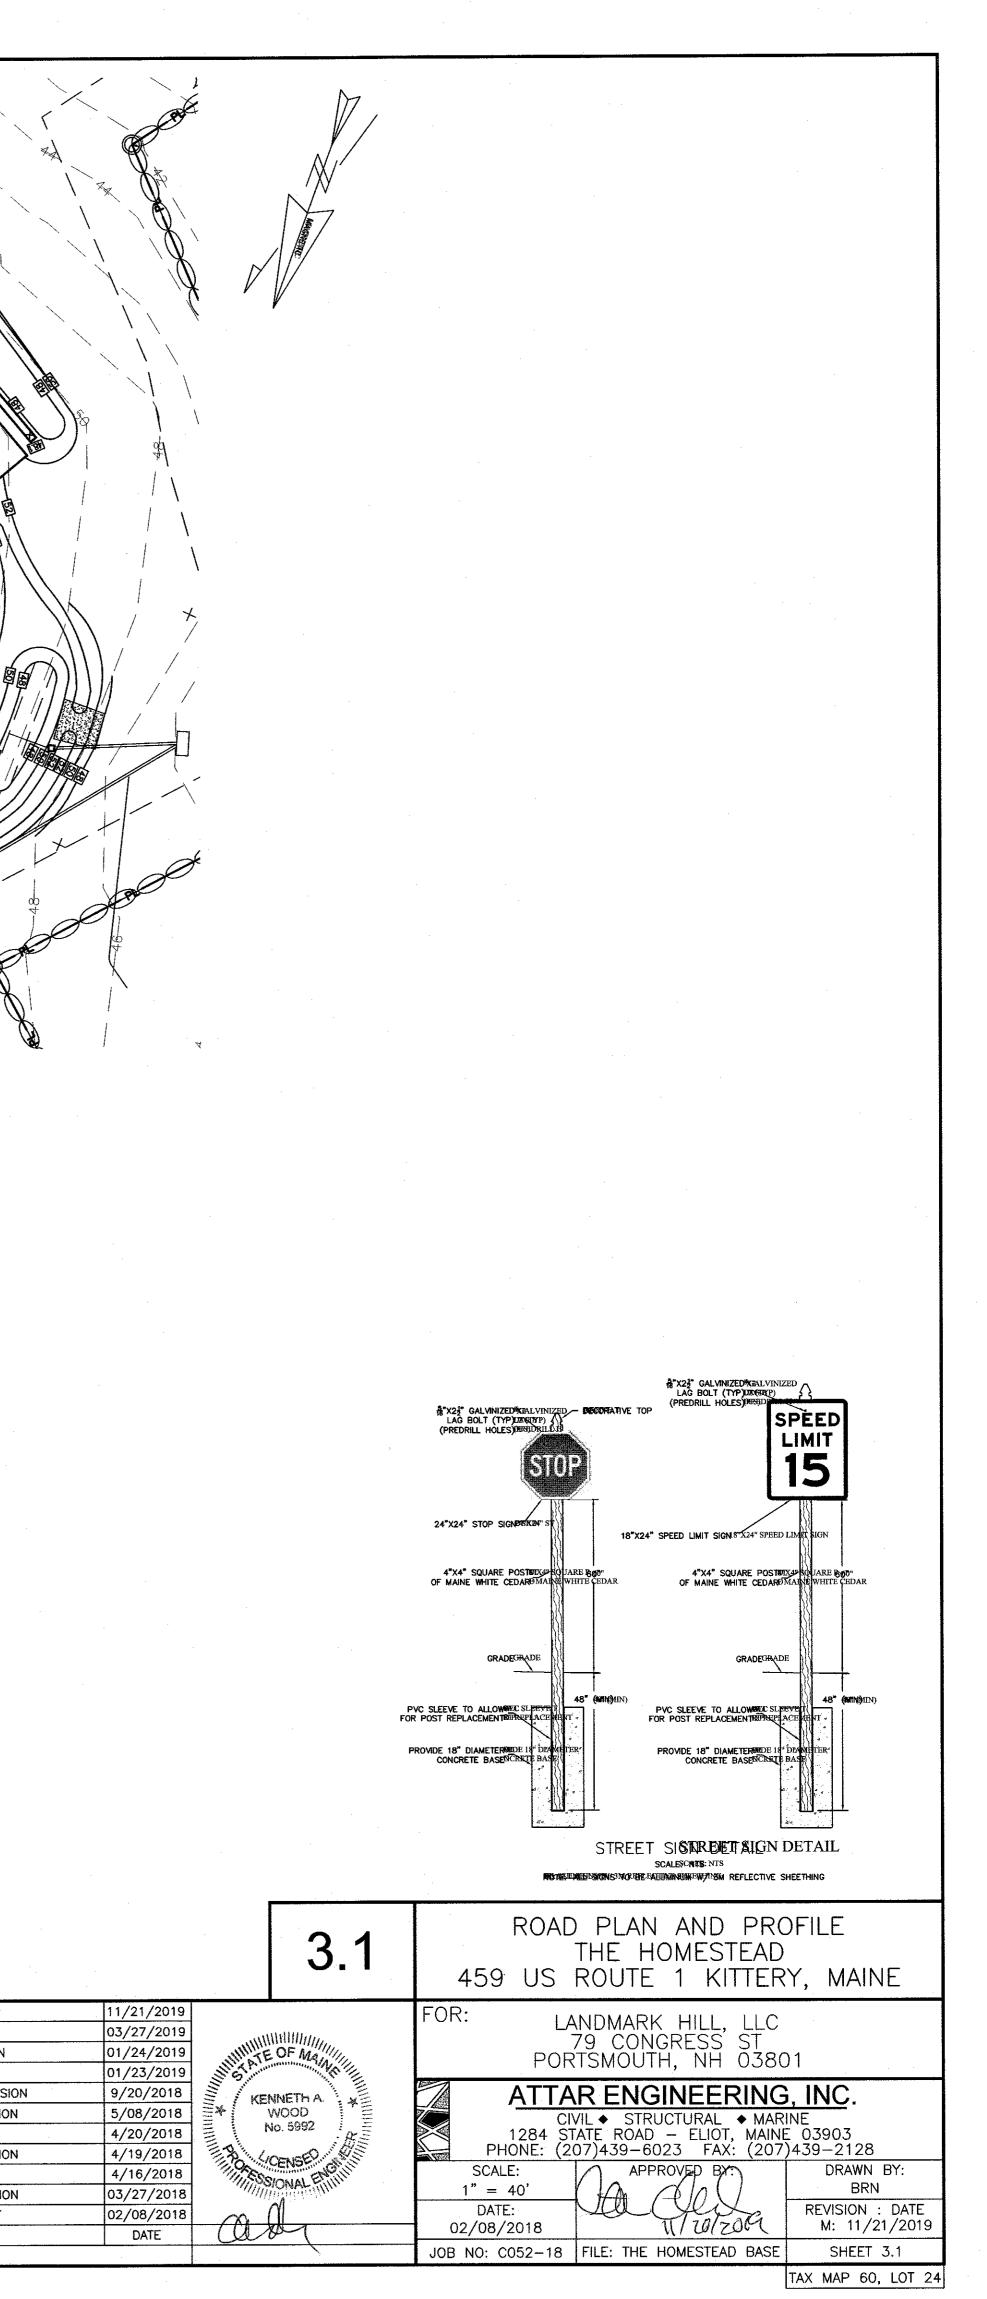
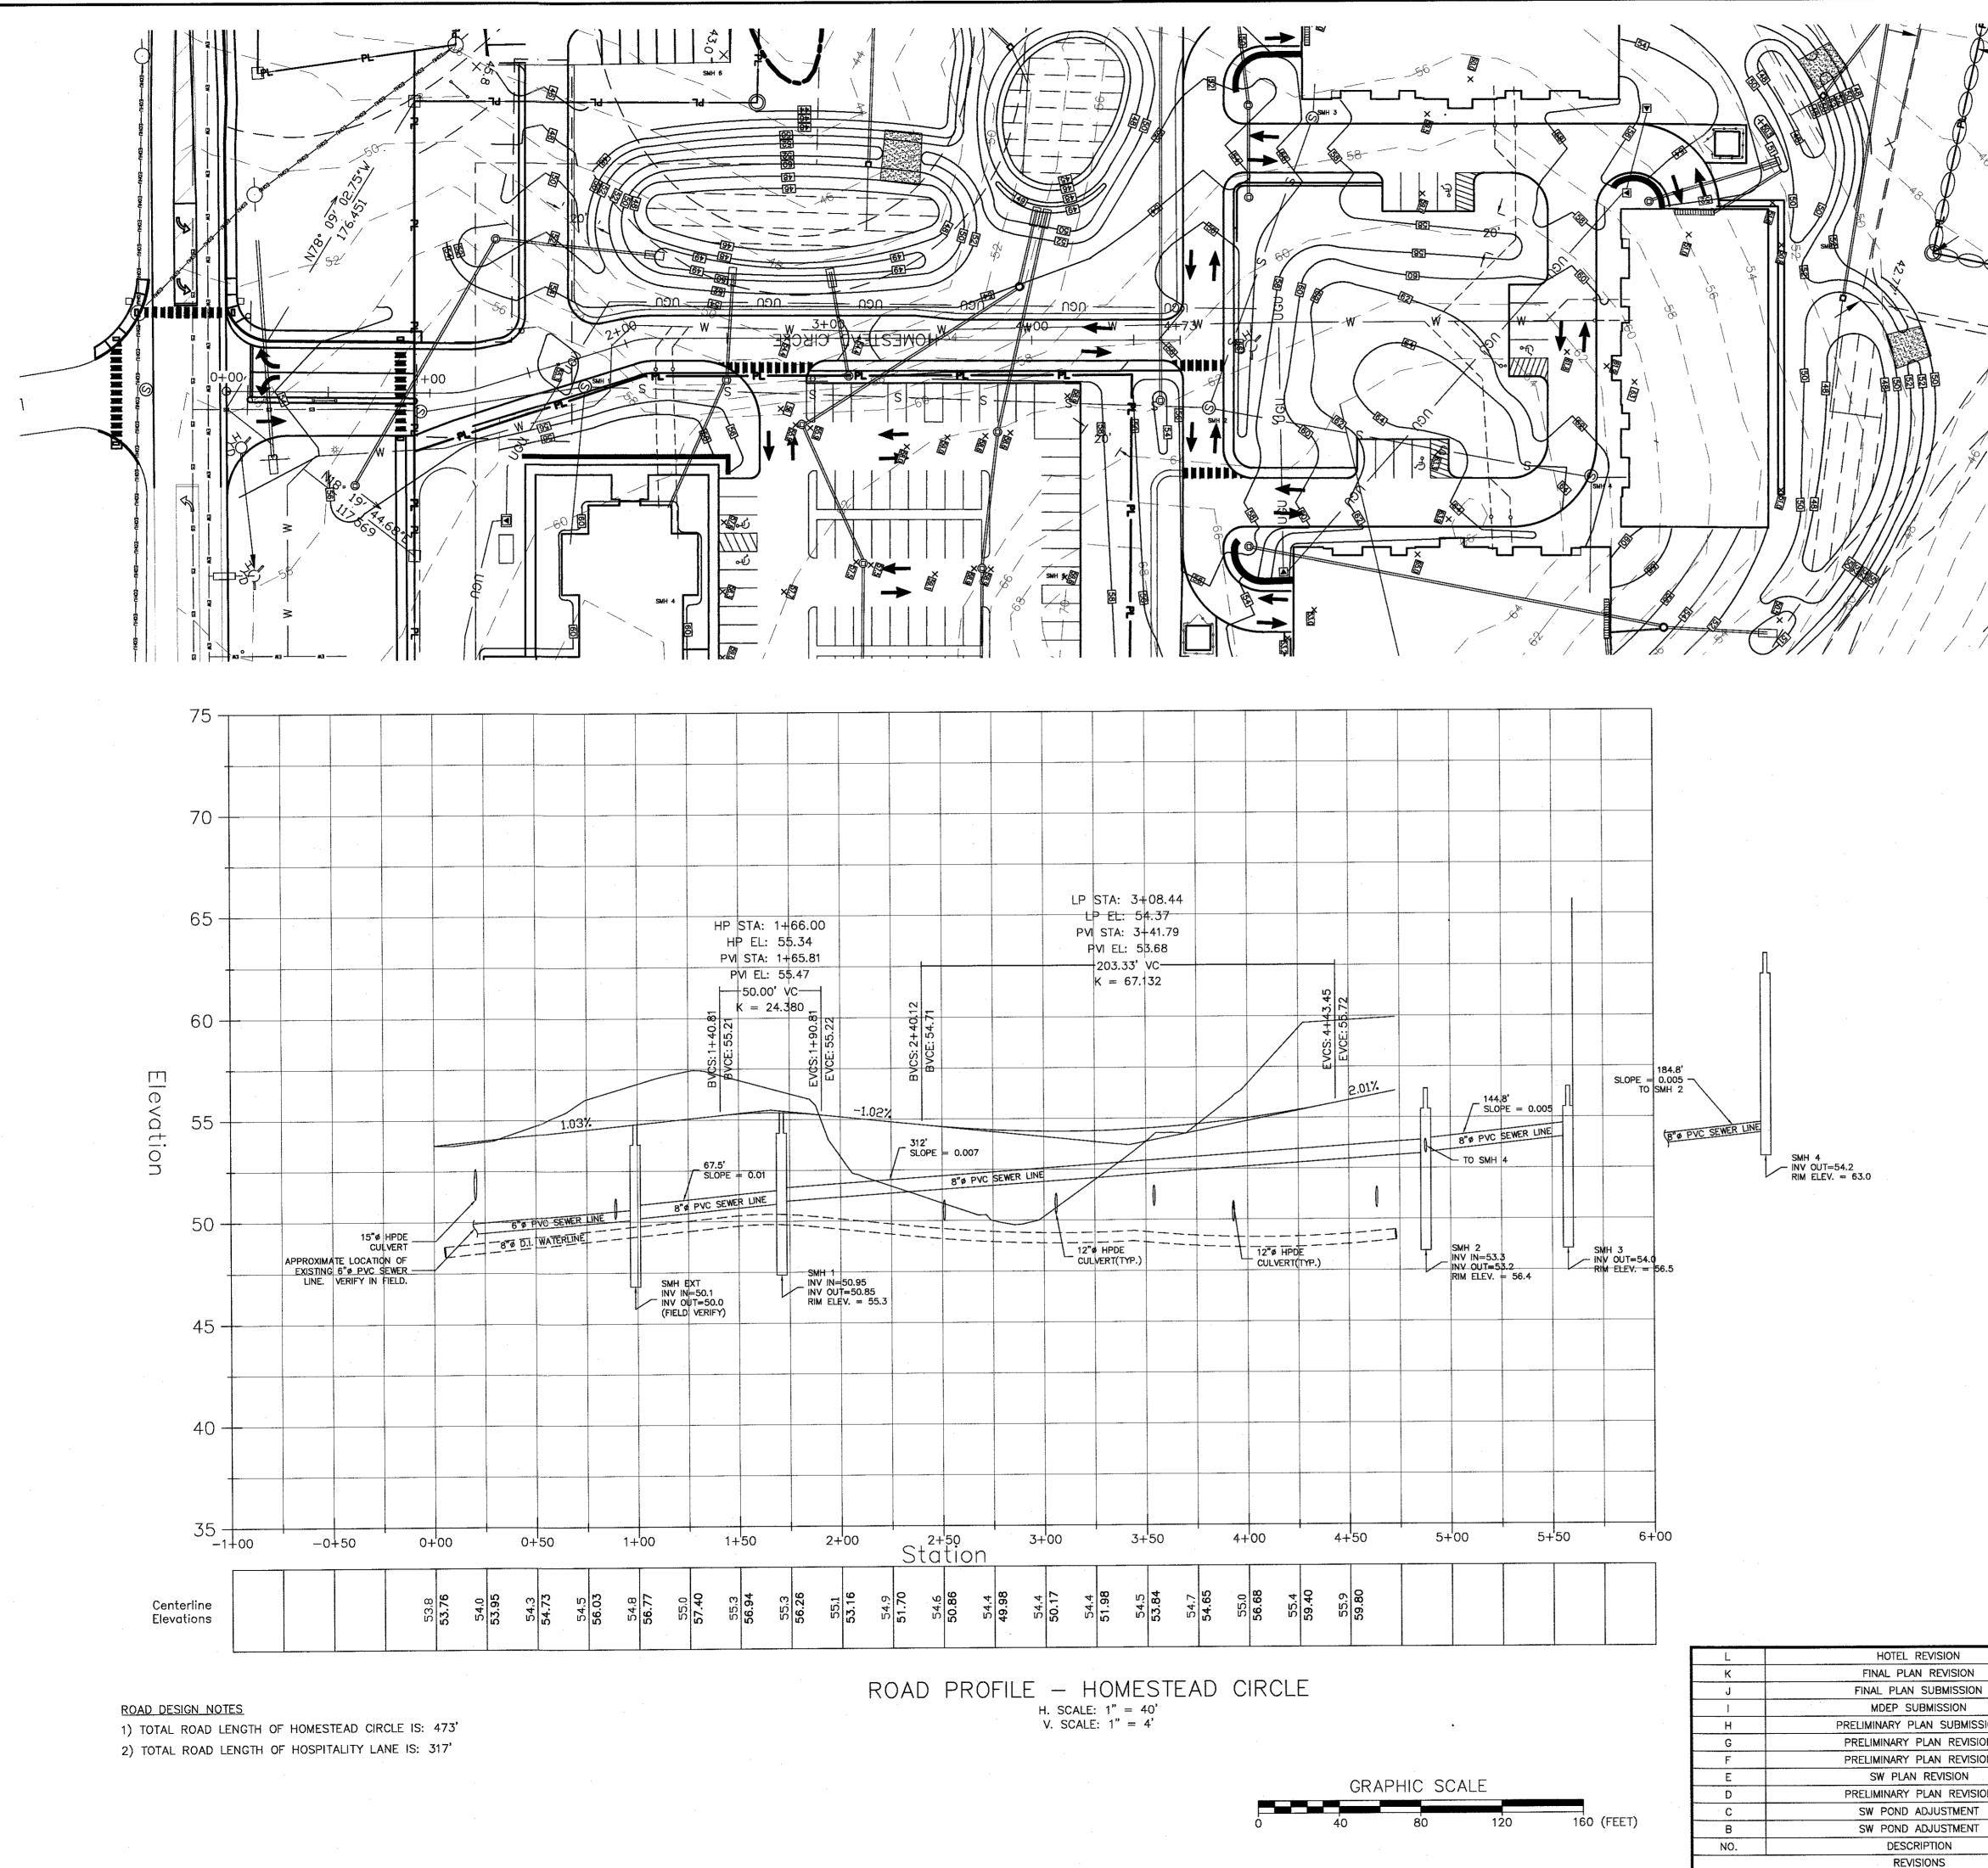
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MA	
MAGNETIC	
	SYMBOL SOIL SERIES
	Bm BIDDEFORD MUCKY PEAT*
/ 八	BIDDEFORD—SCANTIC COMPLEX, FILLED AND DITCHED*
	DANI DEVELOPED AREA NOT INVESTIGATED
	Dx DIXFIELD FINE SANDY LOAM
	Em ELMWOOD VERY FINE SANDY LOAM
	LT LYMAN-TUNBRIDGE COMPLEX
	Sc SCANTIC SILT LOAM*
	SW SWANTON VERY FINE SANDY LOAM
	Ws WESTBURY FINE SANDY LOAM
	* WETLAND SOILS
	SOIL BOUNDARY
	SOIL/WETLANDBOUNDARY
	SOIL BORING 🗢
	SLOPE LEGEND
	(NONE) 0 – 3%
	B 3 – 8%
	C 8 - 15%
	D 15 - 25%

## GENERAL NOTES

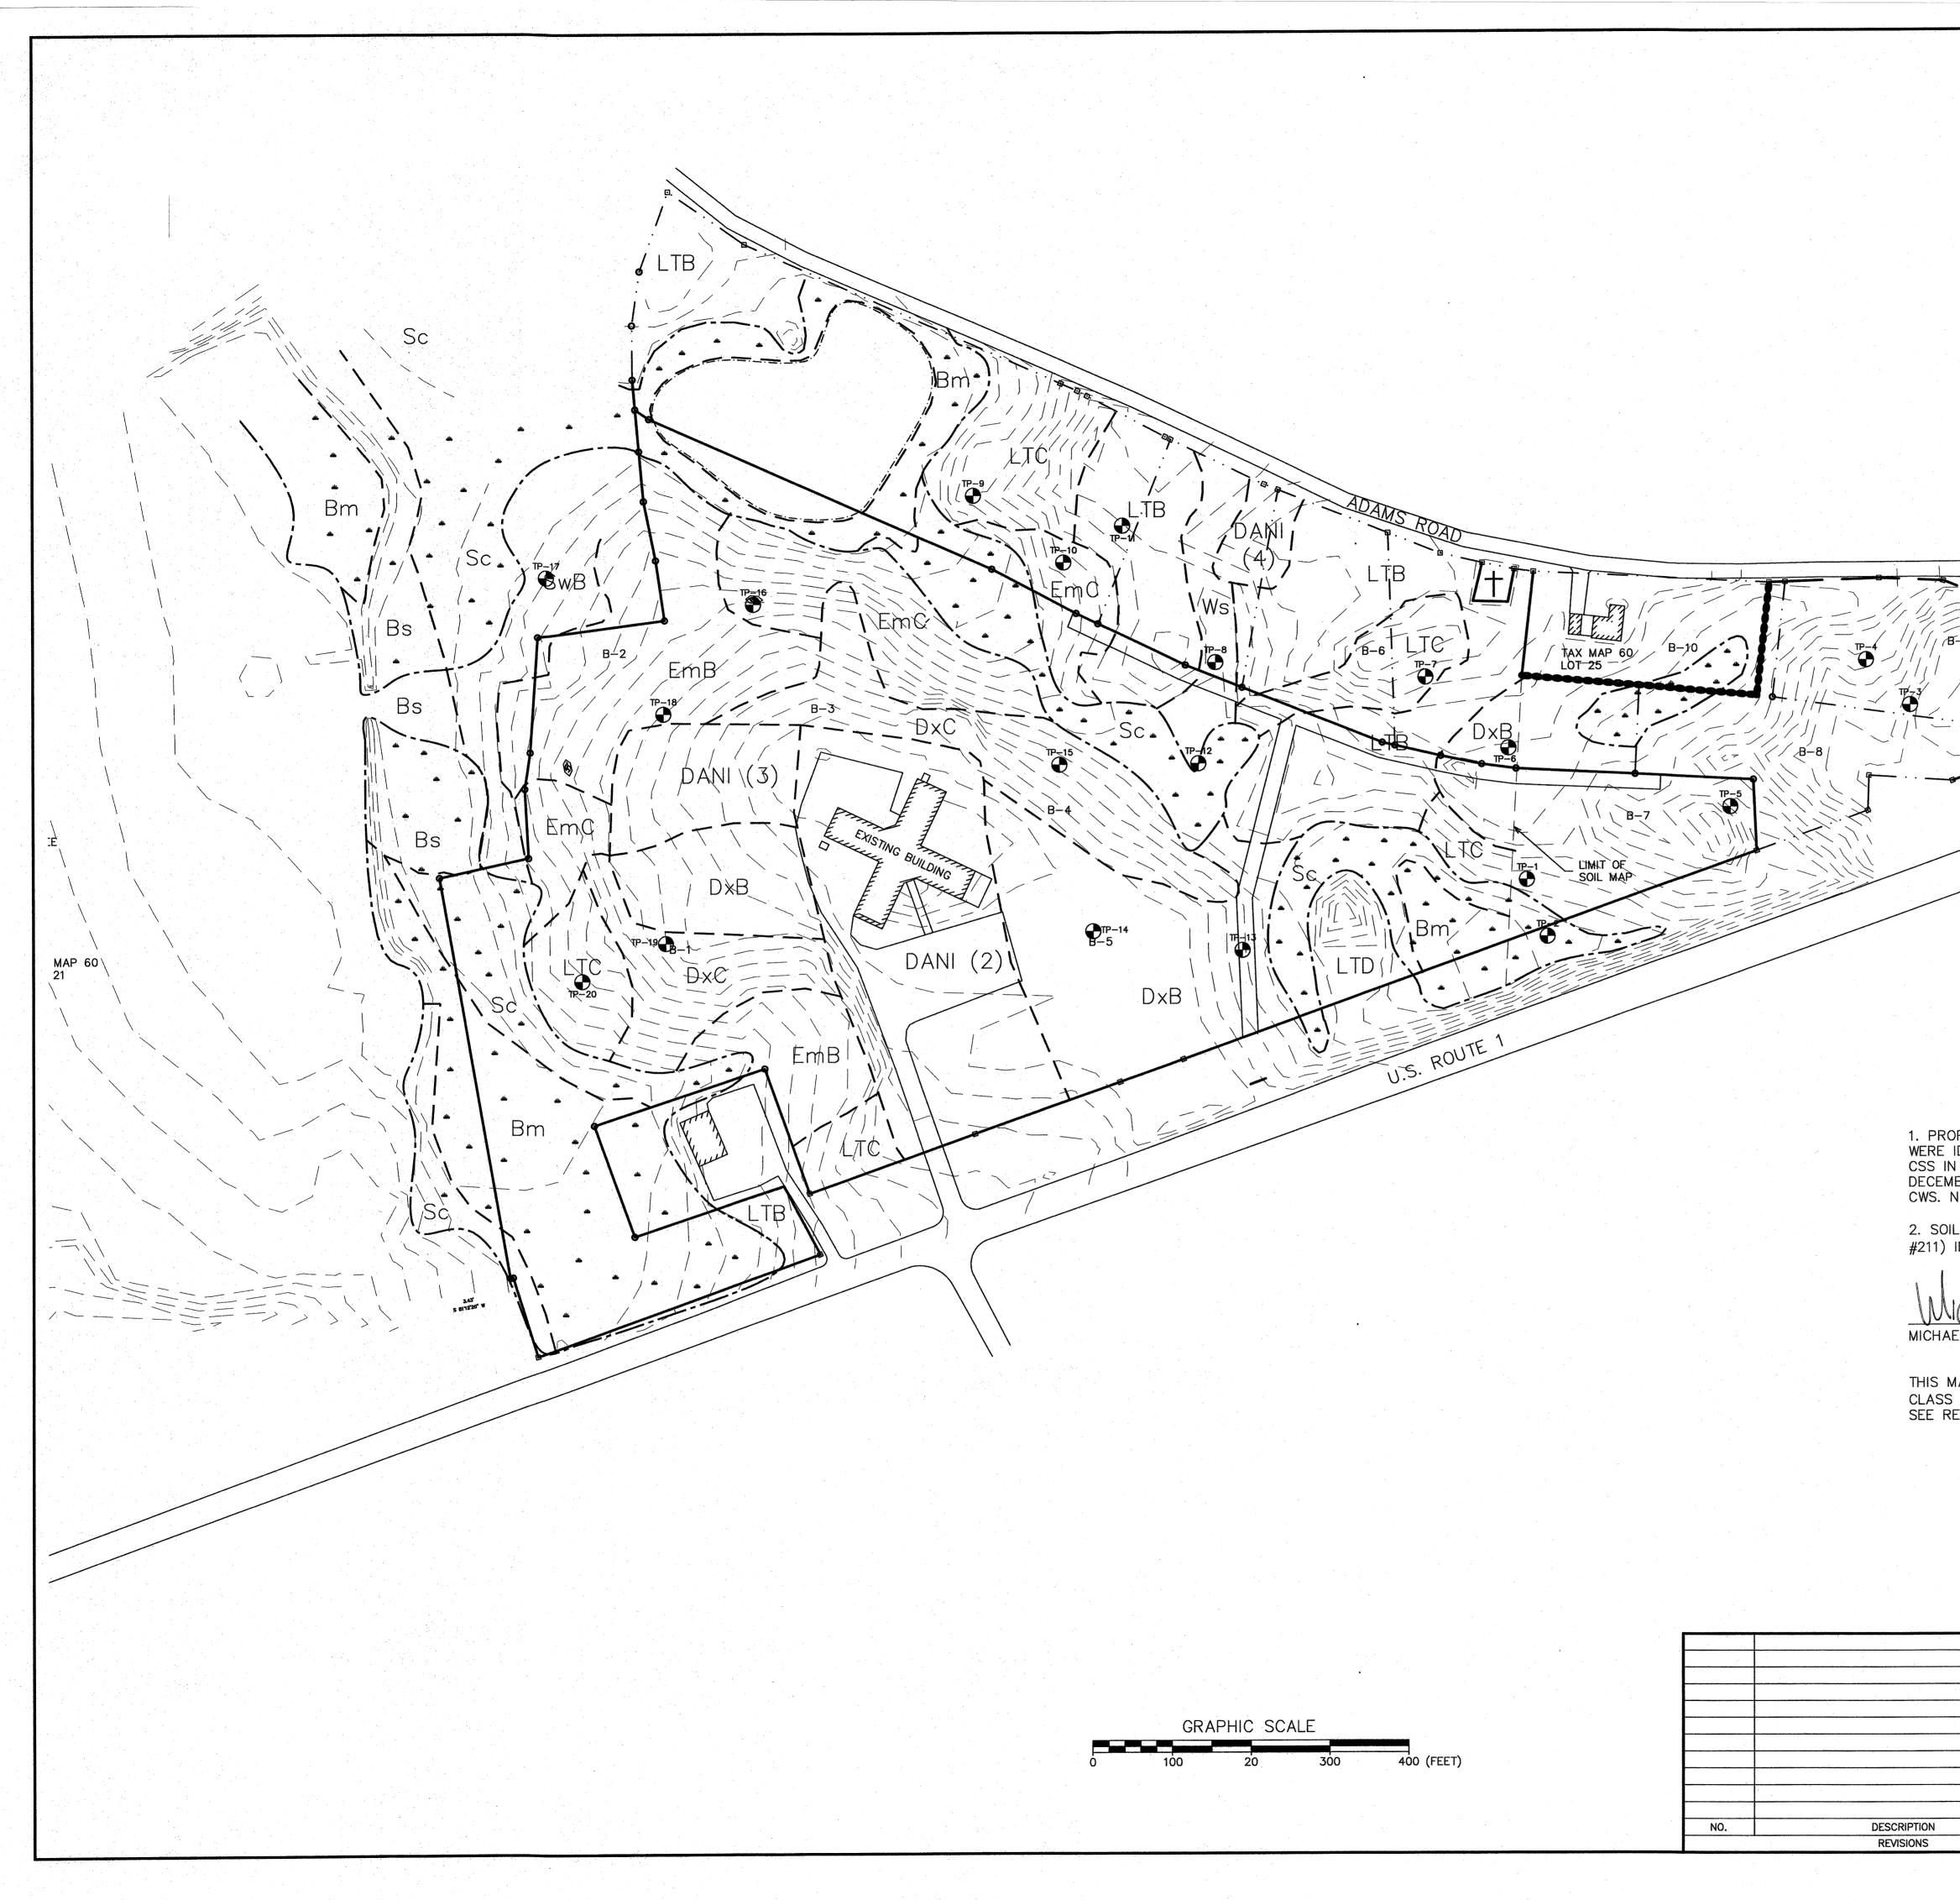1. PROPERTY LINES, WETLANDS, EXISTING CONDITIONS AND TOPOGRAPHY ARE FROM REFERENCE 1. WETLANDS WERE IDENTIFIED IN THE FIELD BY KENNETH A. WOOD, CWS IN DECEMBER, 1999 AND MICHAEL R. CUOMO, CWS, CSS IN MARCH, 2000. WETLANDS WERE LOCATED WITH SURVEY INSTRUMENT BY ATTAR ENGINEERING, INC. FROM DECEMBER, 1999 THROUGH APRIL, 2000. WETLAND DELINEATION WAS VERIFIED IN 2017 BY KENNETH A. WOOD, CWS. NO CHANGES WERE NOTED FROM THE PREVIOUS DELINEATION.

2. SOIL TYPES SHOWN ON THIS PLAN WERE IDENTIFIED BY MICHAEL CUOMO (MAINE CERTIFIED SOIL SCIENTIST #211) IN APRIL, 2000.

10JAN 2013 MICHAEL CUOMO, MAINE CERTIFIED SOIL SCIENTIST #211



							The second second
THIS MAP	COMPLIES	WITH THE	STANDAR	DS FOR			
CLASS "B"	HIGH INT	ENSITY SO	IL SURVEY.				
SEE REPOR	T DATED	14 APRIL	2000 FOR	DESCRIPTION	METHODS	OF	SOIL.

		4.1		NTENSITY SOIL S THE HOMESTEAD ROUTE 1 KITTER	
			FOR: LA POR	NDMARK HILL, LLC 79 CONGRESS ST TSMOUTH, NH 0380	)1
	· · · · · · · · · · · · · · · · · · ·			RENGINEERING VIL	INE
	DATE		SCALE: 1" = 100' DATE: 12/20/2017	APPROVED BY:	DRAWN BY: BRN REVISION : DATE -:-
			JOB NO: C052-17	CAD FILE: MBRIGHAM LBASE	SHEET 4.1
·	 •	 			TAX MAP 24 LOT 60


TAX MAP 24, LOT 60


## EROSION & SEDIMENTATION CONTROL NOTES

- SILTATION FENCE OR HAY BALE BARRIERS WILL BE INSTALLED DOWNSLOPE OF ALL STRIPPING OR CONSTRUCTION OPERATIONS. A DOUBLE SILT FENCE BARRIER SHALL BE INSTALLED DOWNSLOPE OF ANY SOIL MATERIAL STOCKPILES. SILT FENCES SHALL BE INSPECTED AFTER EACH RAIN EVENT AND DAILY DURING PROLONGED RAIN. SILT AND SOIL PARTICLES ACCUMULATING BEHIND THE FENCE SHALL BE REMOVED AFTER EACH SIGNIFICANT RAIN EVENT AND IN NO INSTANCE SHOULD ACCUMULATION EXCEED 1/2 THE HEIGHT OF THE FENCE. TORN OR DAMAGED AREAS SHALL BE REPAIRED.
- TEMPORARY AND PERMANENT VEGETATION AND MULCHING IS AN INTEGRAL COMPONENT OF THE EROSION AND SEDIMENTATION CONTROL PLAN. ALL AREAS SHALL BE INSPECTED AND MAINTAINED UNTIL THE DESIRED VEGETATIVE COVER IS ESTABLISHED. THESE CONTROL MEASURES ARE ESSENTIAL TO EROSION PREVENTION AND ALSO REDUCE COSTLY REWORK OF GRADED AND SHAPED AREAS.
- SEEDING. FERTILIZER AND LIME RATES AND TIME OF APPLICATION WILL BE DEPENDENT ON SOIL REQUIREMENTS. TEMPORARY VEGETATION SHALL BE MAINTAINED IN THESE AREAS UNTIL PERMANENT SEEDING IS APPLIED. ADDITIONALLY, EROSION AND SEDIMENTATION MEASURES SHALL BE MAINTAINED UNTIL PERMANENT VEGETATION IS ESTABLISHED.
- ALL LAWN AREA, OUTER POND SIDE SLOPES AND SWALES SHALL BE PERMANENTLY SEEDED WITH THE FOLLOWING MIXTURE: 20 LB/ACRE CREEPING RED FESCUE, 2 LB/ACRE REDTOP AND 20 LB/ACRE TALL FESCUE FOR A TOTAL OF 42 LB/ACRE. FERTILIZER AND LIME RATES SHALL BE DEPENDENT ON SOIL TESTING. IN THE ABSENCE OF SOIL TESTS, FERTILIZE WITH 10-20-20 (N-P205-K201) AT 800 LB/ACRE AND LIME AT 3 TONS/ACRE. MULCH WITH HAY AT 70-90 LB/1000 S.F. 4" OF LOAM SHALL BE APPLIED PRIOR TO SEEDING.
- POND BOTTOMS AND INNER POND SIDESLOPES SHALL BE PERMANENTLY SEEDED WITH THE FOLLOWING MIXTURE: 20 LB/ACRE CREEPING RED FESCUE, 8 LB/ACRE BIRDSFOOT TREFOIL AND 20 LB/ACRE TALL FESCUE FOR A TOTAL OF 48 LB/ACRE. SEE THE ABOVE NOTE FOR FERTILIZER. LIME AND MULCHING RATES
- TEMPORARY VEGETATION OF ALL DISTURBED AREAS. MATERIAL STOCKPILES AND OTHER SUCH AREAS SHALL BE ESTABLISHED BY SEEDING WITH EITHER WINTER RYE AT A RATE OF 112 LB/ACRE OR ANNUAL RYEGRASS AT A RATE OF 40 LB/ACRE. WINTER RYE SHALL BE USED FOR FALL SEEDING AND ANNUAL RYEGRASS FOR SHORT DURATION SEEDING. SEEDING SHALL BE ACCOMPLISHED BEFORE OCTOBER 1.
- TEMPORARY SEEDING OF DISTURBED AREAS SHALL BE ACCOMPLISHED BEFORE OCTOBER 1. PERMANENT SEEDING SHALL BE ACCOMPLISHED BEFORE SEPTEMBER 15.
- ALL SEEDED AREAS SHALL BE MULCHED WITH HAY AT A RATE OF 2 BALES (70-90 LB) PER 1000 S.F. OF SEEDED AREA.
- SLOPES 2:1 OR STEEPER SHALL BE TREATED WITH POLYJUTE OPEN WEAVE GEOTEXTILE (OR EQUIVALENT) AFTER SEEDING. JUTE MATS SHALL BE ANCHORED PER MANUFACTURER'S SPECIFICATIONS.
- D. EXCESSIVE DUST CAUSED BY CONSTRUCTION OPERATIONS SHALL BE CONTROLLED BY APPLICATION OF WATER OR CALCIUM CHLORIDE.
- . THE CONTRACTOR MAY OPT TO USE EROSION CONTROL MIX BERM AS A SEDIMENT BARRIER IN LIEU OF SILTATION FENCE OR HAY BALE BARRIERS WITH APPROVAL FROM THE INSPECTING ENGINEER.
- 2. MINIMIZE DISTURBED AREAS AND PROTECT NATURAL DOWNGRADIENT BUFFER AREAS TO THE EXTENT PRACTICABLE. CONTROL STORMWATER VOLUME AND VELOCITY WITHIN THE SITE TO MINIMIZE SOIL EROSION. MINIMIZE THE DISTURBANCE OF STEEP SLOPES. CONTROL STORMWATER DISCHARGES, INCLUDING BOTH PEAK FLOW RATES AND VOLUME, TO MINIMIZE EROSION AT OUTLETS. THE DISCHARGE MAY NOT RESULT IN EROSION OF ANY OPEN DRAINAGE CHANNELS, SWALES, STREAM CHANNELS OR STREAM BANKS, UPLAND, OR COASTAL OR FRESHWATER WETLANDS OFF THE PROJECT SITE.



- 13. WHENEVER PRACTICABLE, NO DISTURBANCE ACTIVITIES SHOULD TAKE PLACE WITHIN 50 FEET OF ANY PROTECTED NATURAL RESOURCE. IF DISTURBANCE ACTIVITIES TAKE PLACE BETWEEN 30 FEET AND 50 FEET OF ANY PROTECTED NATURAL RESOURCE. AND STORMWATER DISCHARGES THROUGH THE DISTURBED AREAS TOWARD THE PROTECTED NATURAL RESOURCE, PERIMETER EROSION CONTROLS MUST BE DOUBLED. IF DISTURBANCE ACTIVITIES TAKE PLACE LESS THAN 30 FEET FROM ANY PROTECTED NATURAL RESOURCE, AND STORMWATER DISCHARGES THROUGH THE DISTURBED AREAS TOWARD THE PROTECTED NATURAL RESOURCE, PERIMETER EROSION CONTROLS MUST BE DOUBLED AND DISTURBED AREAS MUST BE TEMPORARILY OR PERMANENTLY STABILIZED WITHIN 7 DAYS.
- 14. PRIOR TO CONSTRUCTION, PROPERLY INSTALL SEDIMENT BARRIERS AT THE DOWNGRADIENT EDGE OF ANY AREA TO BE DISTURBED AND ADJACENT TO ANY DRAINAGE CHANNELS WITHIN THE DISTURBED AREA. SEDIMENT BARRIERS SHOULD BE INSTALLED DOWNGRADIENT OF SOIL OR SEDIMENT STOCKPILES AND STORMWATER PREVENTED FROM RUNNING ONTO THE STOCKPILE. MAINTAIN THE SEDIMENT BARRIERS BY REMOVING ACCUMULATED SEDIMENT, OR REMOVING AND REPLACING THE BARRIER, UNTIL THE DISTURBED AREA IS PERMANENTLY STABILIZED. WHERE A DISCHARGE TO A STORM DRAIN INLET OCCURS, IF THE STORM DRAIN CARRIES WATER DIRECTLY TO A SURFACE WATER AND YOU HAVE AUTHORITY TO ACCESS THE STORM DRAIN INLET, YOU MUST INSTALL AND MAINTAIN PROTECTION MEASURES THAT REMOVE SEDIMENT FROM THE DISCHARGE.
- 15. PRIOR TO CONSTRUCTION, PROPERLY INSTALL A STABILIZED CONSTRUCTION ENTRANCE (SCE) AT ALL POINTS OF EGRESS FROM THE SITE. THE SCE IS A STABILIZED PAD OF AGGREGATE, UNDERLAIN BY A GEOTEXTILE FILTER FABRIC, USED TO PREVENT TRAFFIC FROM TRACKING MATERIAL AWAY FROM THE SITE ONTO PUBLIC ROW'S. MAINTAIN THE SCE UNTIL ALL DISTURBED AREAS ARE STABILIZED.
- 16. WITHIN 7 DAYS OF THE CESSATION OF CONSTRUCTION ACTIVITIES IN AN AREA THAT WILL NOT BE WORKED FOR MORE THAN 7 DAYS. STABILIZE ANY EXPOSED SOIL WITH MULCH, OR OTHER NON-ERODIBLE COVER. STABILIZE AREAS WITHIN 75 FEET OF A WETLAND OR WATERBODY WITHIN 48 HOURS OF THE INITIAL DISTURBANCE OF THE SOIL OR PRIOR TO ANY STORM EVENT, WHICHEVER COMES FIRST.
- 17. REMOVE ANY TEMPORARY CONTROL MEASURES, SUCH AS SILTATION FENCE, WITHIN 30 DAYS AFTER PERMANENT STABILIZATION IS ATTAINED. REMOVE ANY ACCUMULATED SEDIMENTS AND STABILIZE.
- 18. IF THE AREA WILL NOT BE WORKED FOR MORE THAN ONE YEAR OR HAS BEEN BROUGHT TO FINAL GRADE, THEN PERMANENTLY STABILIZE THE AREA WITHIN 7 DAYS BY PLANTING VEGETATION, SEEDING, SOD, OR THROUGH THE USE OF PERMANENT MULCH, OR RIPRAP, OR ROAD SUB-BASE. IF USING VEGETATION FOR STABILIZATION, SELECT THE PROPER VEGETATION FOR THE LIGHT, MOISTURE, AND SOIL CONDITIONS; AMEND AREAS OF DISTURBED SUBSOILS WITH TOPSOIL, COMPOST, OR FERTILIZERS; PROTECT SEEDED AREAS WITH MULCH OR, IF NECESSARY, EROSION CONTROL BLANKETS; AND SCHEDULE SODDING, PLANTING, AND SEEDING SO TO AVOID DIE-OFF FROM SUMMER DROUGHT AND FALL FROSTS. NEWLY SEEDED OR SODDED AREAS MUST BE PROTECTED FROM VEHICLE TRAFFIC, EXCESSIVE PEDESTRIAN TRAFFIC, AND CONCENTRATED RUNOFF UNTIL THE VEGETATION IS WELL-ESTABLISHED WITH 90% COVER BY HEALTHY VEGETATION. IF NECESSARY, AREAS MUST BE REWORKED AND RESTABILIZED IF GERMINATION IS SPARSE, PLANT COVERAGE IS SPOTTY, OR TOPSOIL EROSION IS EVIDENT. ONE OR MORE OF THE FOLLOWING MAY APPLY TO A PARTICULAR SITE.
- 19. FOR SEEDED AREAS, PERMANENT STABILIZATION MEANS A 90% COVER OF THE DISTURBED AREA WITH MATURE, HEALTHY PLANTS WITH NO EVIDENCE OF WASHING OR RILLING OF THE TOPSOIL.
- 20. FOR SODDED AREAS, PERMANENT STABILIZATION MEANS THE COMPLETE BINDING OF THE SOD ROOTS INTO THE UNDERLYING SOIL WITH NO SLUMPING OF THE SOD OR DIE-OFF.
- 21. FOR MULCHED AREAS, PERMANENT MULCHING MEANS TOTAL COVERAGE OF THE EXPOSED AREA WITH AN APPROVED MULCH MATERIAL. EROSION CONTROL MIX MAY BE USED AS MULCH FOR PERMANENT STABILIZATION ACCORDING TO THE APPROVED APPLICATION RATES AND LIMITATIONS.
- 22. THE CONTRACTOR SHALL BE RESPONSIBLE FOR ADEQUATE HOUSEKEEPING PRACTICES DURING THE CONSTRUCTION OF THE PROJECT. THESE STANDARDS CAN BE FOUND IN THE FOLLOWING DOCUMENT: MDEP CHAPTER 500 (STORMWATER MANAGEMENT) APPENDIX C. HOUSEKEEPING. HOUSEKEEPING PRACTICES INCLUDE, BUT ARE NOT LIMITED TO, SPILL PREVENTION, GROUNDWATER PROTECTION, FUGITIVE SEDIMENT AND DUST. DEBRIS AND OTHER MATERIALS. EXCAVATION DEWATERING. AUTHORIZED NON-STORMWATER DISCHARGES AND UNAUTHORIZED NON-STORMWATER DISCHARGES.

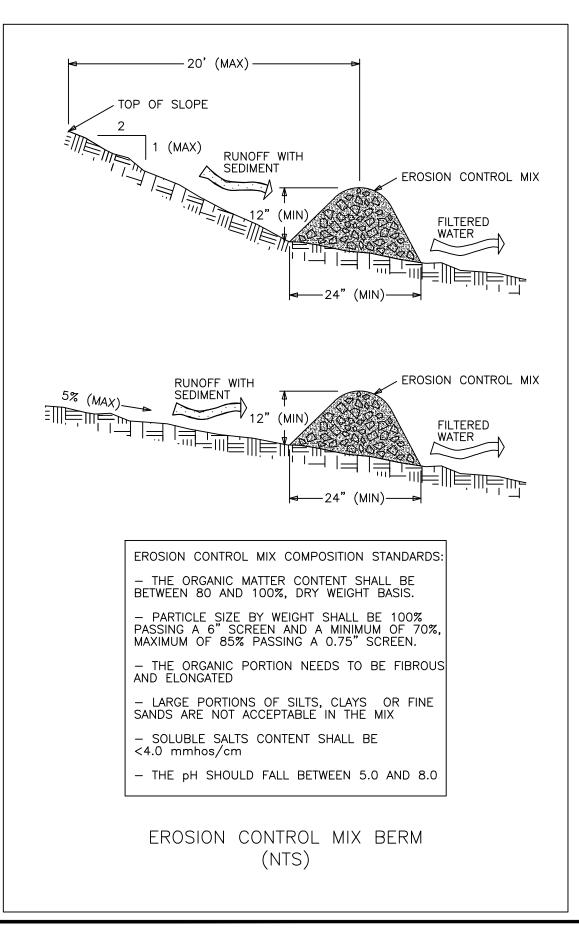

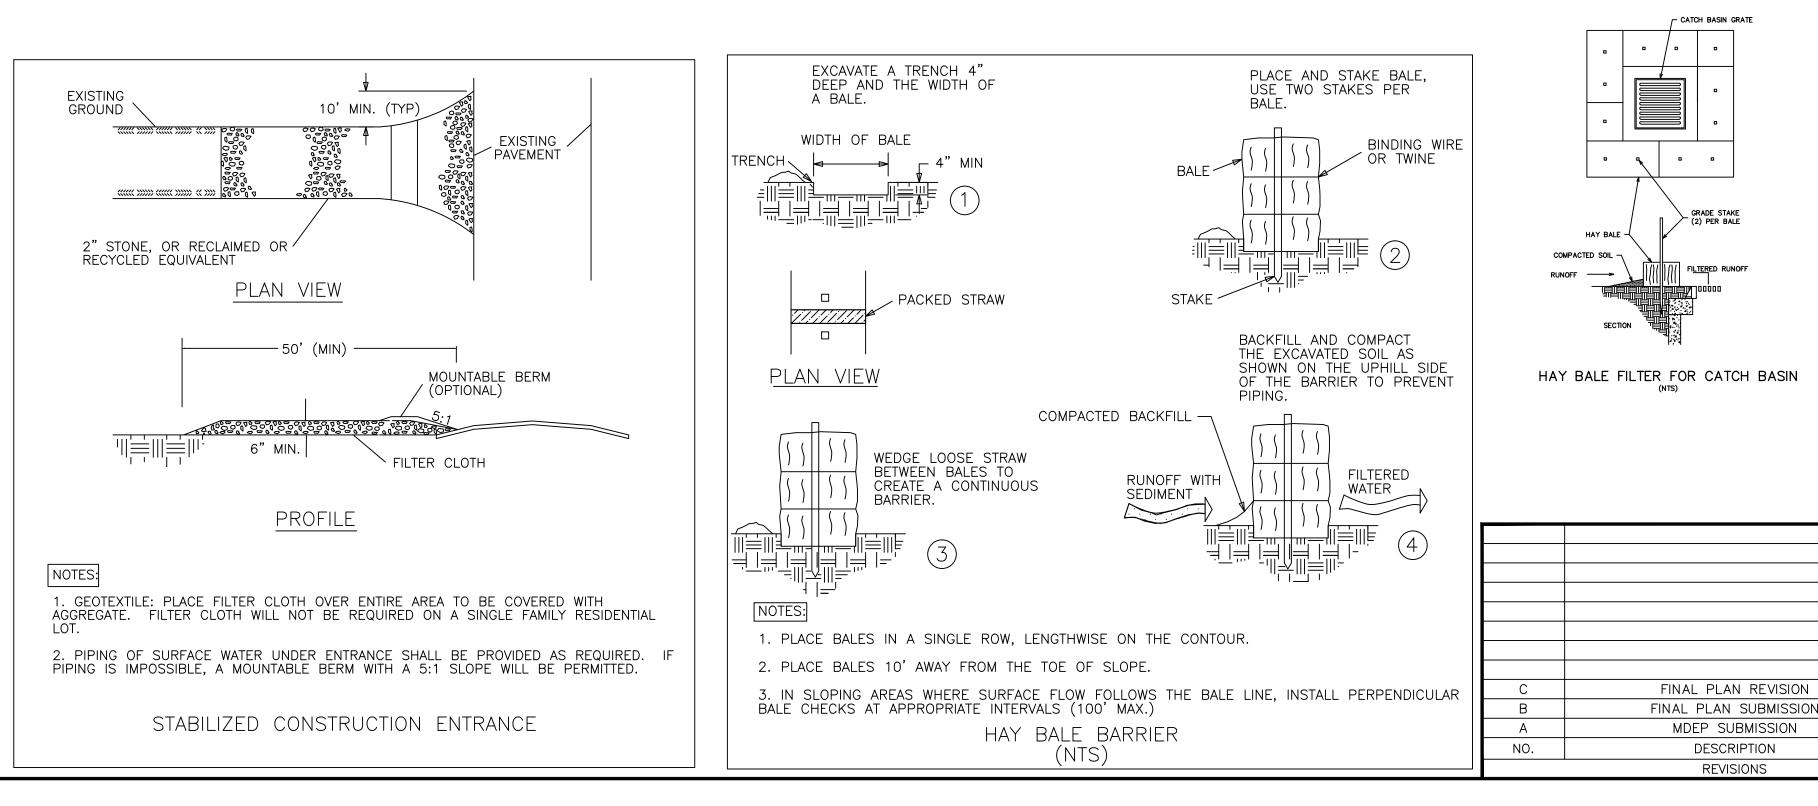

NOVEMBER 1 - APRIL 15 1. AN AREA SHALL BE CONSIDERED STABILIZED WHEN EXPOSED SURFACES HAVE BEEN EITHER MULCHED WITH HAY AT A RATE OF 100 LB/1000 S.F. OR DORMANT SEEDED. MULCHED AND ADEQUATELY ANCHORED BY AN APPROVED ANCHORING TECHNIQUE. IN ALL CASES. MULCH SHALL BE APPLIED SO THAT THE SOIL SURFACE IS NOT VISIBLE THROUGH THE MULCH.

2. FROM OCTOBER 15 TO APRIL 1, LOAM AND SEED WILL NOT BE REQUIRED. DURING PERIODS OF TEMPERATURES ABOVE FREEZING, DISTURBED AREAS SHALL BE FINE GRADED AND PROTECTED WITH MULCH OR TEMPORARILY SEEDED AND MULCHED UNTIL PERMANENT SEEDING CAN BE APPLIED. AFTER NOVEMBER 1, DISTURBED AREAS MAY BE LOAMED, FINE GRADED AND DORMANT SEEDED AT A RATE 200-300% HIGHER THAN THE SPECIFIED PERMANENT SEEDING RATE. IF CONSTRUCTION CONTINUES DURING FREEZING WEATHER, DISTURBED AREAS SHALL BE GRADED BEFORE FREEZING AND TEMPORARILY STABILIZED WITH MULCH. DISTURBED AREAS SHALL NOT BE LEFT OVER THE WINTER OR FOR ANY OTHER EXTENDED PERIOD OF TIME UNLESS STABILIZED WITH MULCH.

3. FROM NOVEMBER 1 TO APRIL 15 ALL MULCH SHALL BE ANCHORED BY EITHER PEG LINE, MULCH NETTING, ASPHALT EMULSION CHEMICAL, TRACK OR WOOD CELLULOSE FIBER. MULCH NETTING SHALL BE USED TO ANCHOR MULCH IN ALL DRAINAGE WAYS WITH SLOPES GREATER THAN 3%, SLOPES EXPOSED TO DIRECT WINDS AND FOR SLOPES GREATER THAN 8%. MULCH NETTING SHALL BE USED TO ANCHOR MULCH IN ALL AREAS WITH SLOPES GREATER THAN 15%. AFTER OCTOBER 1, THE SAME APPLIES TO ALL SLOPES GREATER THAN 8%.

4. SNOW SHALL BE REMOVED FROM AREAS OF SEEDING AND MULCHING PRIOR TO PLACEMENT.

5. FOR WINTER STABILIZATION, HAY MULCH SHALL BE APPLIED AT TWICE THE STANDARD TEMPORARY STABILIZATION RATE. AT THE END OF EACH CONSTRUCTION DAY, AREAS THAT HAVE BEEN BROUGHT TO FINAL GRADE SHALL BE STABILIZED. MULCH SHALL NOT BE SPREAD ON TOP OF SNOW.


6. ALL AREAS WITHIN 75 FEET OF A PROTECTED NATURAL RESOURCE SHALL BE PROTECTED WITH A DOUBLE ROW OF SEDIMENT BARRIERS.


7. ALL VEGETATED DITCH LINES THAT HAVE NOT BEEN STABILIZED BY NOVEMBER 1. OR WILL BE WORKED DURING THE WINTER CONSTRUCTION PERIOD, SHALL BE STABILIZED WITH AN APPROPRIATE STONE LINING BACKED BY AN APPROPRIATE GRAVEL BED OR GEOTEXTILE UNLESS SPECIFICALLY RELEASED FROM THIS STANDARD BY THE MDEP.


8. MULCH NETTING SHALL BE USED TO ANCHOR MULCH ON ALL SLOPES GREATER THAN 8% UNLESS EROSION CONTROL BLANKETS OR EROSION CONTROL MIX IS BEING USED ON SUCH SLOPES.


## E&S INSPECTION/MAINTENANCE DURING CONSTRUCTION


- INSPECTION AND CORRECTIVE ACTION. INSPECT DISTURBED AND IMPERVIOUS AREAS, EROSION CONTROL MEASURES, MATERIALS STORAGE AREAS THAT ARE EXPOSED TO PRECIPITATION, AND LOCATIONS WHERE VEHICLES ENTER OR EXIT THE SITE. INSPECT THESE AREAS AT LEAST ONCE A WEEK AS WELL AS BEFORE AND WITHIN 24 HOURS AFTER A STORM EVENT (RAINFALL). AND PRIOR TO COMPLETING PERMANENT STABILIZATION MEASURES. A PERSON WITH KNOWLEDGE OF EROSION AND STORMWATER CONTROL, INCLUDING THE STANDARDS AND CONDITIONS IN THE PERMIT, SHALL CONDUCT THE INSPECTIONS.
- MAINTENANCE. IF BEST MANAGEMENT PRACTICES (BMPS) NEED TO BE REPAIRED, THE REPAIR WORK SHOULD BE INITIATED UPON DISCOVERY OF THE PROBLEM BUT NO LATER THAN THE END OF THE NEXT WORKDAY. IF ADDITIONAL BMPS OR SIGNIFICANT REPAIR OF BMPS ARE NECESSARY, IMPLEMENTATION MUST BE COMPLETED WITHIN 7 CALENDAR DAYS AND PRIOR TO ANY STORM EVENT (RAINFALL). ALL MEASURES MUST BE MAINTAINED IN EFFECTIVE OPERATING CONDITION UNTIL AREAS ARE PERMANENTLY STABILIZED.
- DOCUMENTATION. KEEP A LOG (REPORT) SUMMARIZING THE INSPECTIONS AND ANY CORRECTIVE ACTION TAKEN. THE LOG MUST INCLUDE THE NAME(S) AND QUALIFICATIONS OF THE PERSON MAKING THE INSPECTIONS, THE DATE(S) OF THE INSPECTIONS, AND MAJOR OBSERVATIONS ABOUT THE OPERATION AND MAINTENANCE OF EROSION AND SEDIMENTATION CONTROLS, MATERIALS STORAGE AREAS, AND VEHICLES ACCESS POINTS TO THE PARCEL. MAJOR OBSERVATIONS MUST INCLUDE BMPS THAT NEED MAINTENANCE, BMPS THAT FAILED TO OPERATE AS DESIGNED OR PROVED INADEQUATE FOR A PARTICULAR LOCATION, AND LOCATION(S) WHERE ADDITIONAL BMPS ARE NEEDED. FOR EACH BMP REQUIRING MAINTENANCE BMP NEEDING REPLACEMENT, AND LOCATION NEEDING ADDITIONAL BMPS, NOTE IN THE LOG THE CORRECTIVE ACTION TAKEN AND WHEN IT WAS TAKEN. THE LOG MUST BE MADE ACCESSIBLE TO DEPARTMENT STAFF AND A COPY MUST BE PROVIDED UPON REQUEST. THE PERMITTEE SHALL RETAIN A COPY OF THE LOG FOR A PERIOD OF AT LEAST THREE YEARS FROM THE COMPLETION OF PERMANENT STABILIZATION.

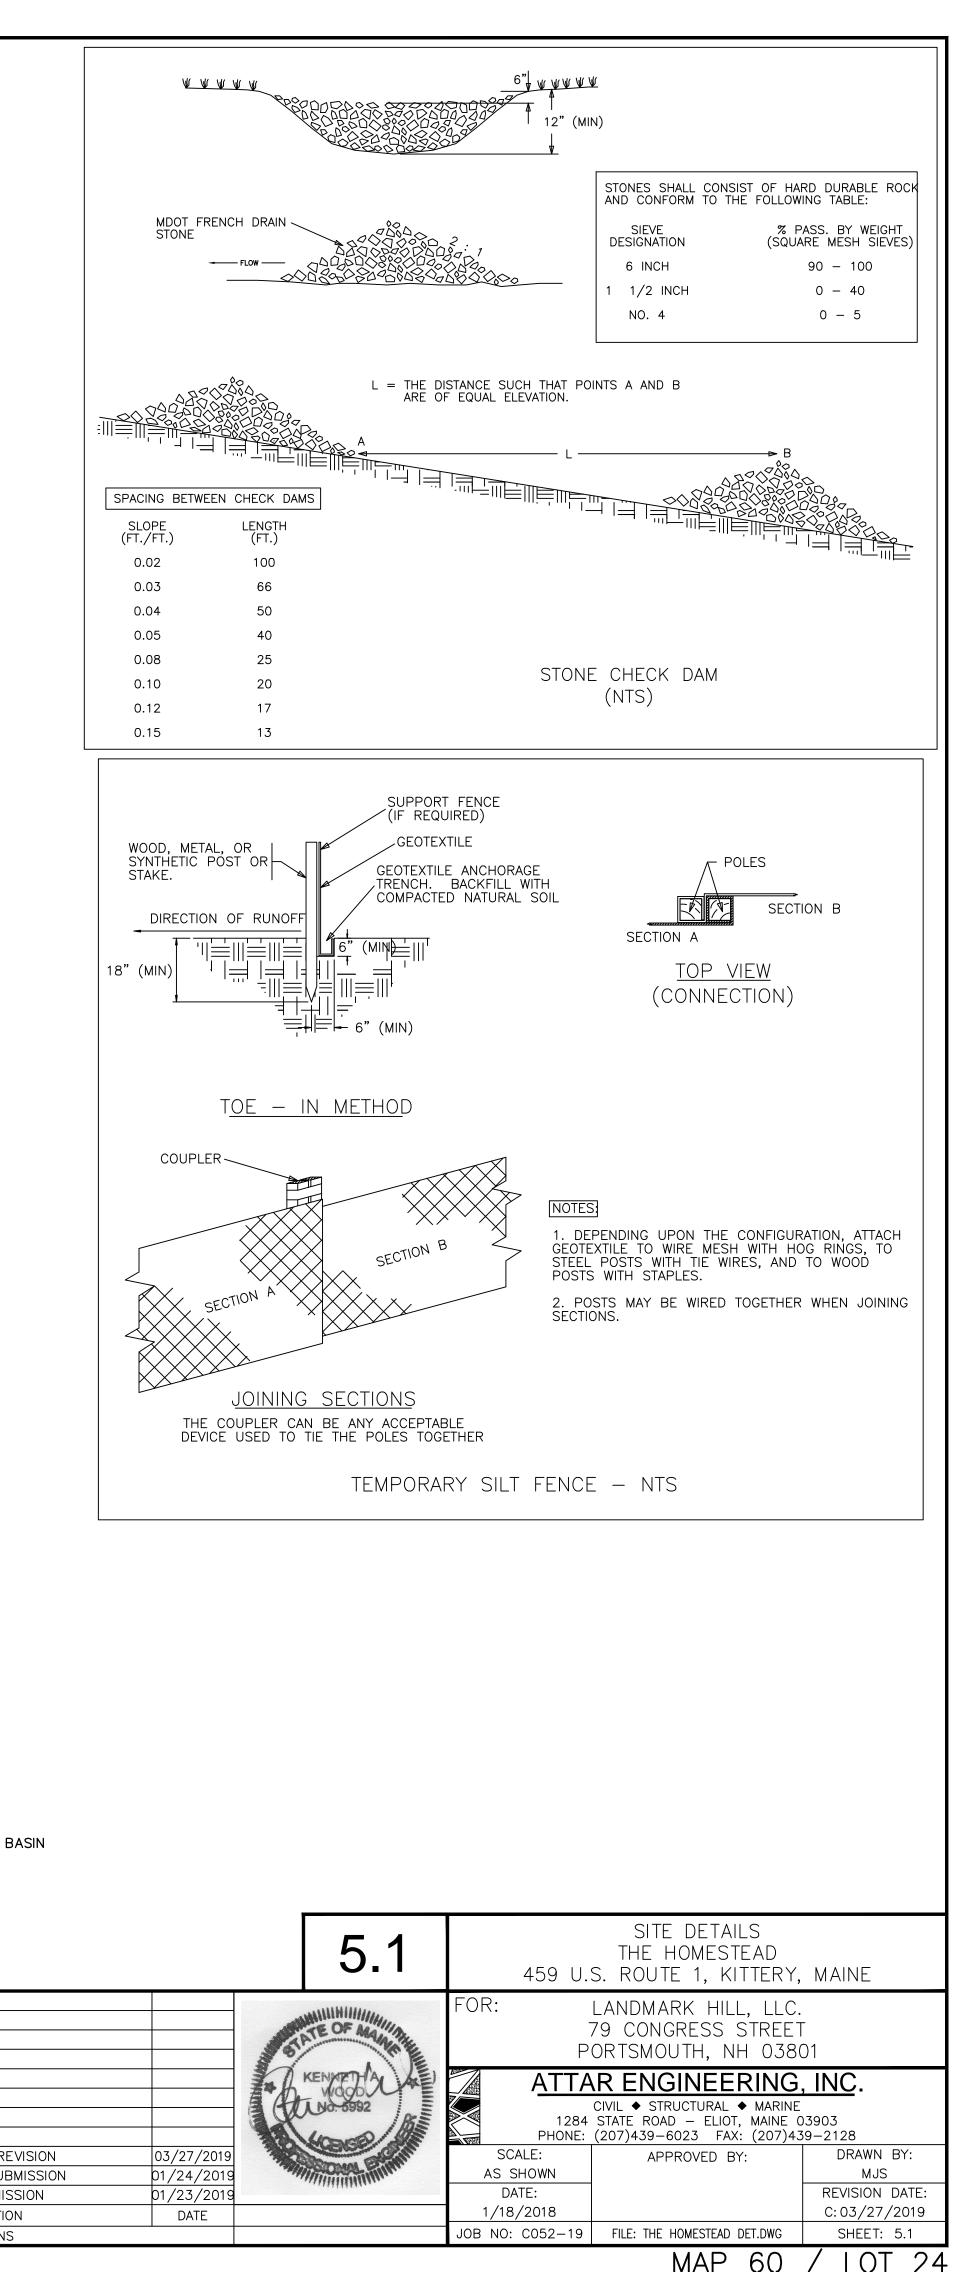

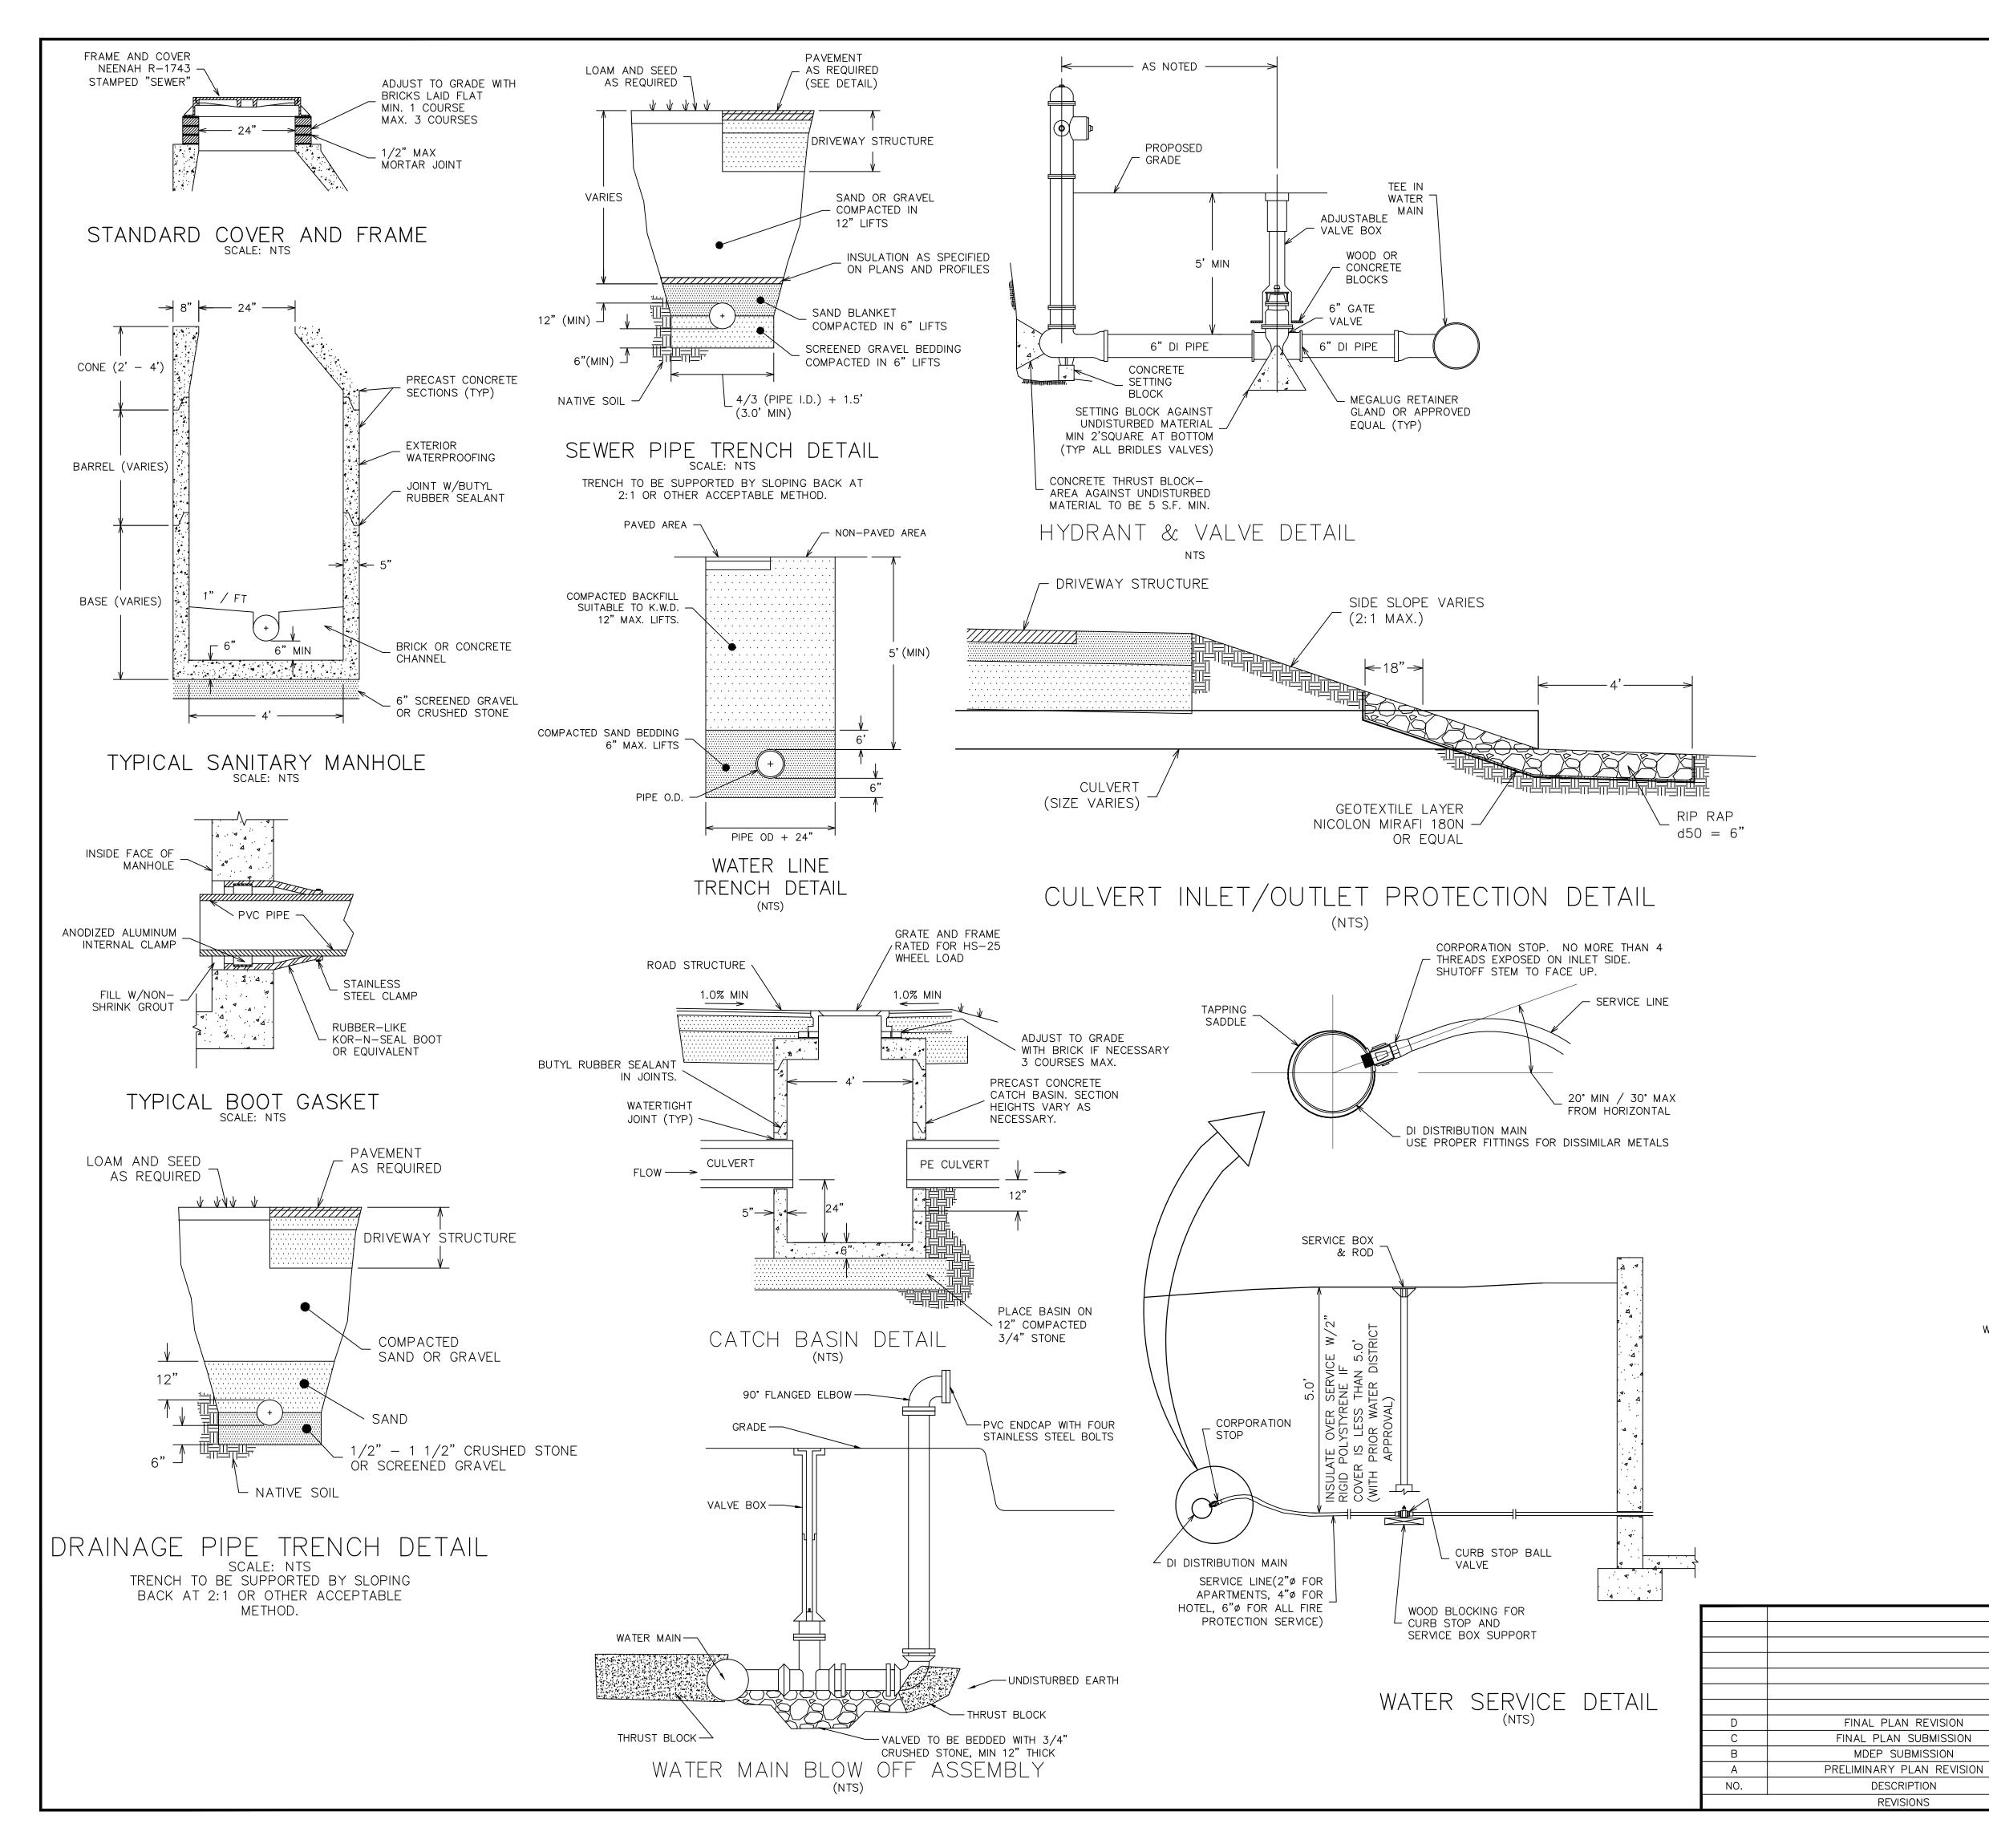


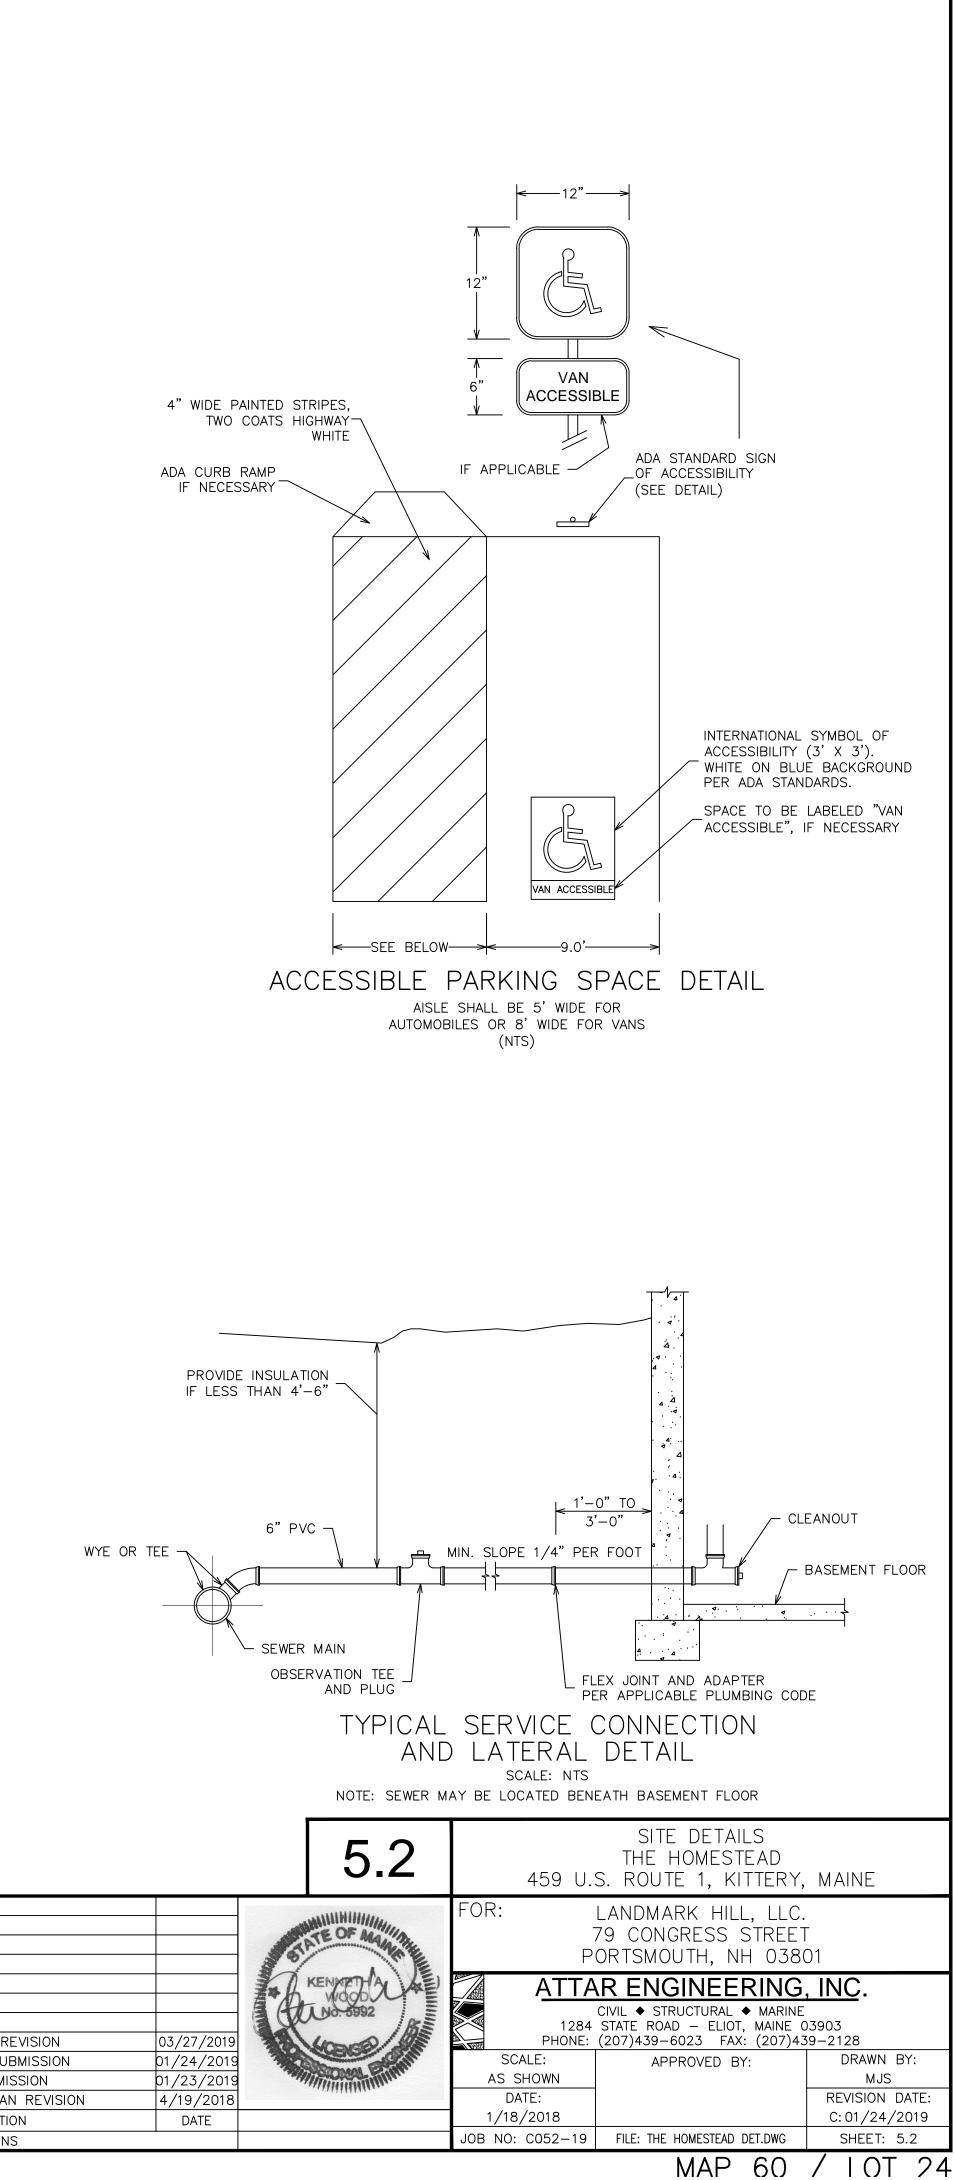

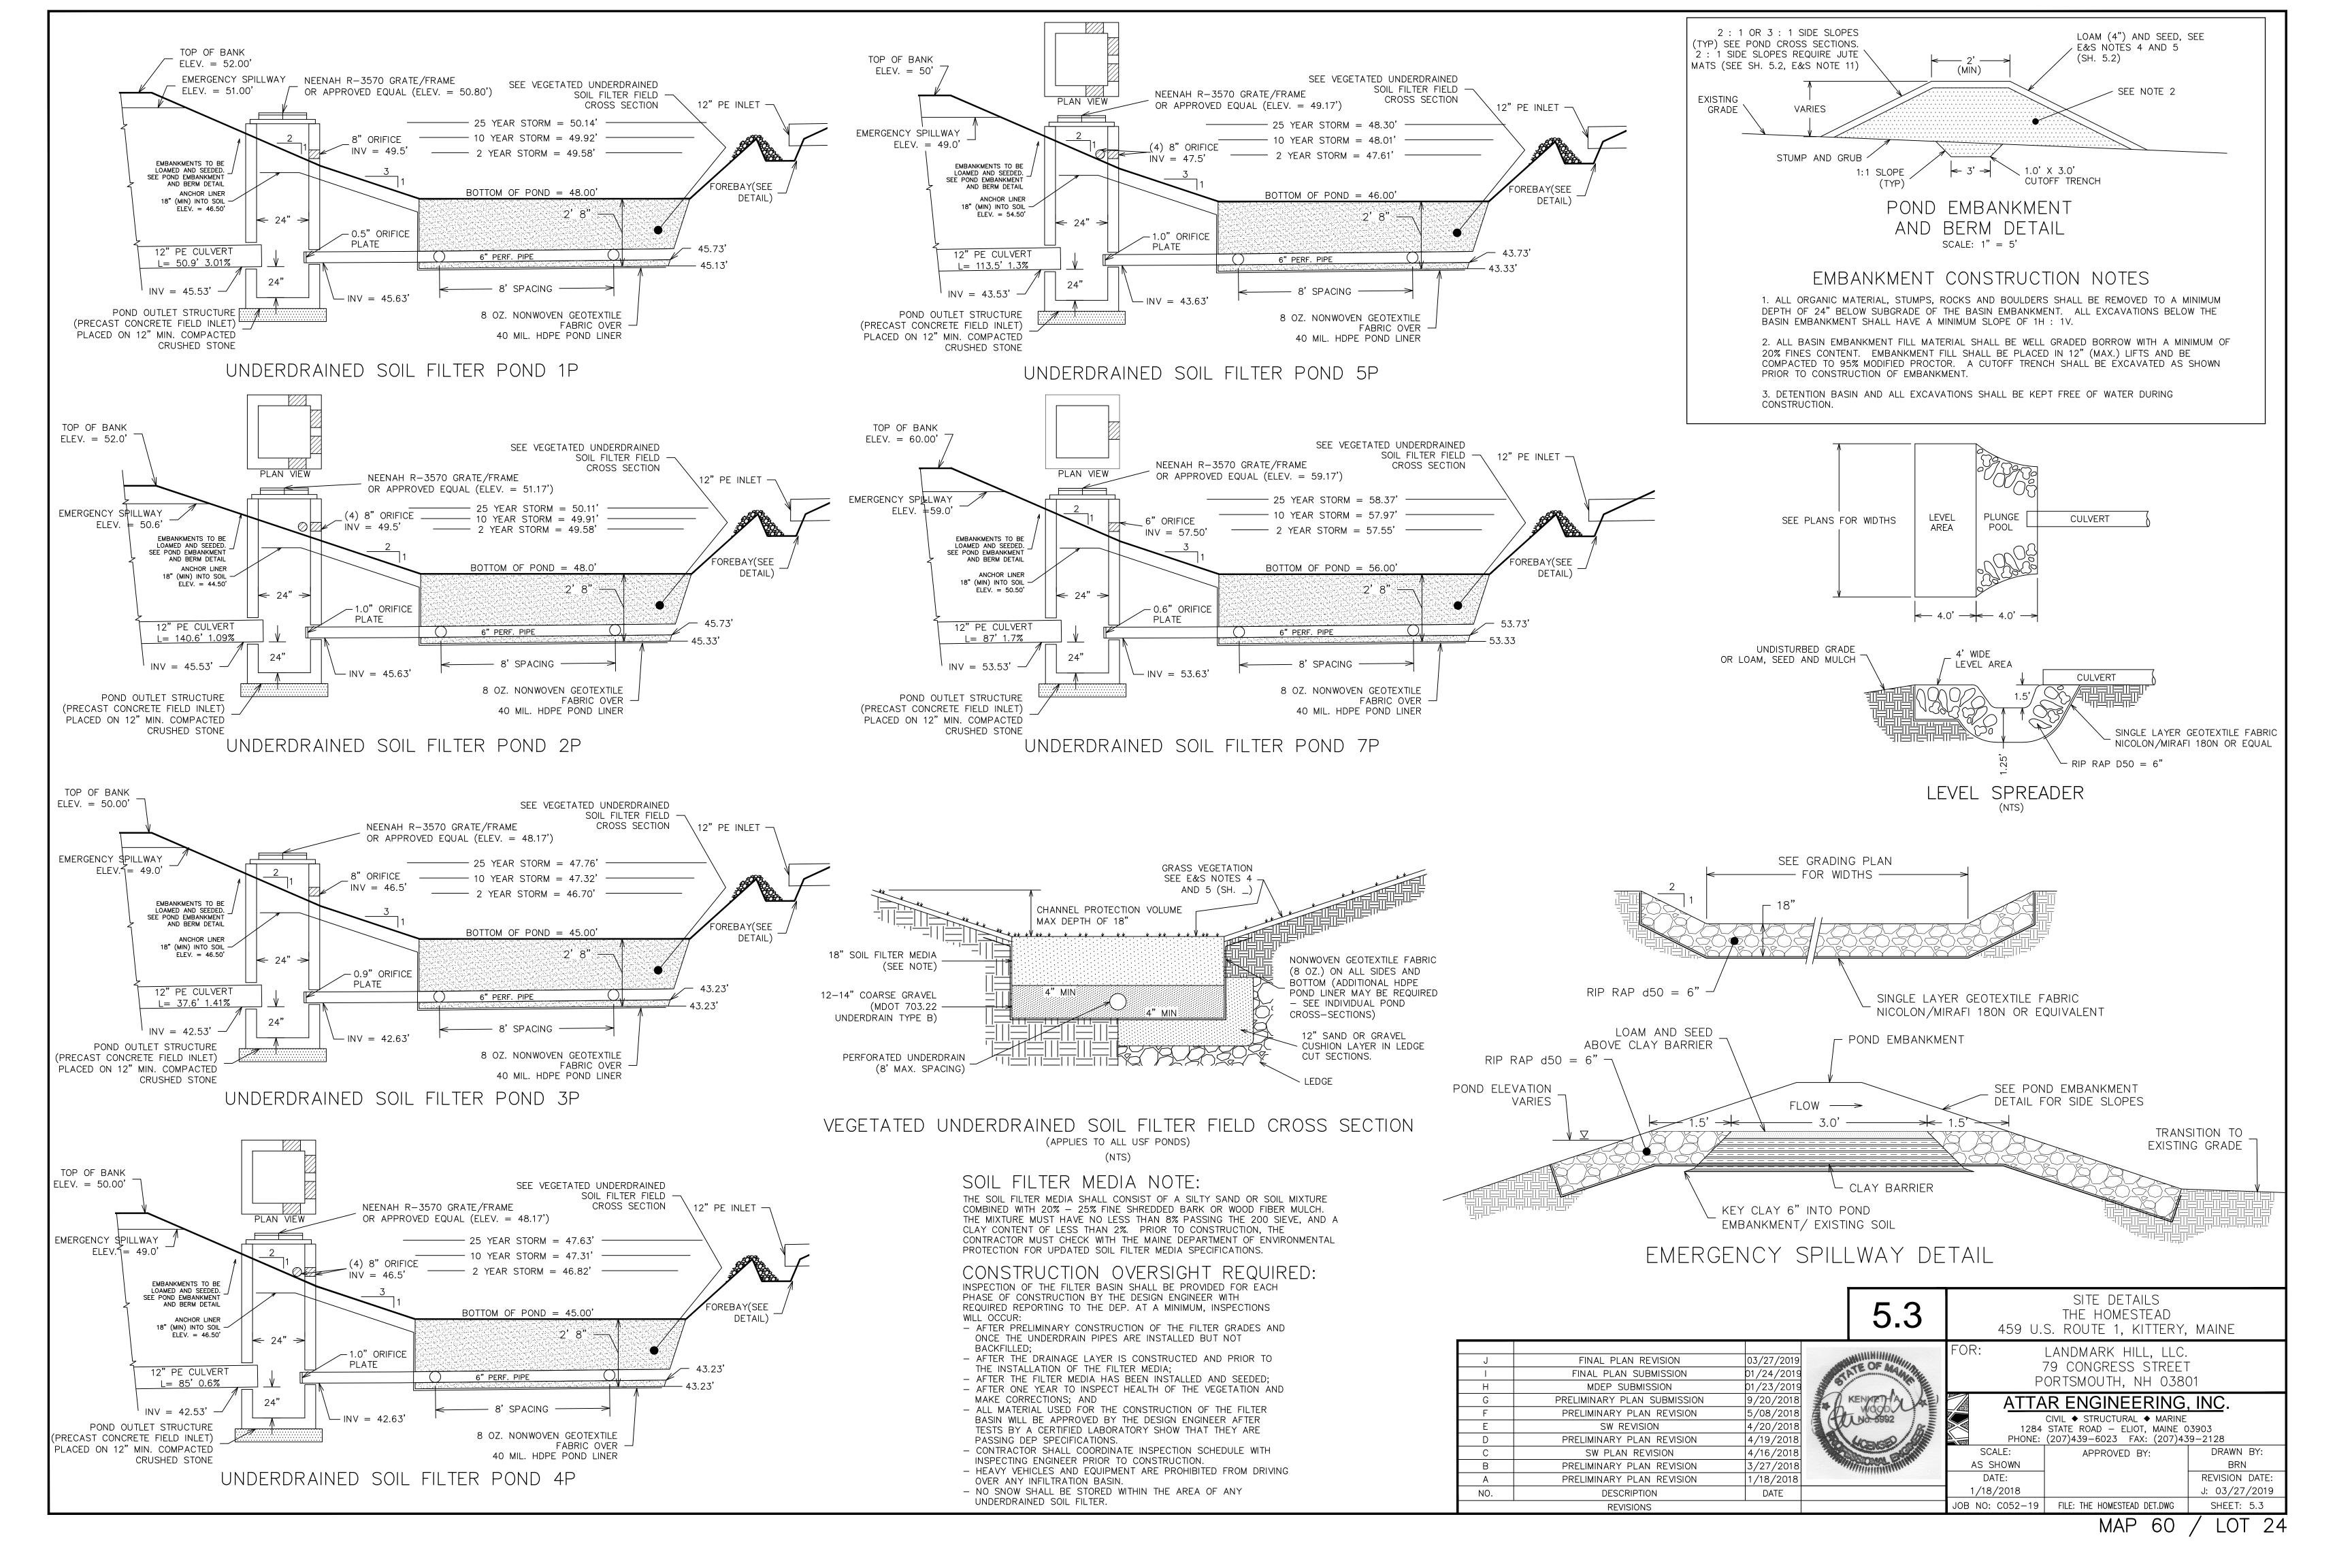

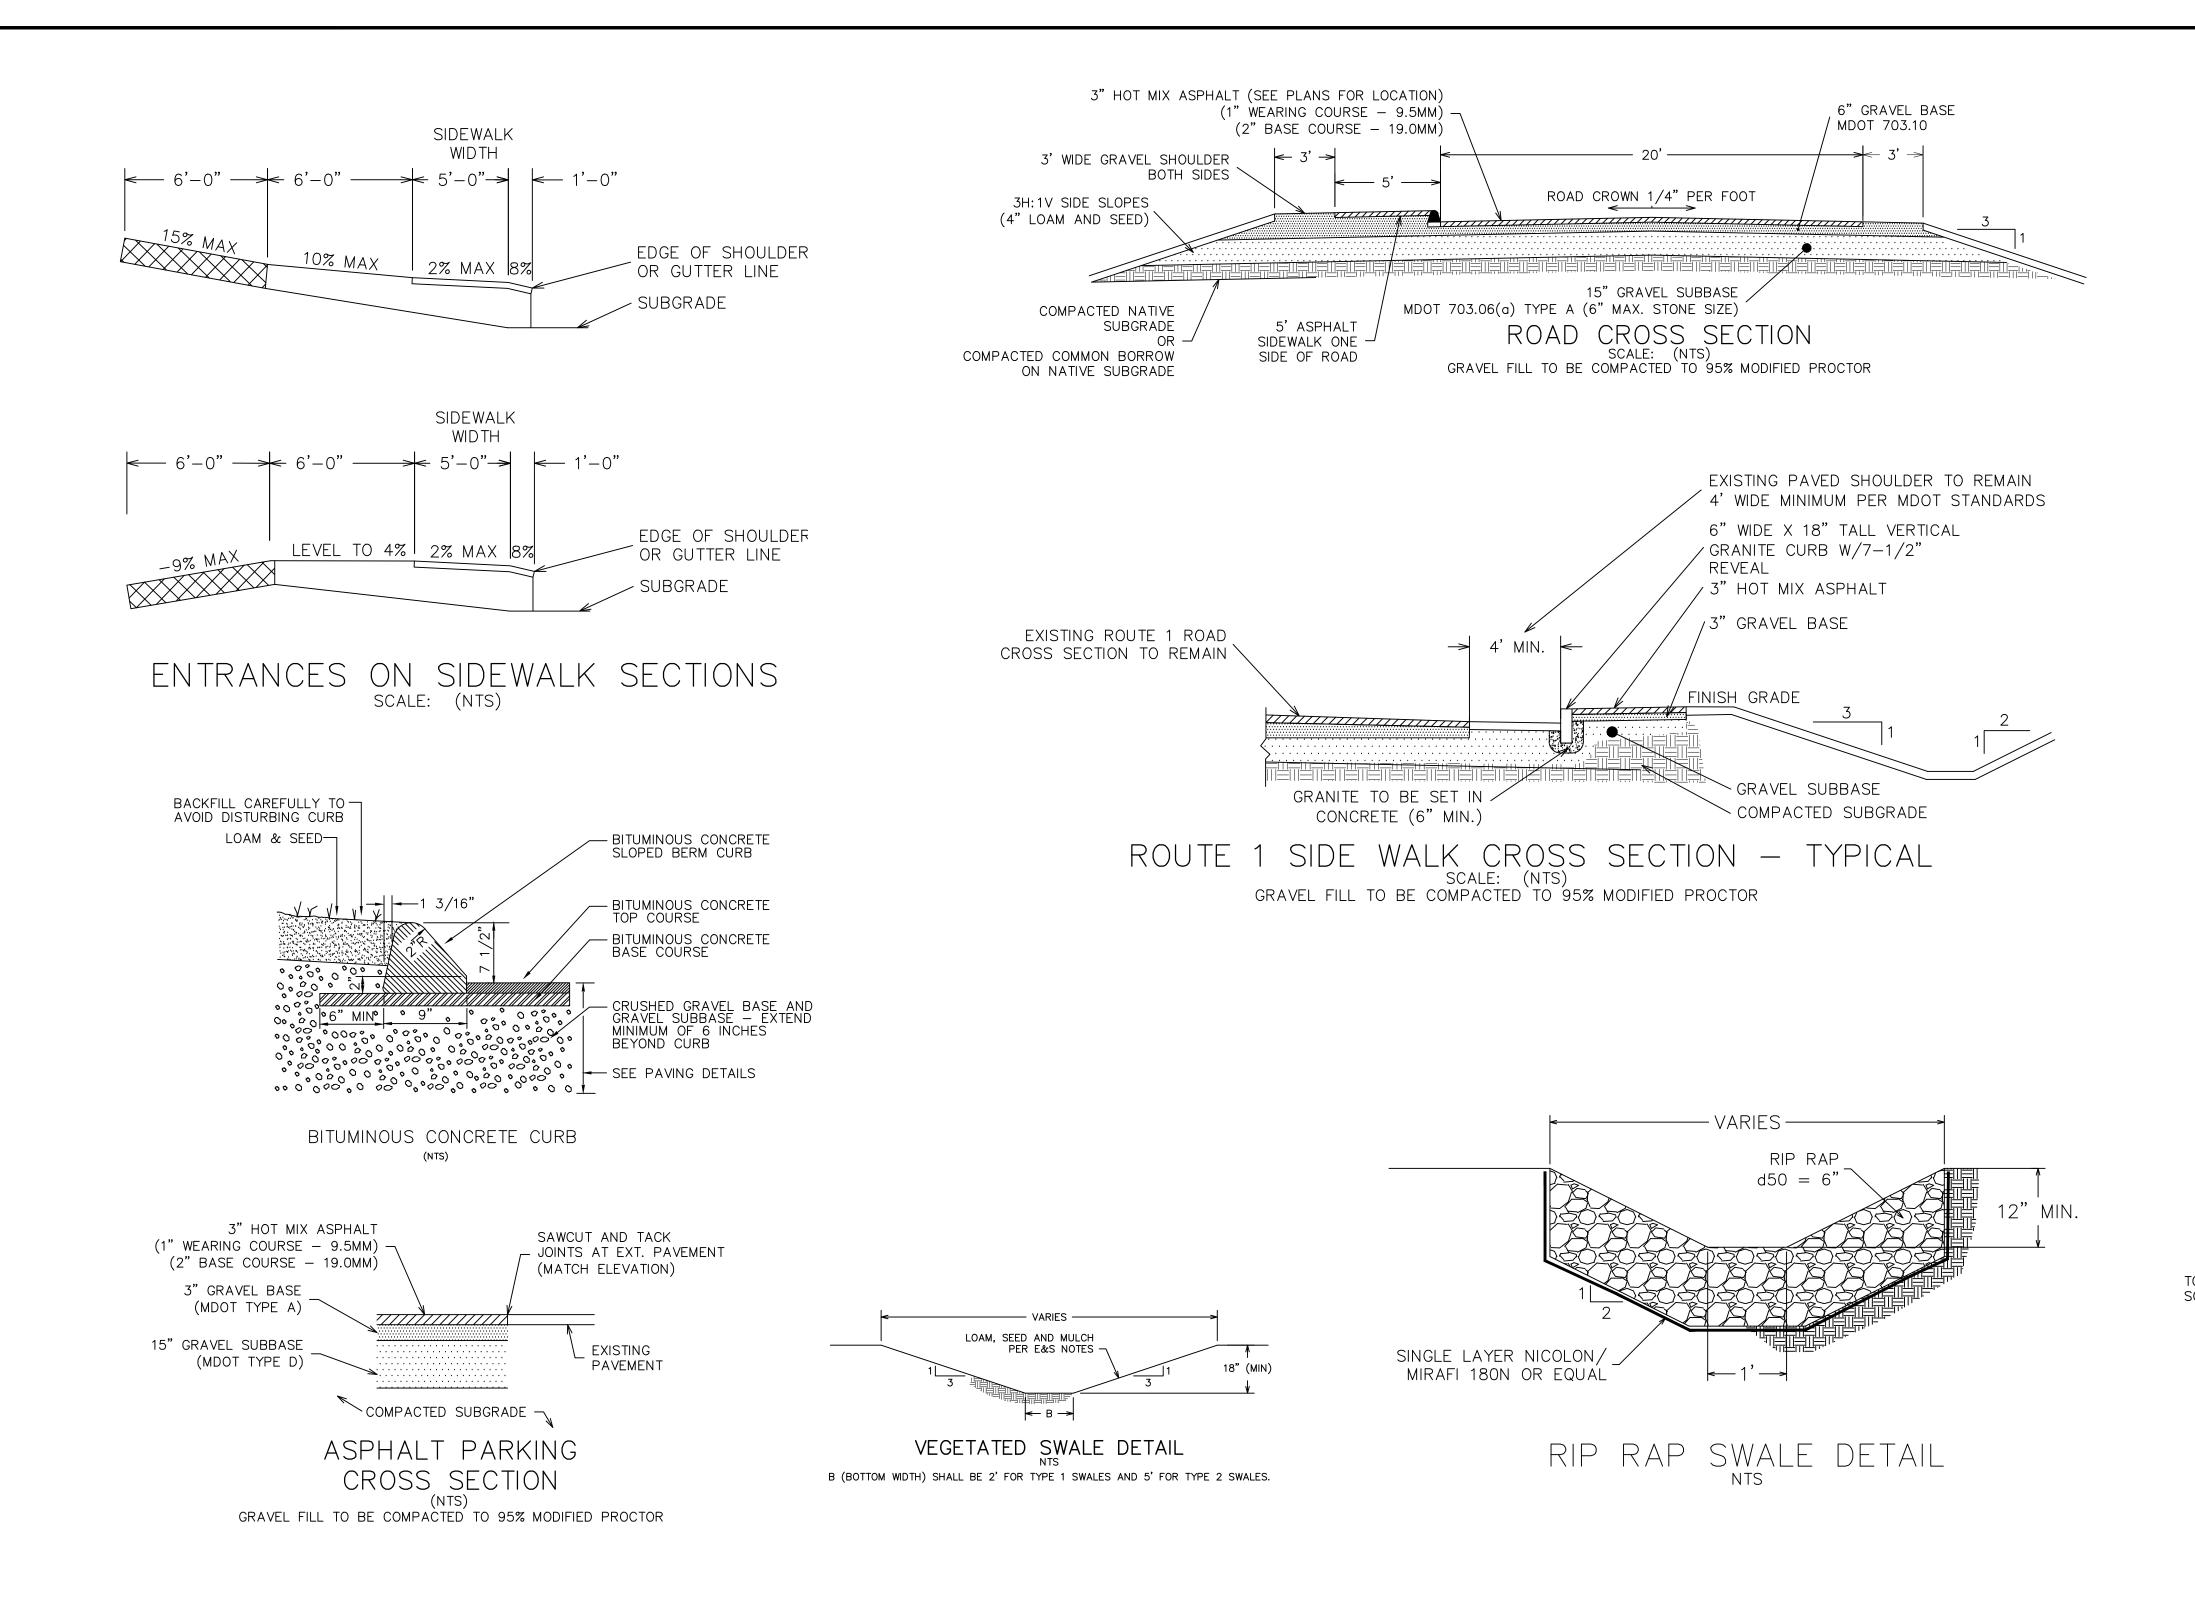


А	FINAL PLAN REV
NO.	DESCRIPTION
	REVISIONS

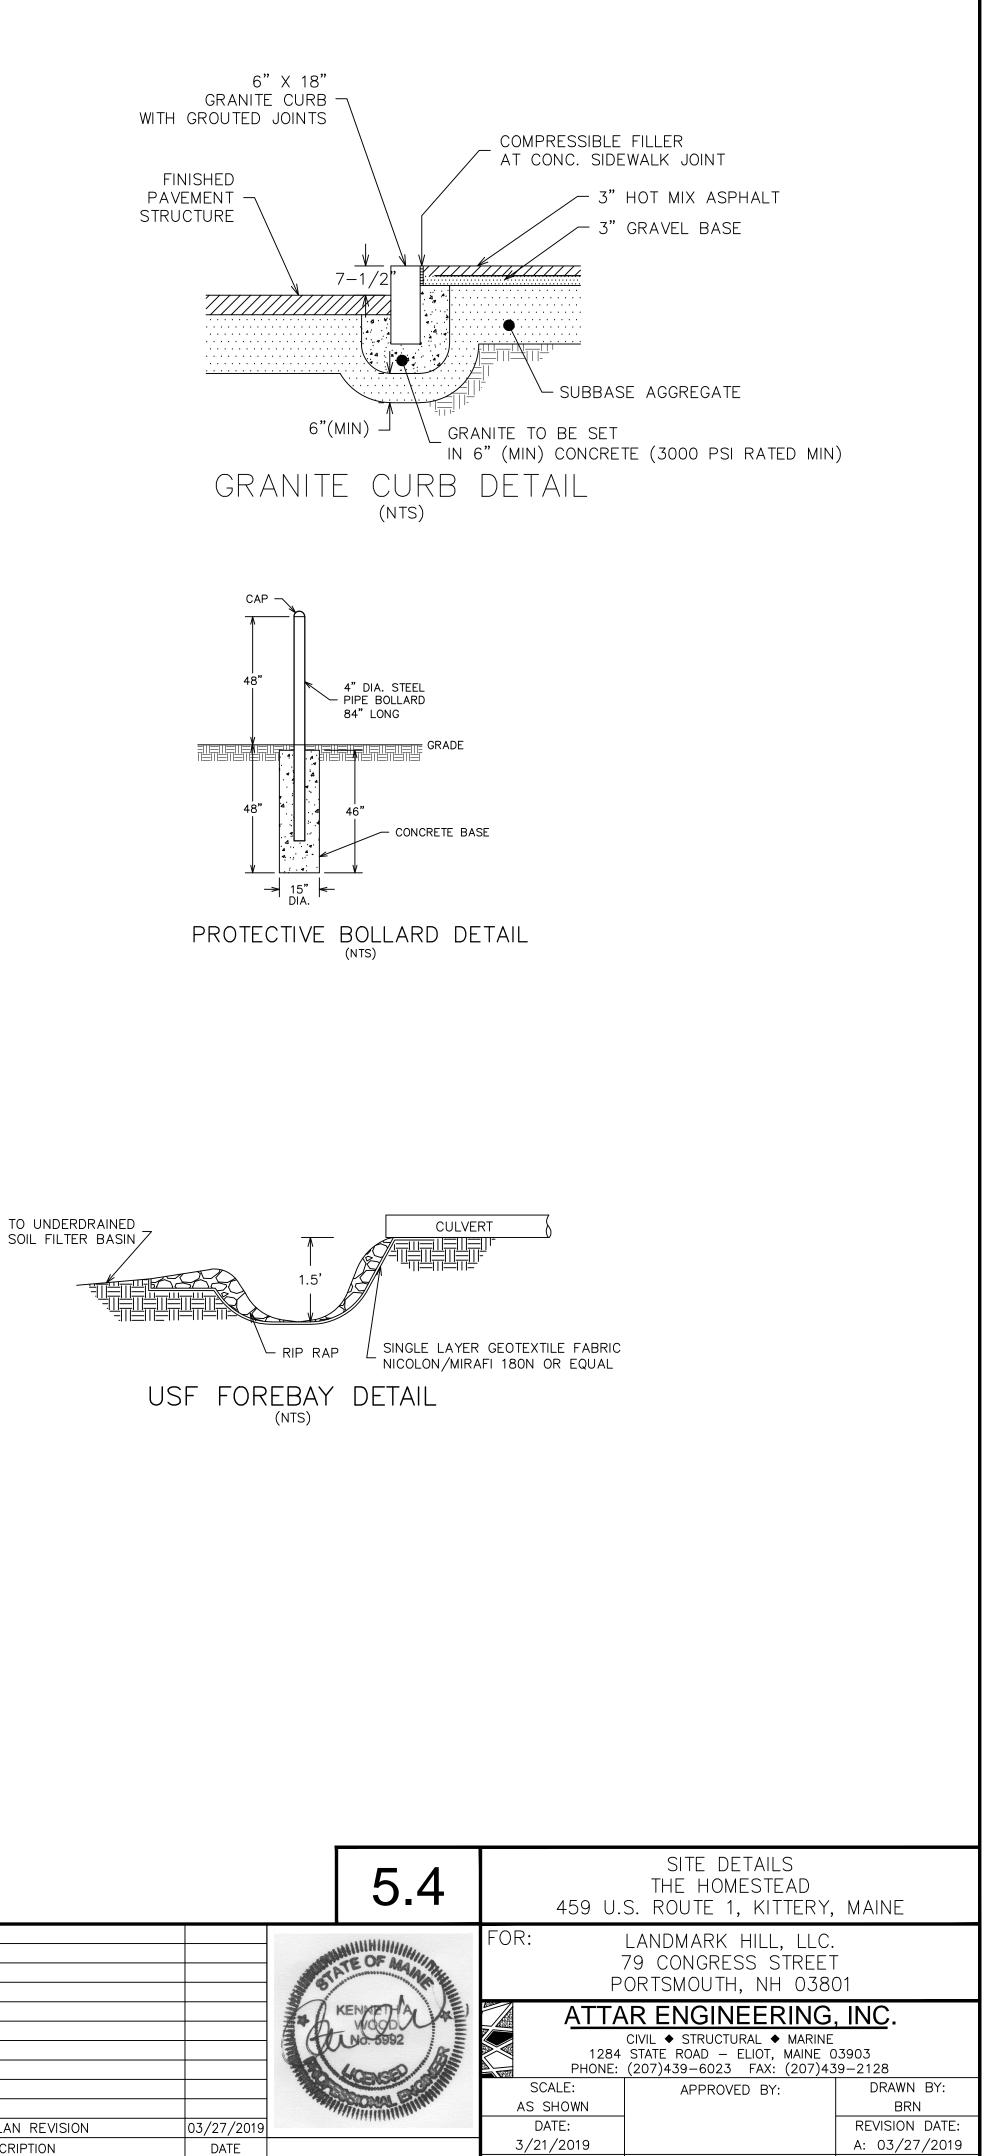


JOB NO: C052-19 FILE: THE HOMESTEAD DET.DWG

SHEET: 5.4

MAP 60 / IOT 24

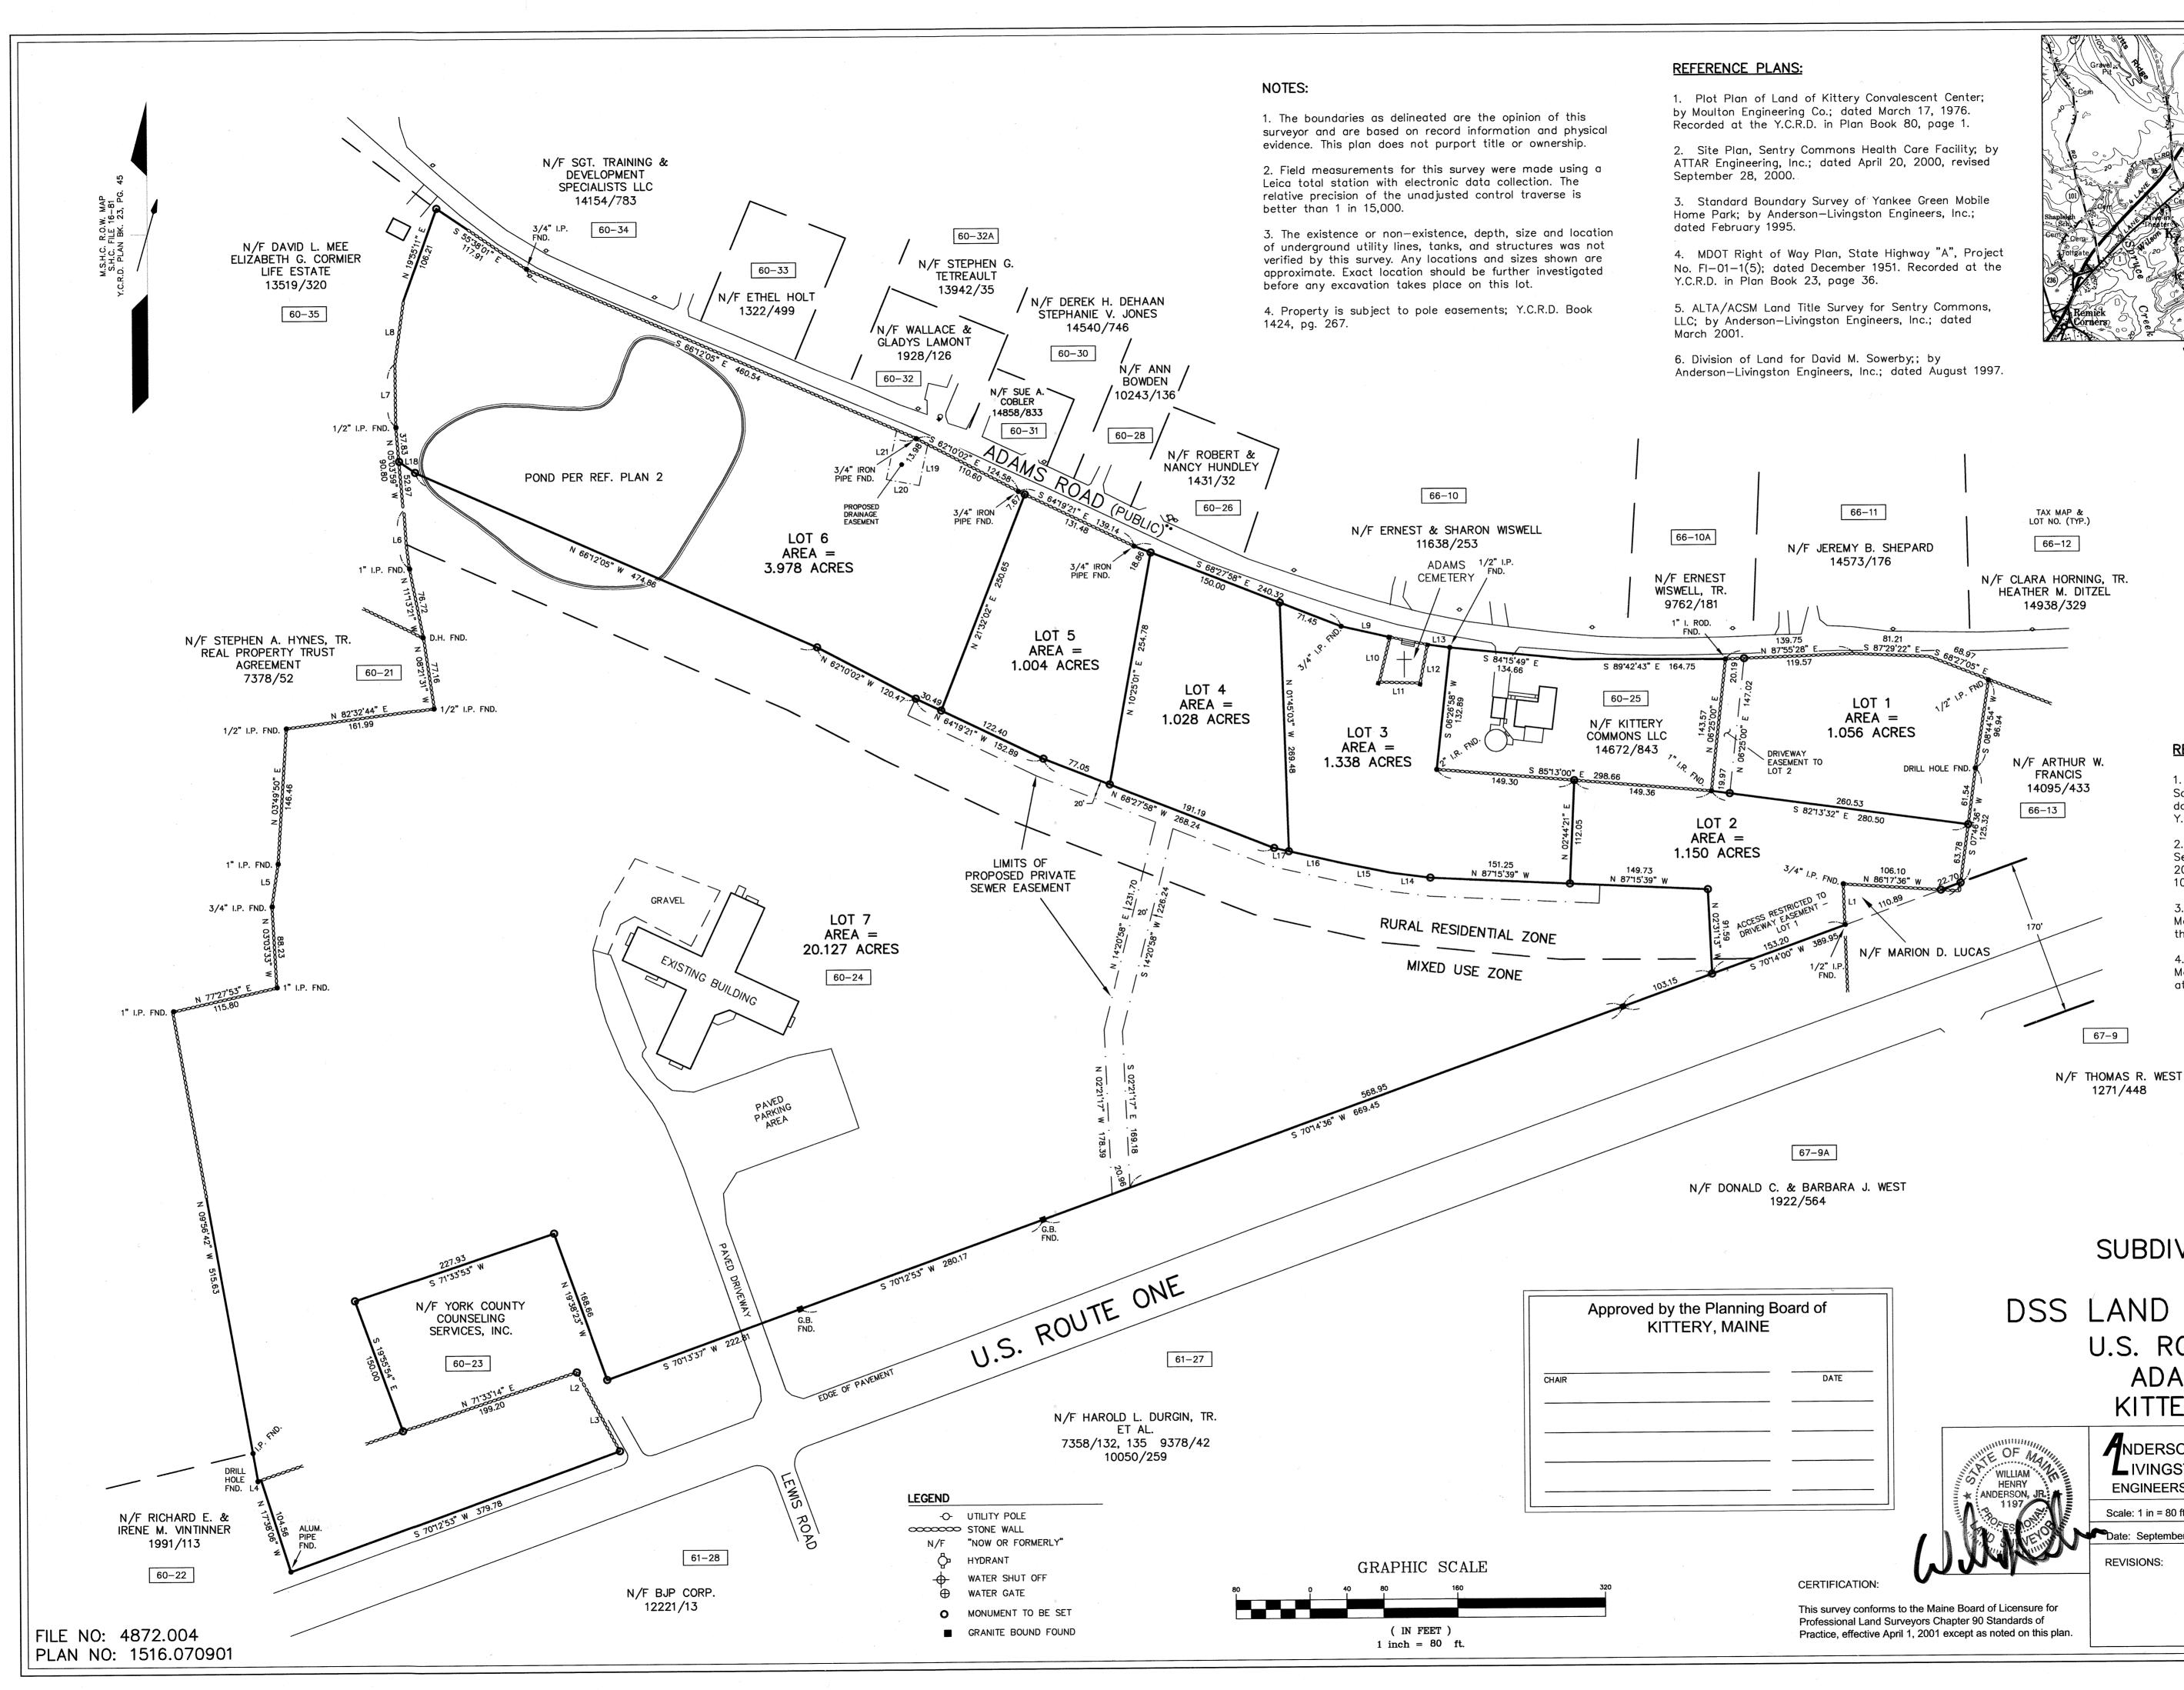

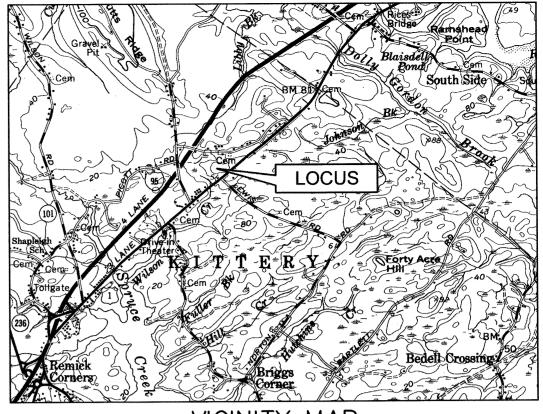

## VICINITY MAP

	BEARING TABLE					
LINE	BEARING	DIST				
L1	S 01°57'16" E	44.39				
L2	S 28'20'00" E	19.58				
L3	S 28°07'30" E	77.88				
L4	S 81'12'20" W	3.43				
L5	N 08'34'48" E	46.62				
L6	N 05°11'57" W	63.24				
L7	N 00°21'24" W	68.54				
L8	N 08°05'53" E	68.69				
L9	S 77°06'20" E	54.19				
L10	S 13*46'22" W	50.12				
L11	S 88"11'01" E	44.40				
L12	N 11'00'33" E	42.51				
L13	S 82°23'52" E	24.39				
L14	N 82°23'52" W	43.83				
L15	N 78'21'23" W	52.97				
L16	N 77°06'20" W	59.39				
L17	N 77°06'20" W	16.40				
L18	N 55'38'01" W	21.06				
L19	S 12°14'31" W	45.25				
L20	N 79'30'24" W	36.02				
L21	N 12°14'31" E	54.72				

## **REFERENCE DEEDS:**

1. David M. Sowerby and Suzanne Sowerby to DSS Land Holdings, LLC; dated March 28, 1996. Recorded at the Y.C.R.D. in Book 7784, page 66.

2. Arnold F. & Jean S. Dickinson to Sentry Commons, LLC; dated July 28, 2000. Recorded at the Y.C.R.D. in Book 10147, page 184.


3. Marion D. Lucas to the State of Maine; dated April 24, 1952. Recorded at the Y.C.R.D. in Book 1205, page 527.


4. Rose E. Adams to the State of Maine; dated March 13, 1952. Recorded at the Y.C.R.D. in Book 1204, page 324.

		SUBDIVISION	N PLAN
anning Board of MAINE DATE			ROAD
	WILLIAM HENRY	NDERSON IVINGSTON ENGINEERS, INC.	Suite 401 Cottage Place 433 II U.S. Route One York, Maine 03909
	1197	Scale: 1 in = 80 ft.	
	TO ESTERNE	Date: September 14, 2007	OWNER:
CERTIFICATION:	WWW	REVISIONS:	DSS Land Holdings, LLC P.O. Box 242 York, ME 03909
	to the Maine Board of Licensure for		
	rrveyors Chapter 90 Standards of ril 1, 2001 except as noted on this plan.		Sheet 1 of 1 6.1

17 16

C104+23 14M

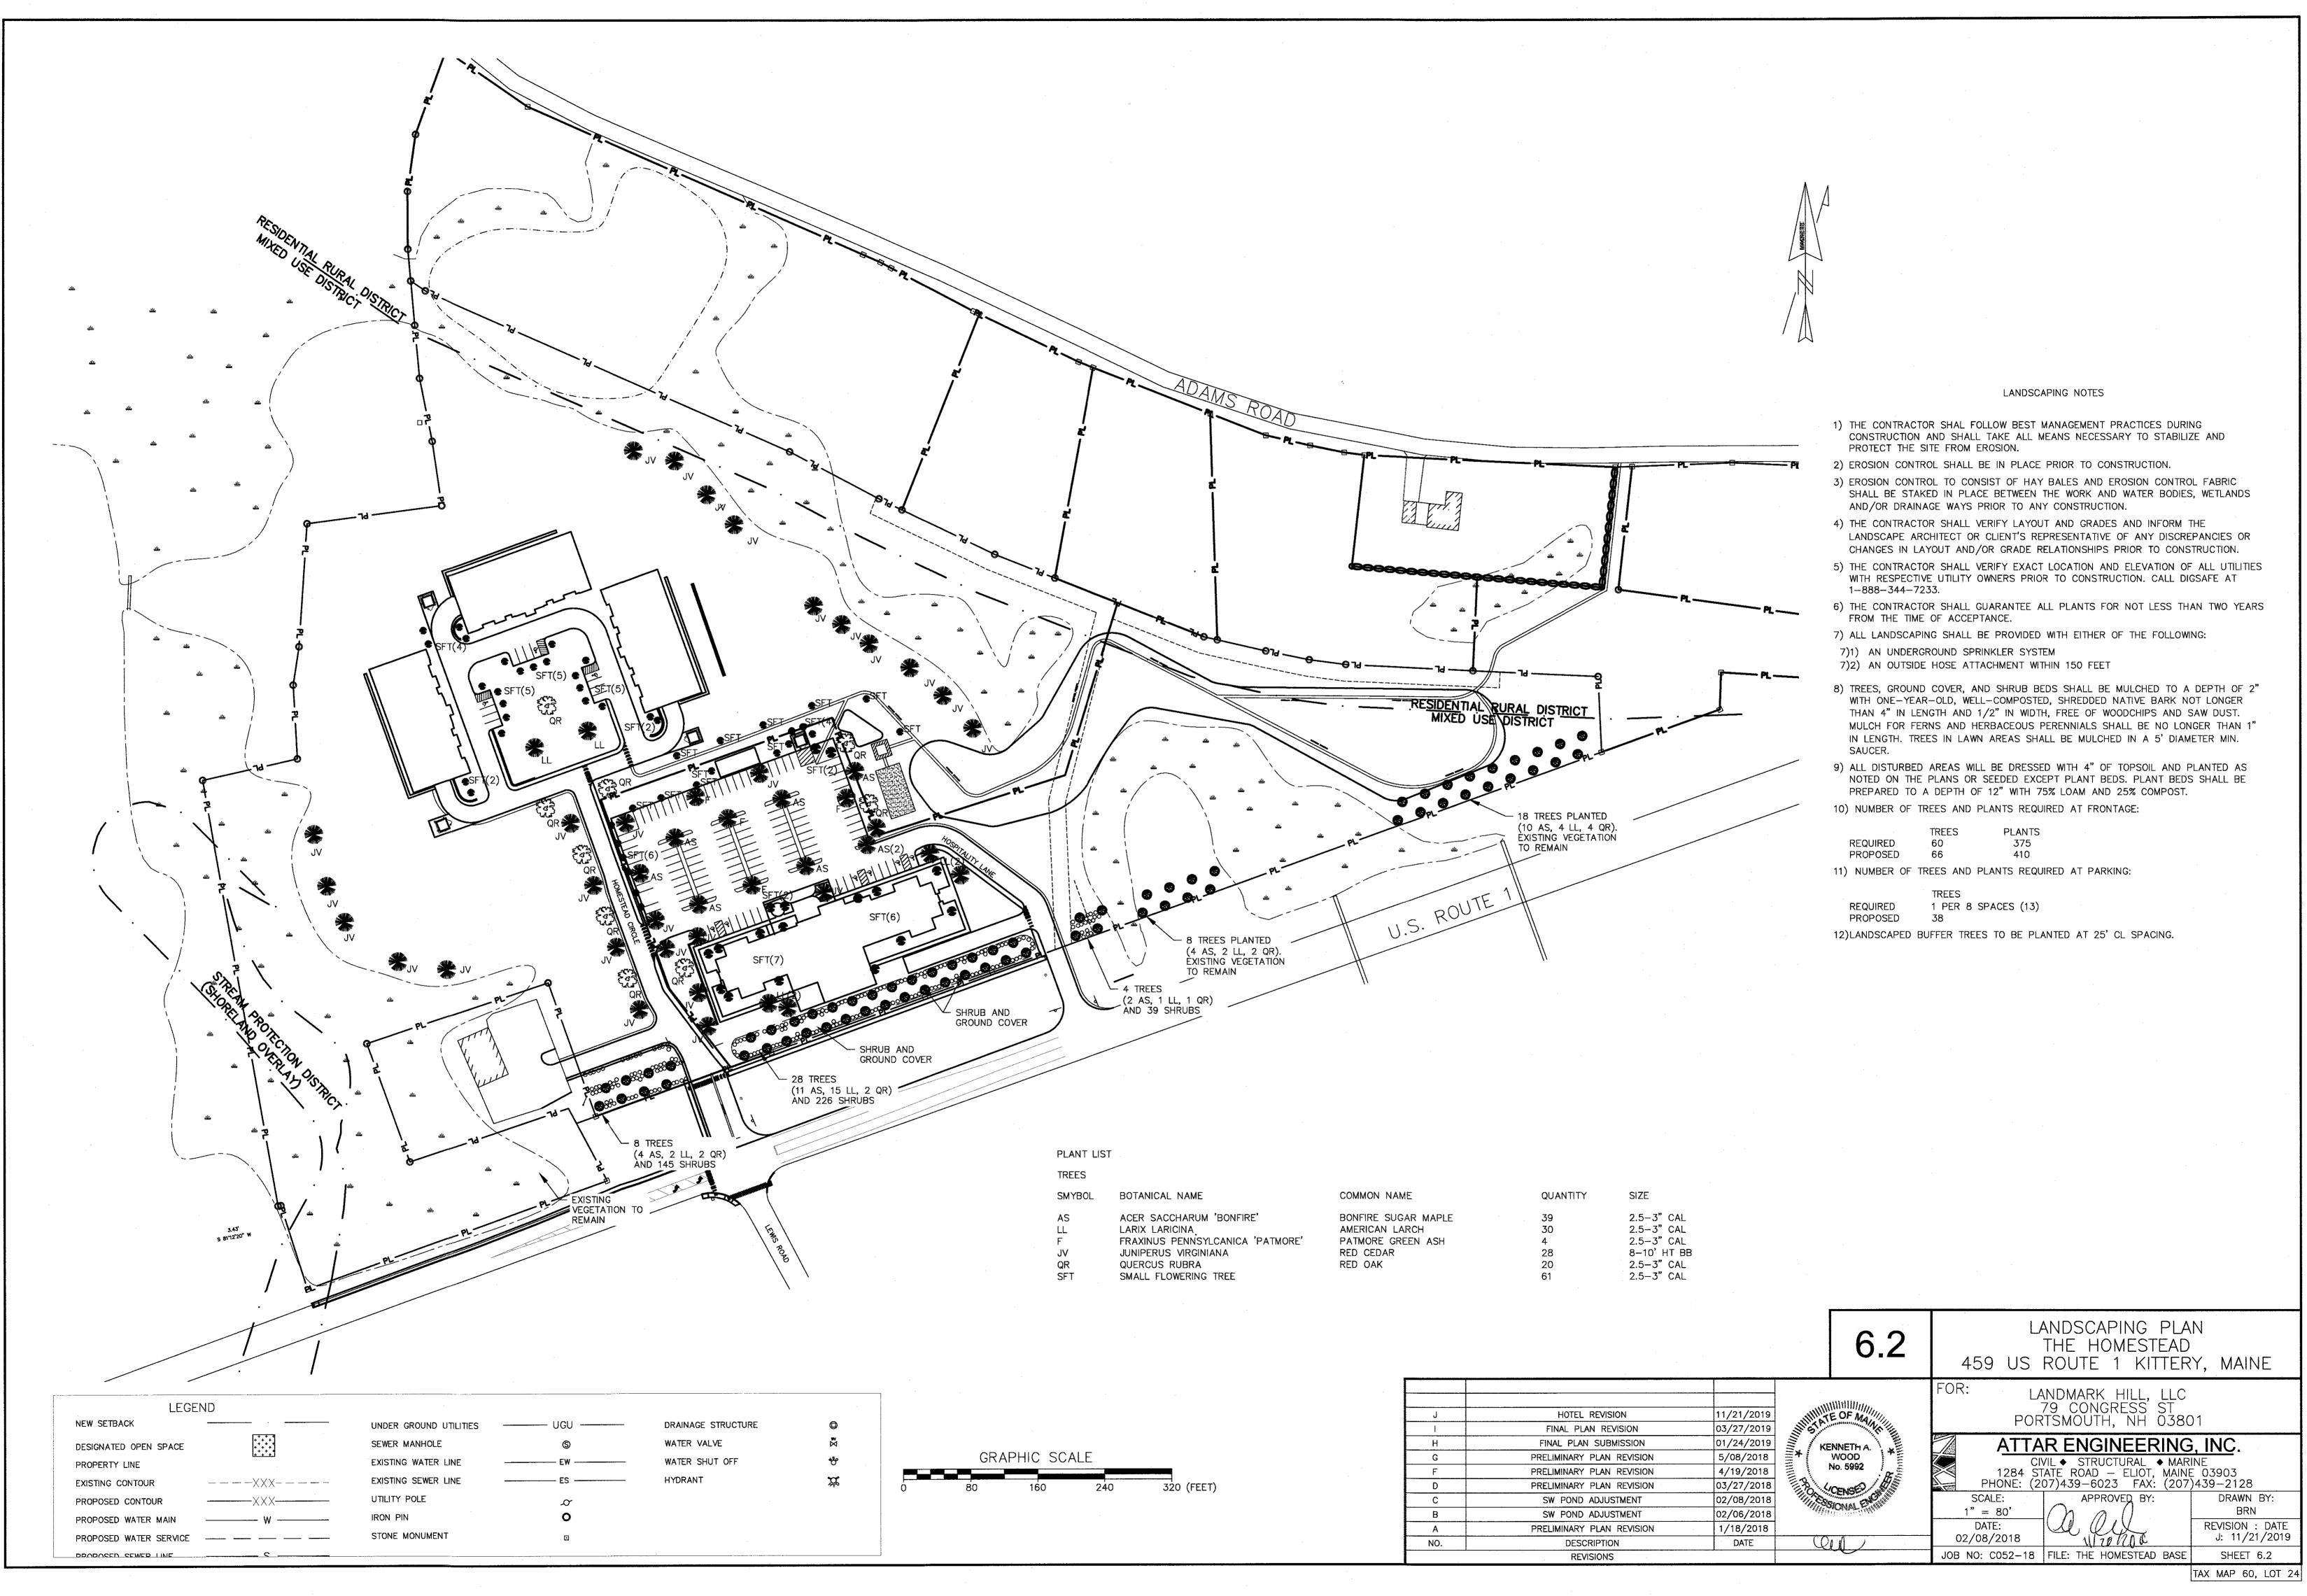


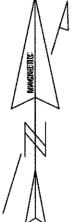


10)	NUMBER	UF	IKELS	AND	PLAN15	REQUIRED	AI	FRONTA	GE

			IREE	S	PL	ANTS		
RE	QUIRED		60			375		
PF	ROPOSED	)	66		4	410		
1) N	IUMBER	OF	TREES	AND	PLANTS	REQUIRED	ΑT	P
			TDE					

1	PER	8	SPACES	(13)

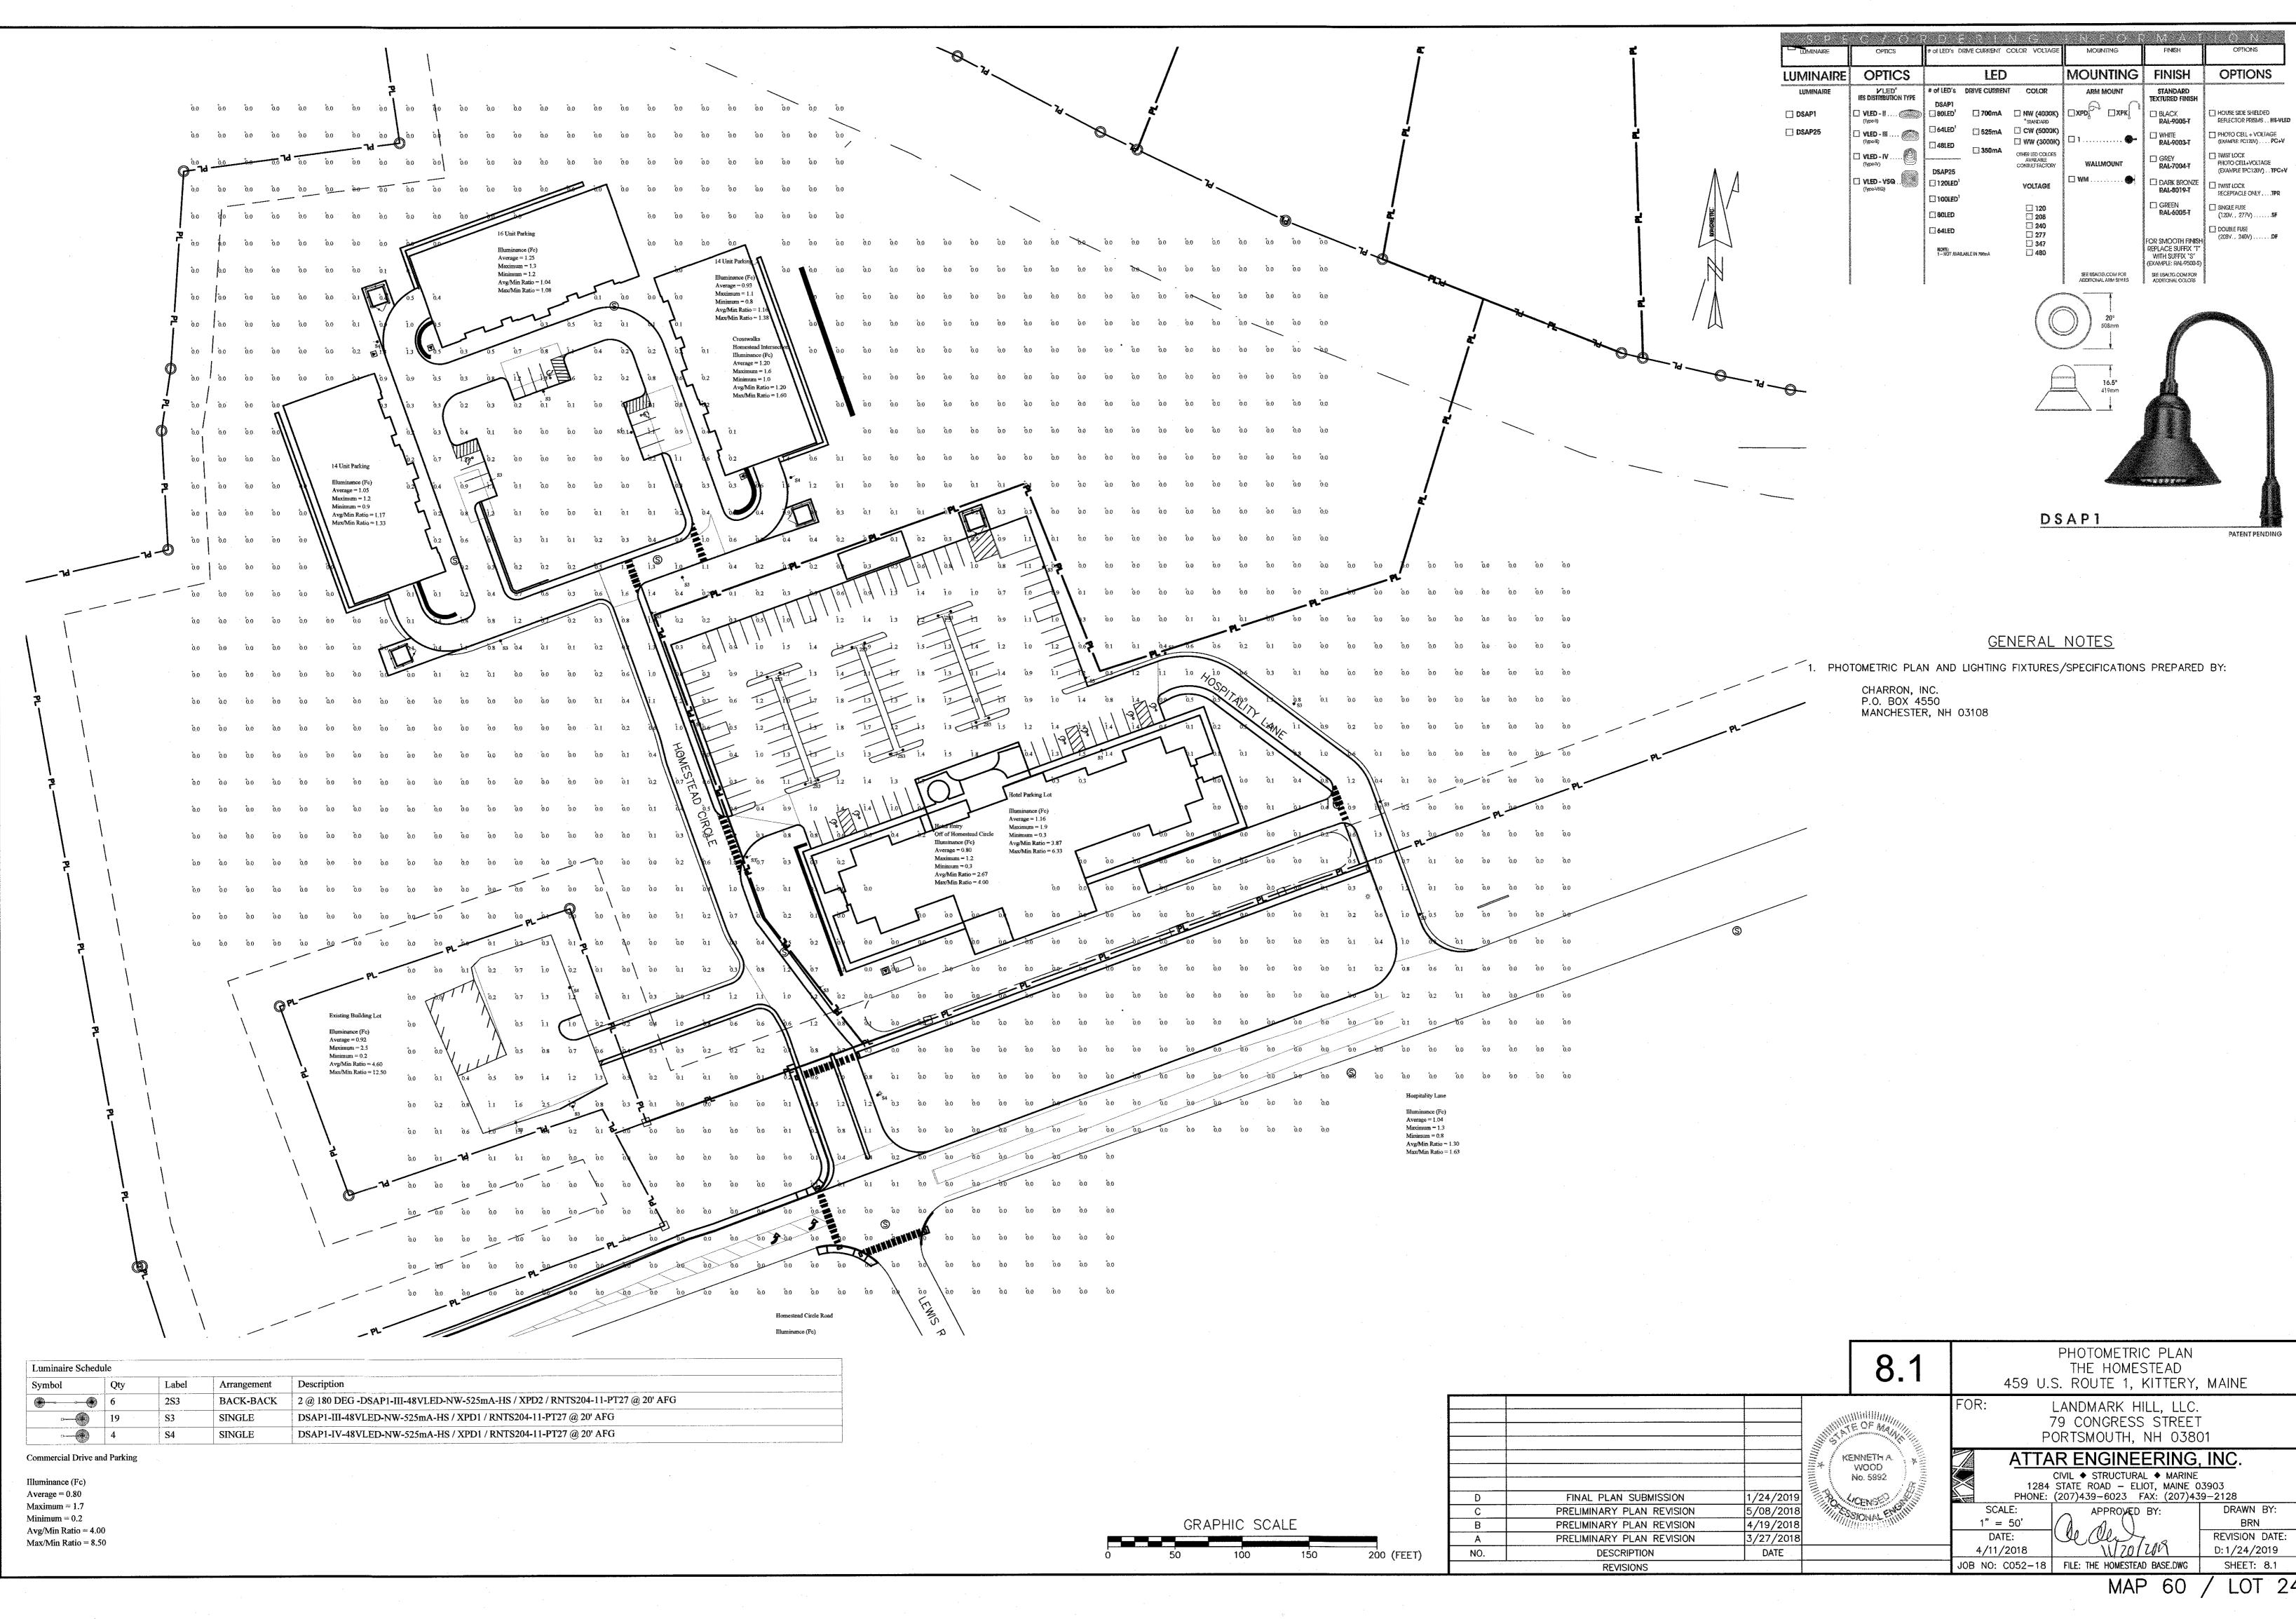

		8.1	459 U.	PHOTOMETRIC PLAN THE HOMESTEAD S. ROUTE 1, KITTERY,	MAINE
	· · · · · · · · · · · · · · · · · · ·	THE OF MANNE		LANDMARK HILL, LLC. 79 CONGRESS STREET ORTSMOUTH, NH 0380	-
FINAL PLAN SUBMISSION	1/24/2019	KENNETH A. WOOD No. 5992	1284	CIVIL   STATE ROAD - ELIOT, MAINE (207)439-6023 FAX: (207)430	)3903
ELIMINARY PLAN REVISION	5/08/2018		SCALE:	APPROVED BY:	DRAWN BY:
ELIMINARY PLAN REVISION	4/19/2018	A COMPLETE STATE	1" = 50'	(A. M. ()	BRN
ELIMINARY PLAN REVISION	3/27/2018		DATE:	Celler 7 . 8	REVISION DATE:
DESCRIPTION	DATE		4/11/2018	WZOIUN	D:1/24/2019
REVISIONS			JOB NO: C052-18	FILE: THE HOMESTEAD BASE.DWG	SHEET: 8.1

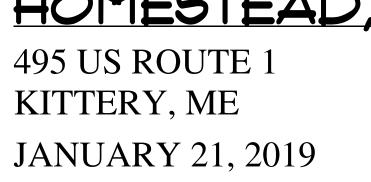


# HOMESTEAD, LLC

PROPOSED 12 UNIT MULTI-FAMILY FOR:

VINYL BOARD AND BATTEN

SWATCHES FOR COLOR REFERENCE ONLY: REFER TO TO MATERIAL DESCRIPTION

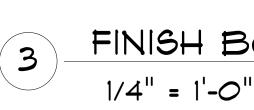

FINISH BOARD


WINDOWS - ALSIDES WHITE VINYL WINDOWS. EXTERIOR DOORS - FIBERGLASS EXTERIOR DOORS FIBERGLASS EXTERIOR FRENCH DOORS

OTHER EXTERIOR FINISHES:

## STONE VENEER COLOR



ROOF SHINGLE COLOR

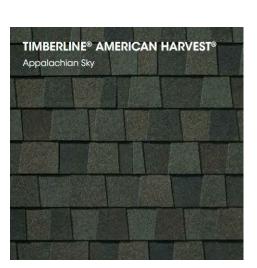

BOARD AND BATTEN


Boston Blend Ledgestone Thin Veneer consists of a wide range of colors including gray, white, tan, pink, and black. The Ledgestone pattern of stone veneer consists of thin strips of natural stone. Sold as individual stones not stone panels. Weathered colors and/or inside grain colors. Suitable for putting stone on a wood structure. STONEYARD -«LITTLETON, MAessed joints.

Weight is less than 14 lbs per square foot which allows the product to be used in construction applications

without a load bearing support.

GAF

Timberline Roofing Shingles GAF Timberline Lifetime Architectural Roofing Shingles

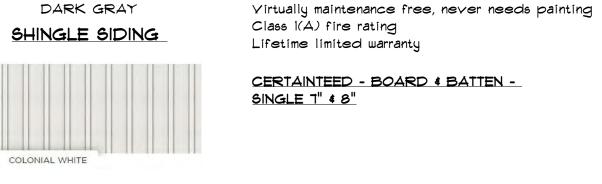

STERLING GRAY

SIDING COLOR

projection .042" thickness Virtually maintenance free, never needs painting Class I(A) fire rating Lifetime limited warranty CERTAINTEED CEDAR IMPRESSIONS STRAIGHT EDGE PERFECTUION SHINGLE VINTL SIDING 5" STRAIGHT EDGE SAWMILL SHINGLES

.042" thickness

CERTAINTEED MAINSTREET VINYL SIDING

Natural woodgrain or brushed appearance


Patented STUDfinder is designed for accurate and secure installation RigidForm 160 technology has been


DuraLock post-formed lock design 9/16" panel


tested\* to withstand wind load pressures up to 160 mph

Double 4" Woodgrain Clapboard



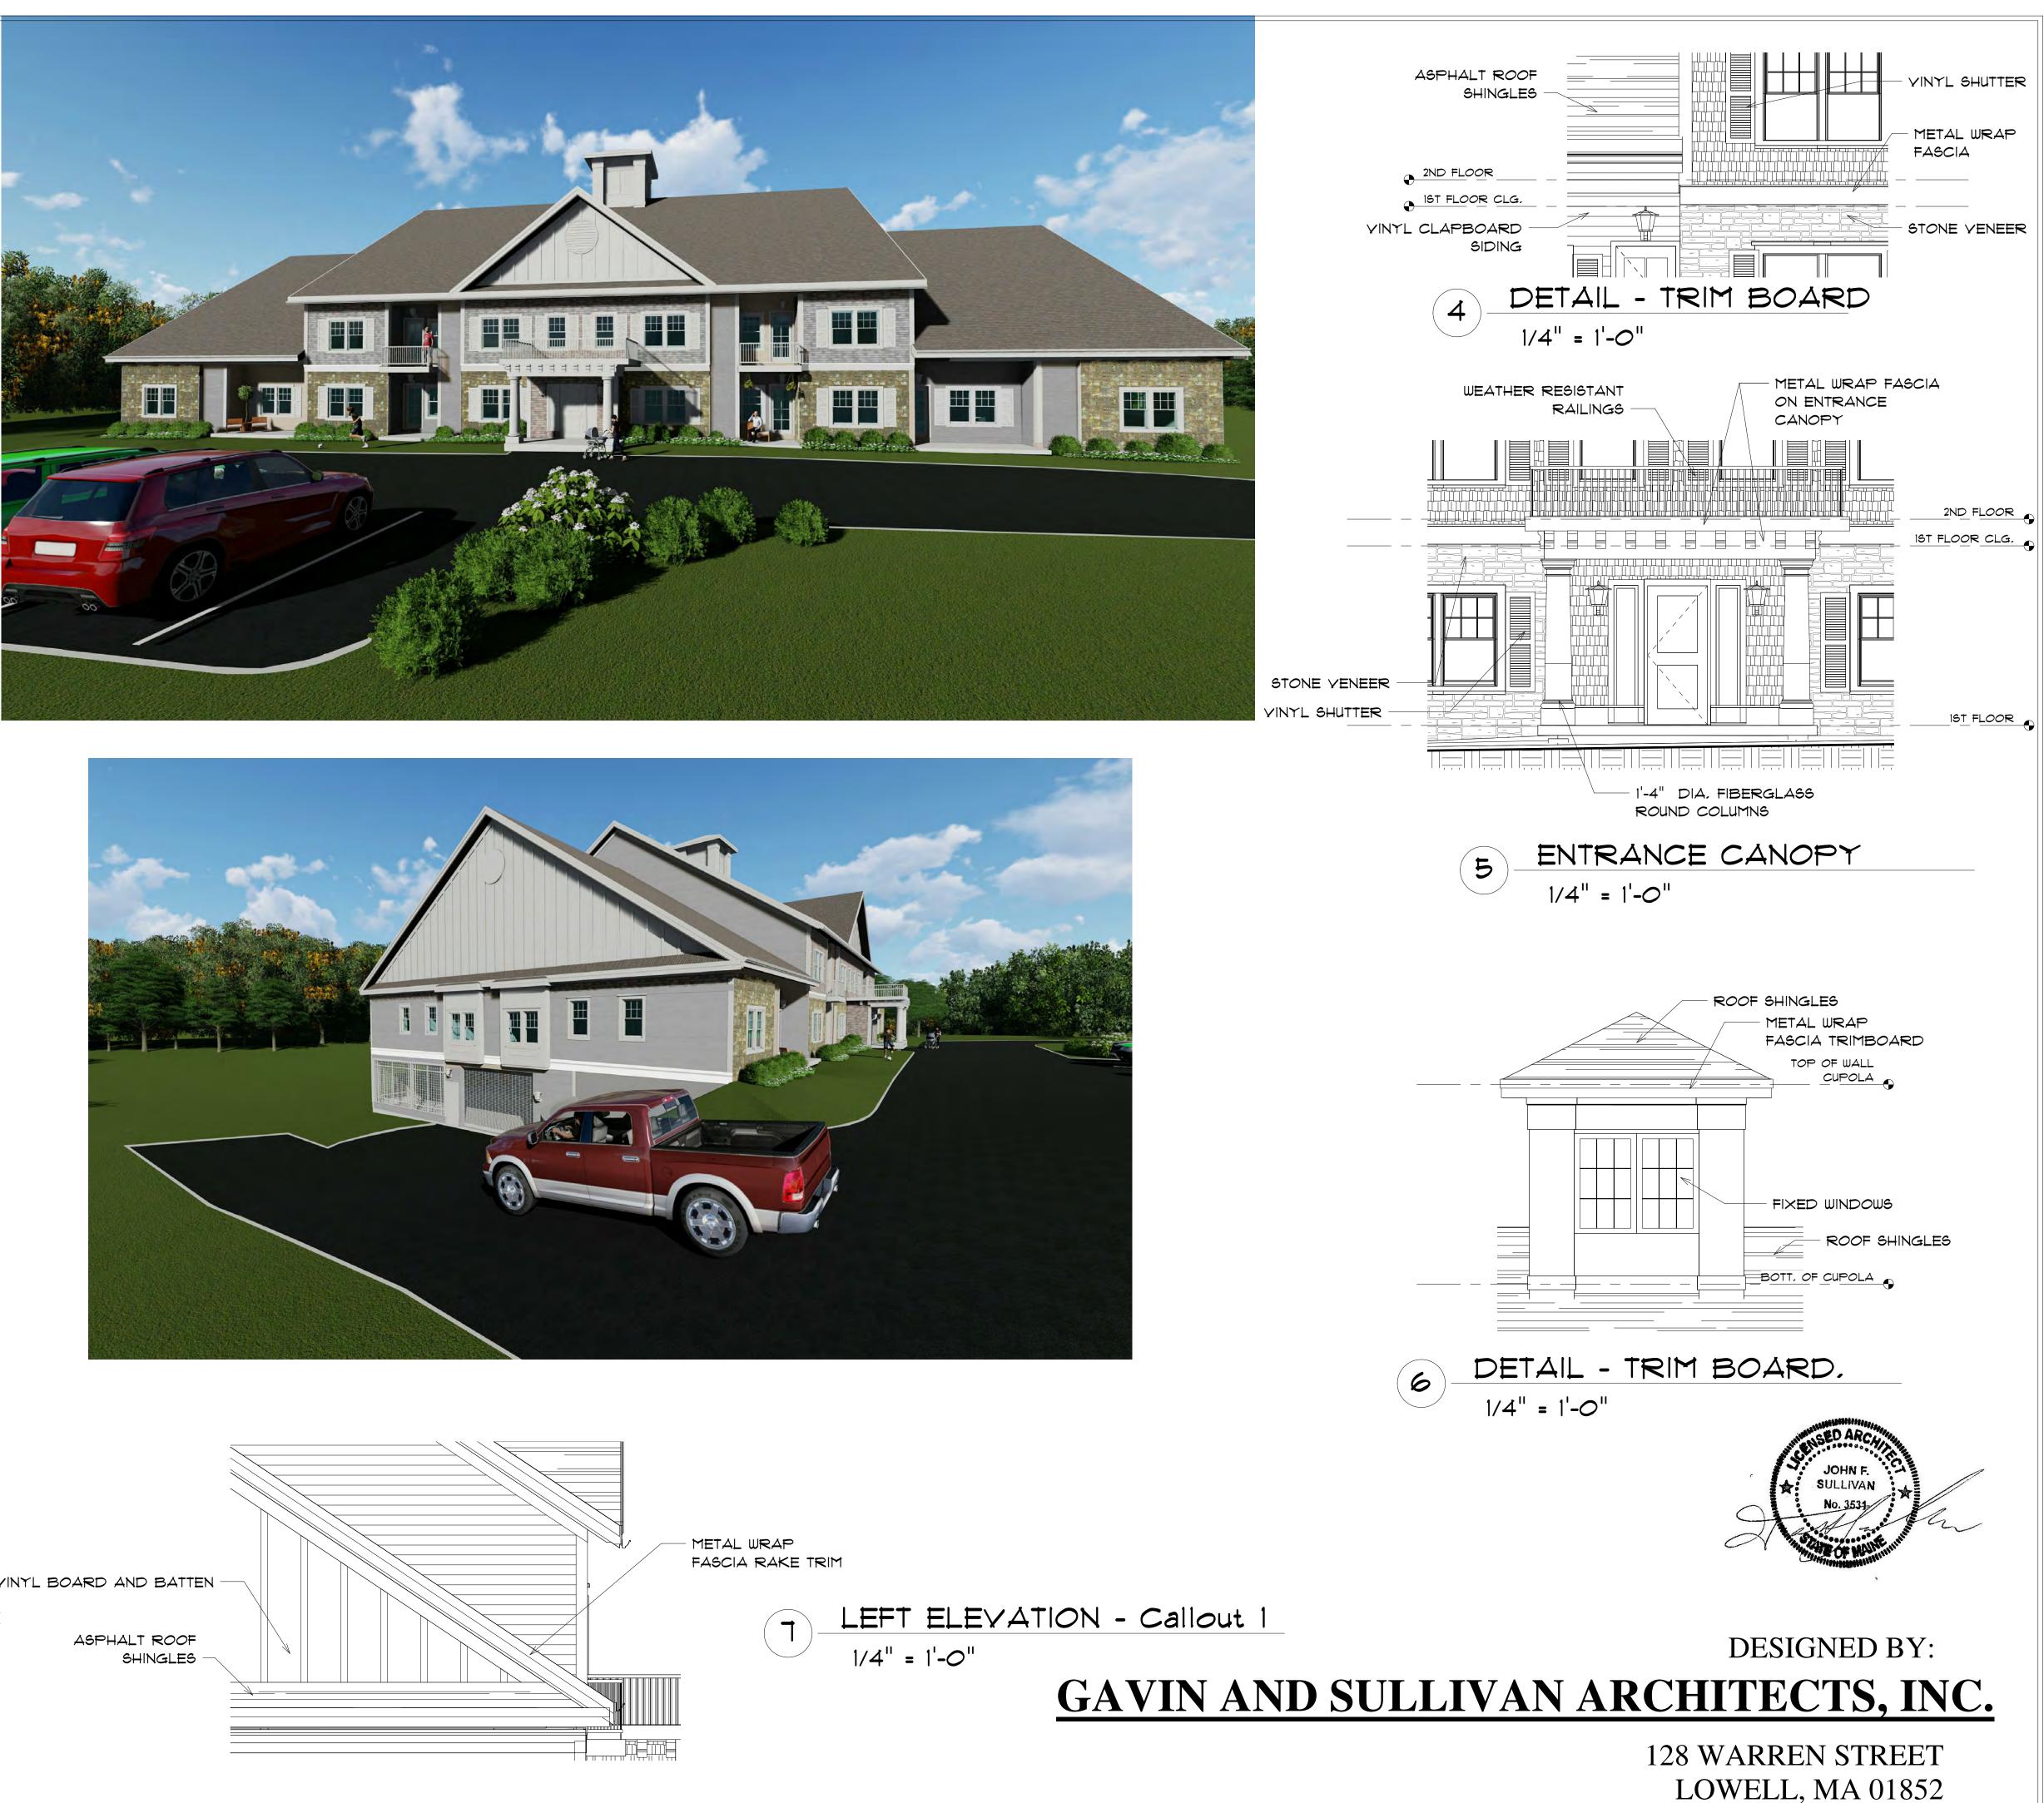

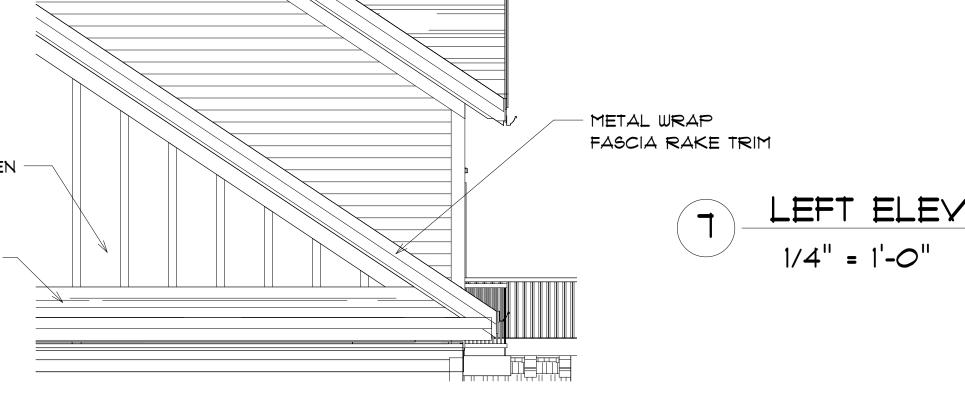

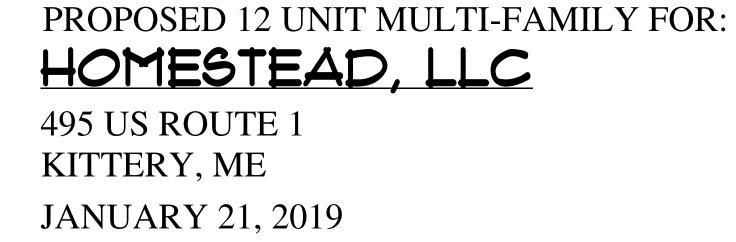

2


3/32" = 1'-0"











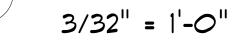

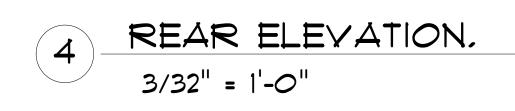


# LOWELL, MA 01852

## **DESIGNED BY: GAVIN AND SULLIVAN ARCHITECTS, INC. 128 WARREN STREET**

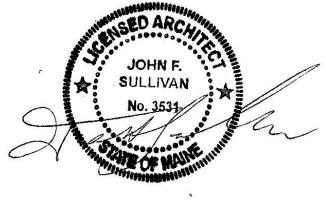




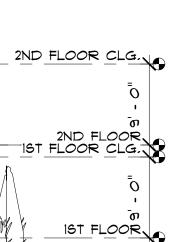


# HOMESTEAD, LLC

PROPOSED 12 UNIT MULTI-FAMILY FOR:


495 US ROUTE 1 KITTERY, ME JANUARY 21, 2019

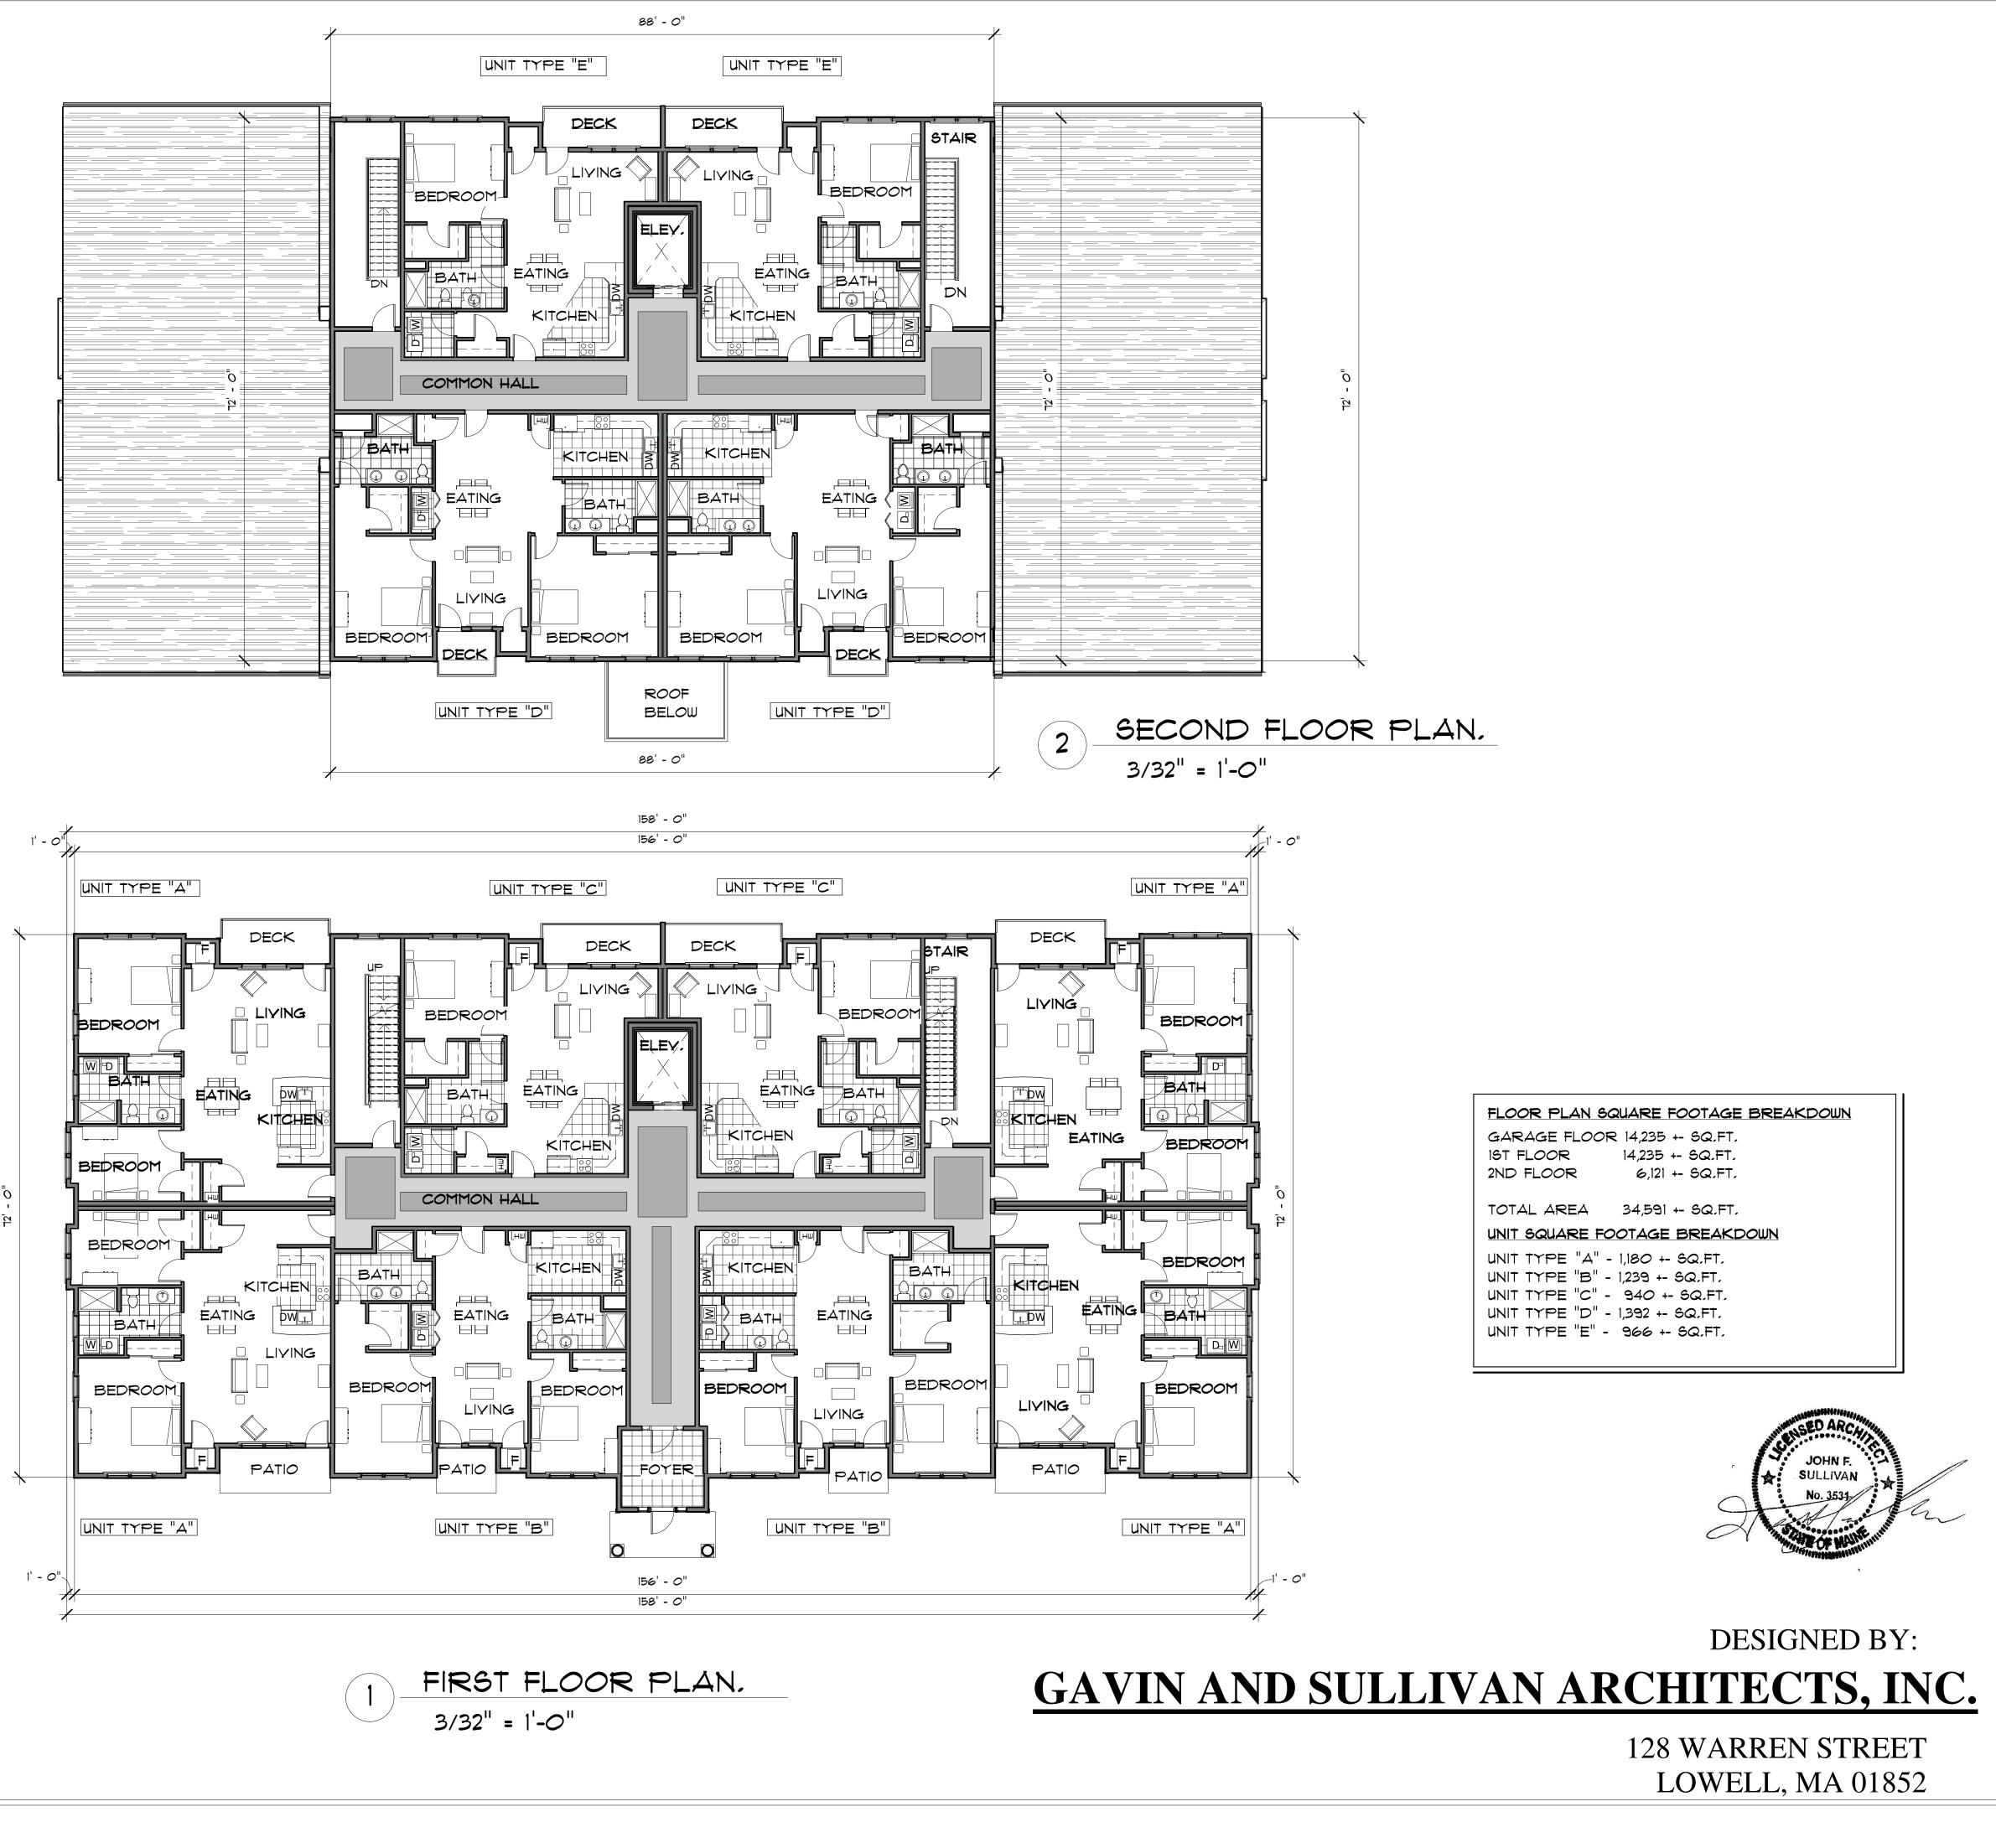

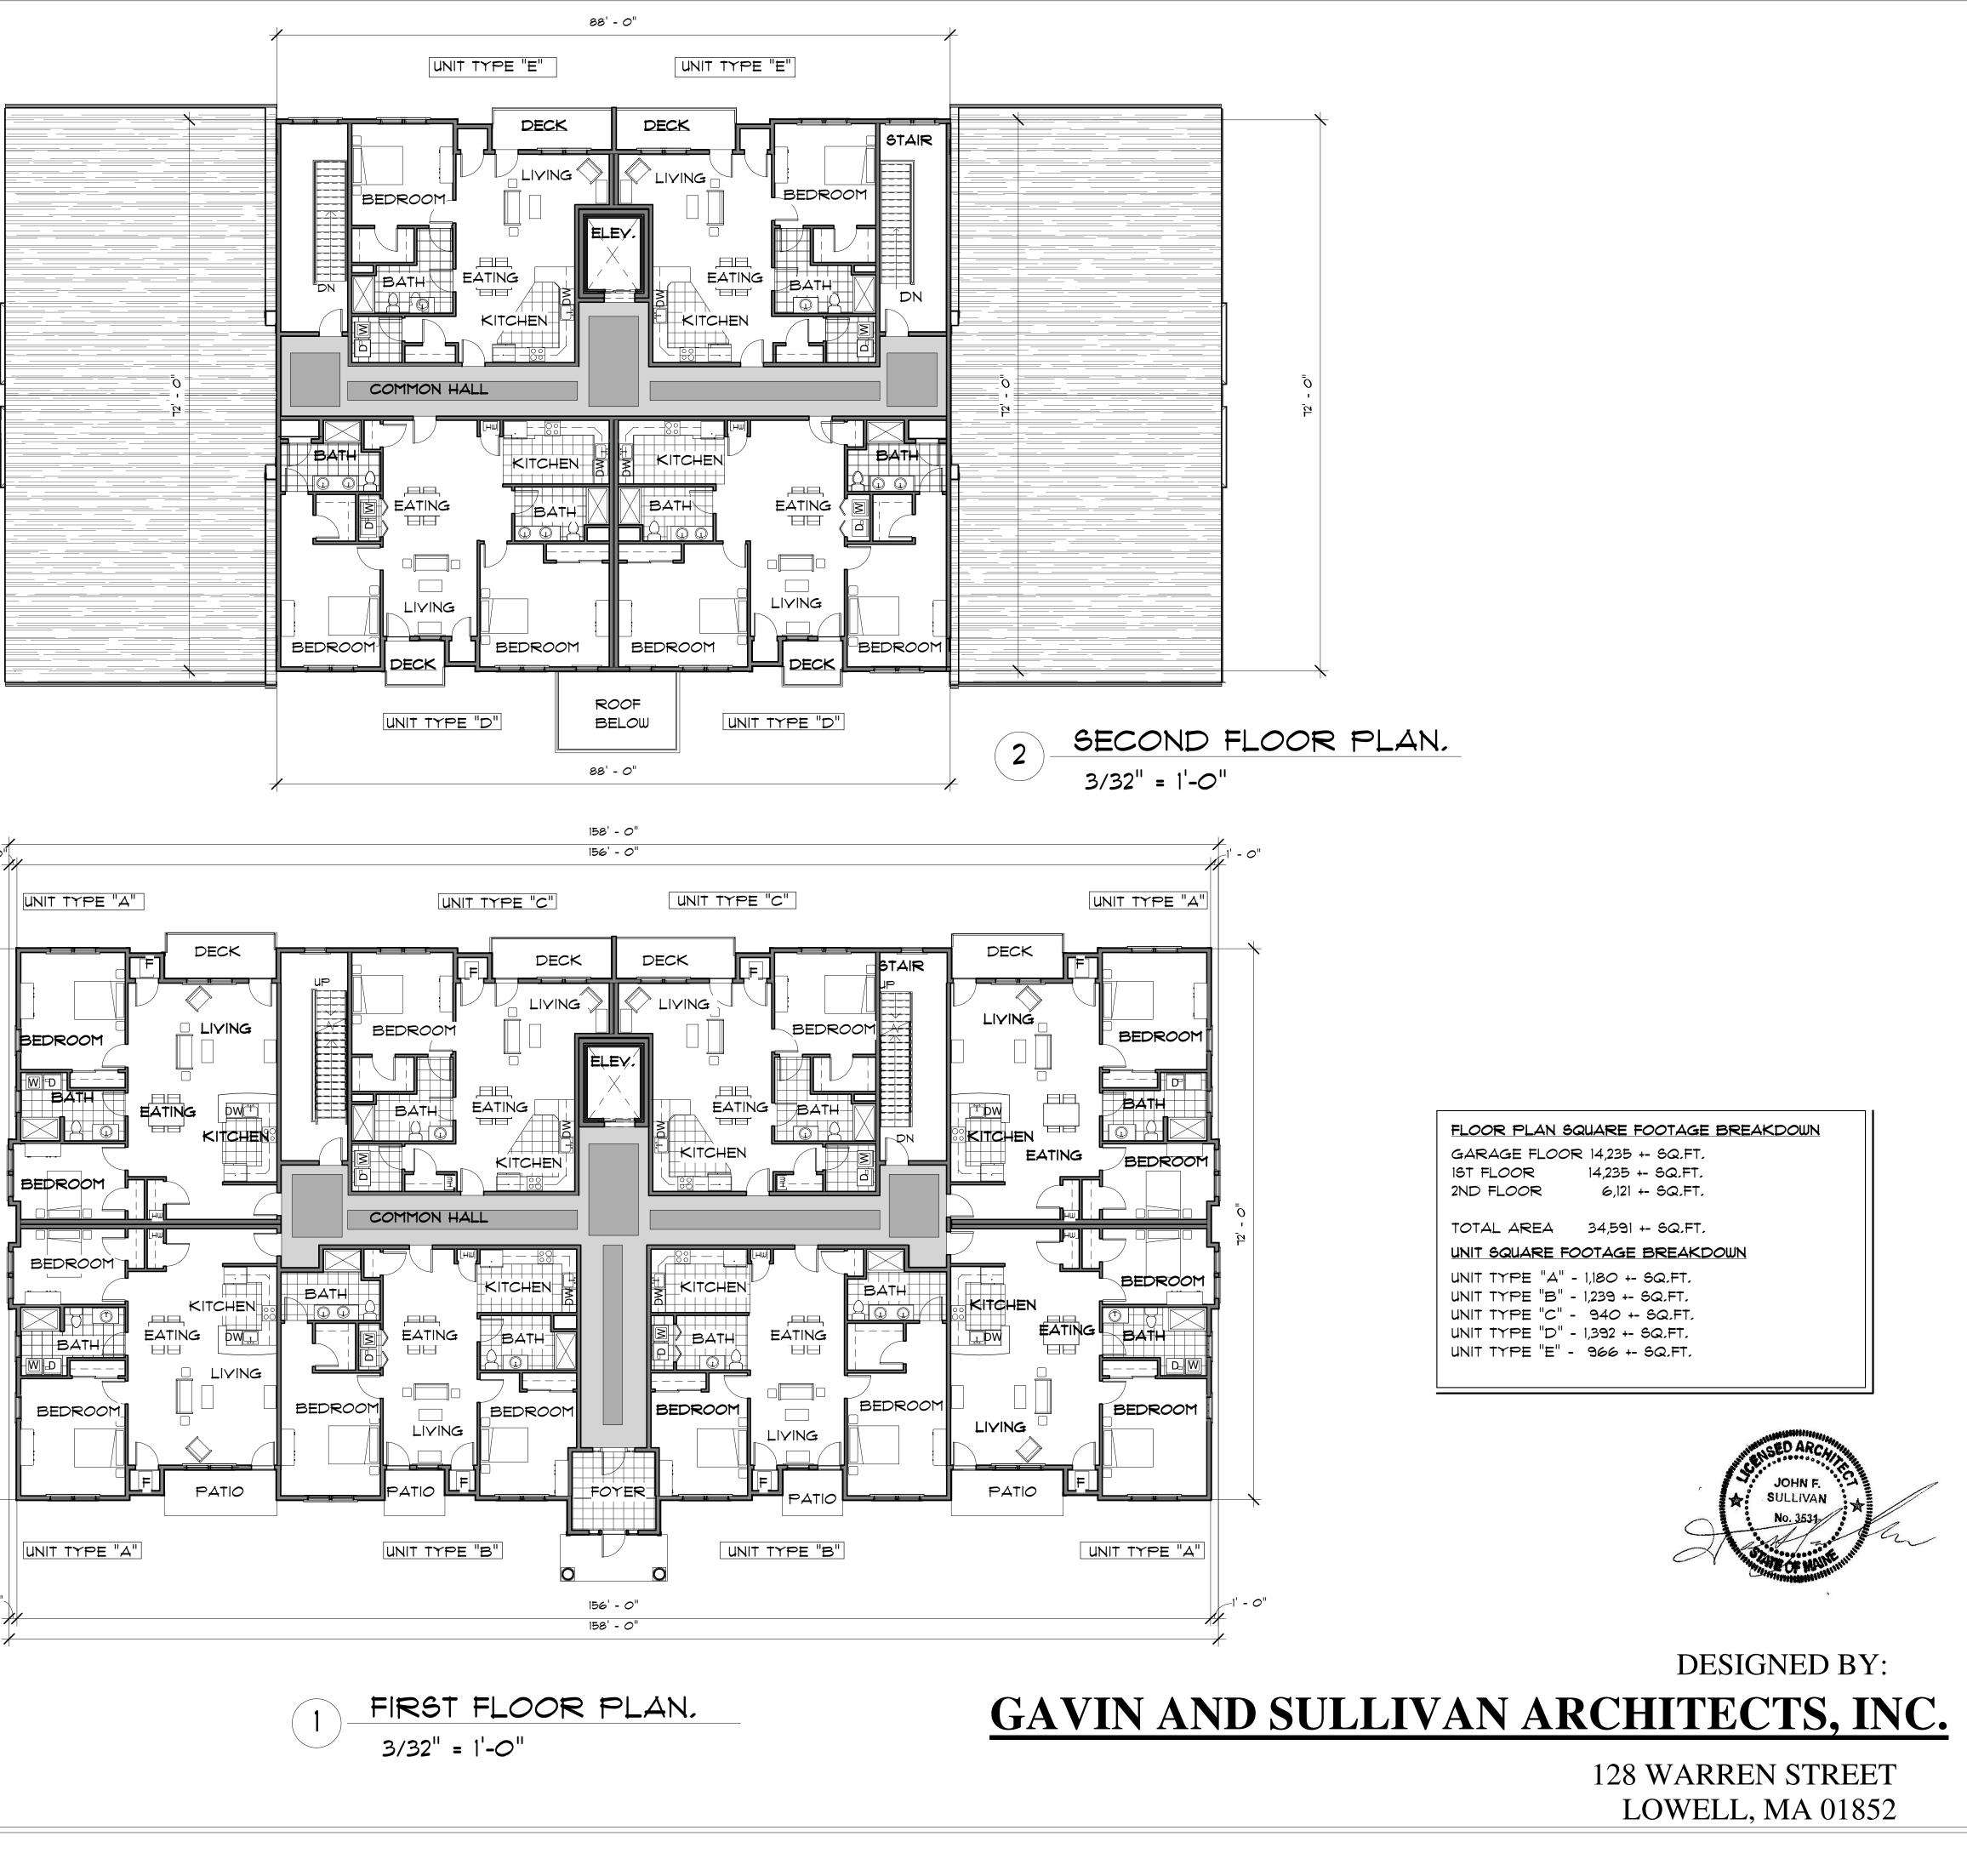

495 US ROUTE 1 KITTERY, ME JANUARY 21, 2019


PROPOSED 12 UNIT MULTI-FAMILY FOR: HOMESTEAD, LLC

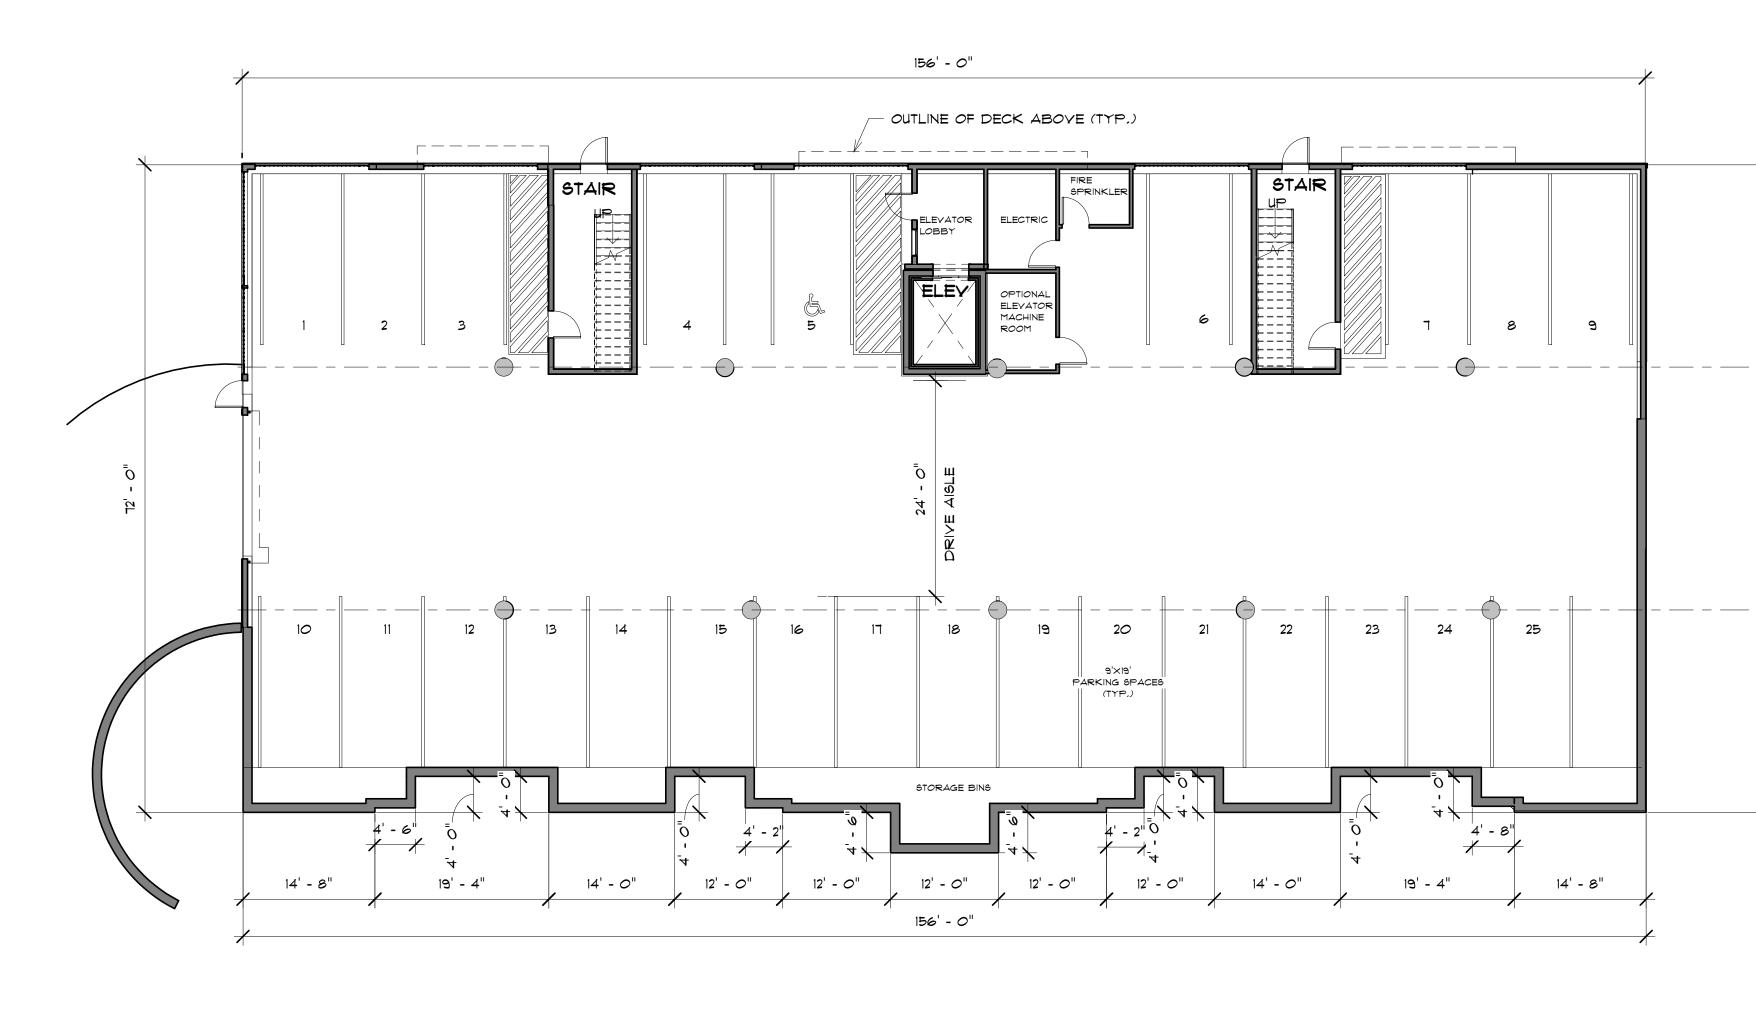



## DESIGNED BY: GAVIN AND SULLIVAN ARCHITECTS, INC.

128 WARREN STREET LOWELL, MA 01852

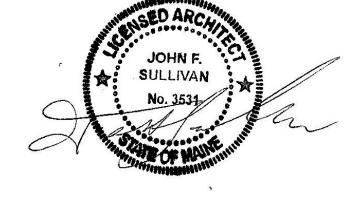




495 US ROUTE 1 KITTERY, ME JANUARY 21, 2019

SWATCHES FOR COLOR REFERENCE ONLY: REFER TO TO MATERIAL DESCRIPTION

HOMESTEAD, LLC

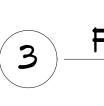

FINISH BOARD 1/4" = 1'-0"

WINDOWS - ALSIDES WHITE VINYL WINDOWS. EXTERIOR DOORS - FIBERGLASS EXTERIOR DOORS FIBERGLASS EXTERIOR FRENCH DOORS

OTHER EXTERIOR FINISHES:

STONE VENEER COLOR



ROOF SHINGLE COLOR



BOARD AND BATTEN

STERLING GRAY

SIDING COLOR

DARK GRAY

SHINGLE SIDING

COLONIAL WHITE

GAF Timberline Roofing Shingles GAF Timberline Lifetime Architectural Roofing Shingles

Boston Blend Ledgestone Thin Veneer consists of a wide range of colors including gray, white, tan, pink,

and black. The Ledgestone pattern of stone veneer

Weight is less than 14 lbs per square foot which allows the product to be used in construction applications

consists of thin strips of natural stone. Sold as

Beathered colors and/or inside grain colors. Suitable for putting stone on a wood structure. inch thickness allows for recessed joints.

<u>STONEYARD - LITTLETON, MA</u>

individual stones not stone panels.

without a load bearing support.

CERTAINTEED - BOARD & BATTEN -<u>SINGLE 7" & 8"</u>

STRAIGHT EDGE PERFECTUION SHINGLE VINTL SIDING 5" STRAIGHT EDGE SAWMILL SHINGLES .042" thickness Virtually maintenance free, never needs painting Class I(A) fire rating Lifetime limited warranty

Class I(A) fire rating Lifetime limited warranty CERTAINTEED CEDAR IMPRESSIONS

CERTAINTEED MAINSTREET VINYL SIDING

Natural woodgrain or brushed appearance

Double 4" Woodgrain Clapboard

secure installation RigidForm 160 technology has been tested\* to withstand wind load pressures up to 160 mph DuraLock post-formed lock design 9/16" panel projection .042" thickness Virtually maintenance free, never needs painting


Patented STUDfinder is designed for accurate and











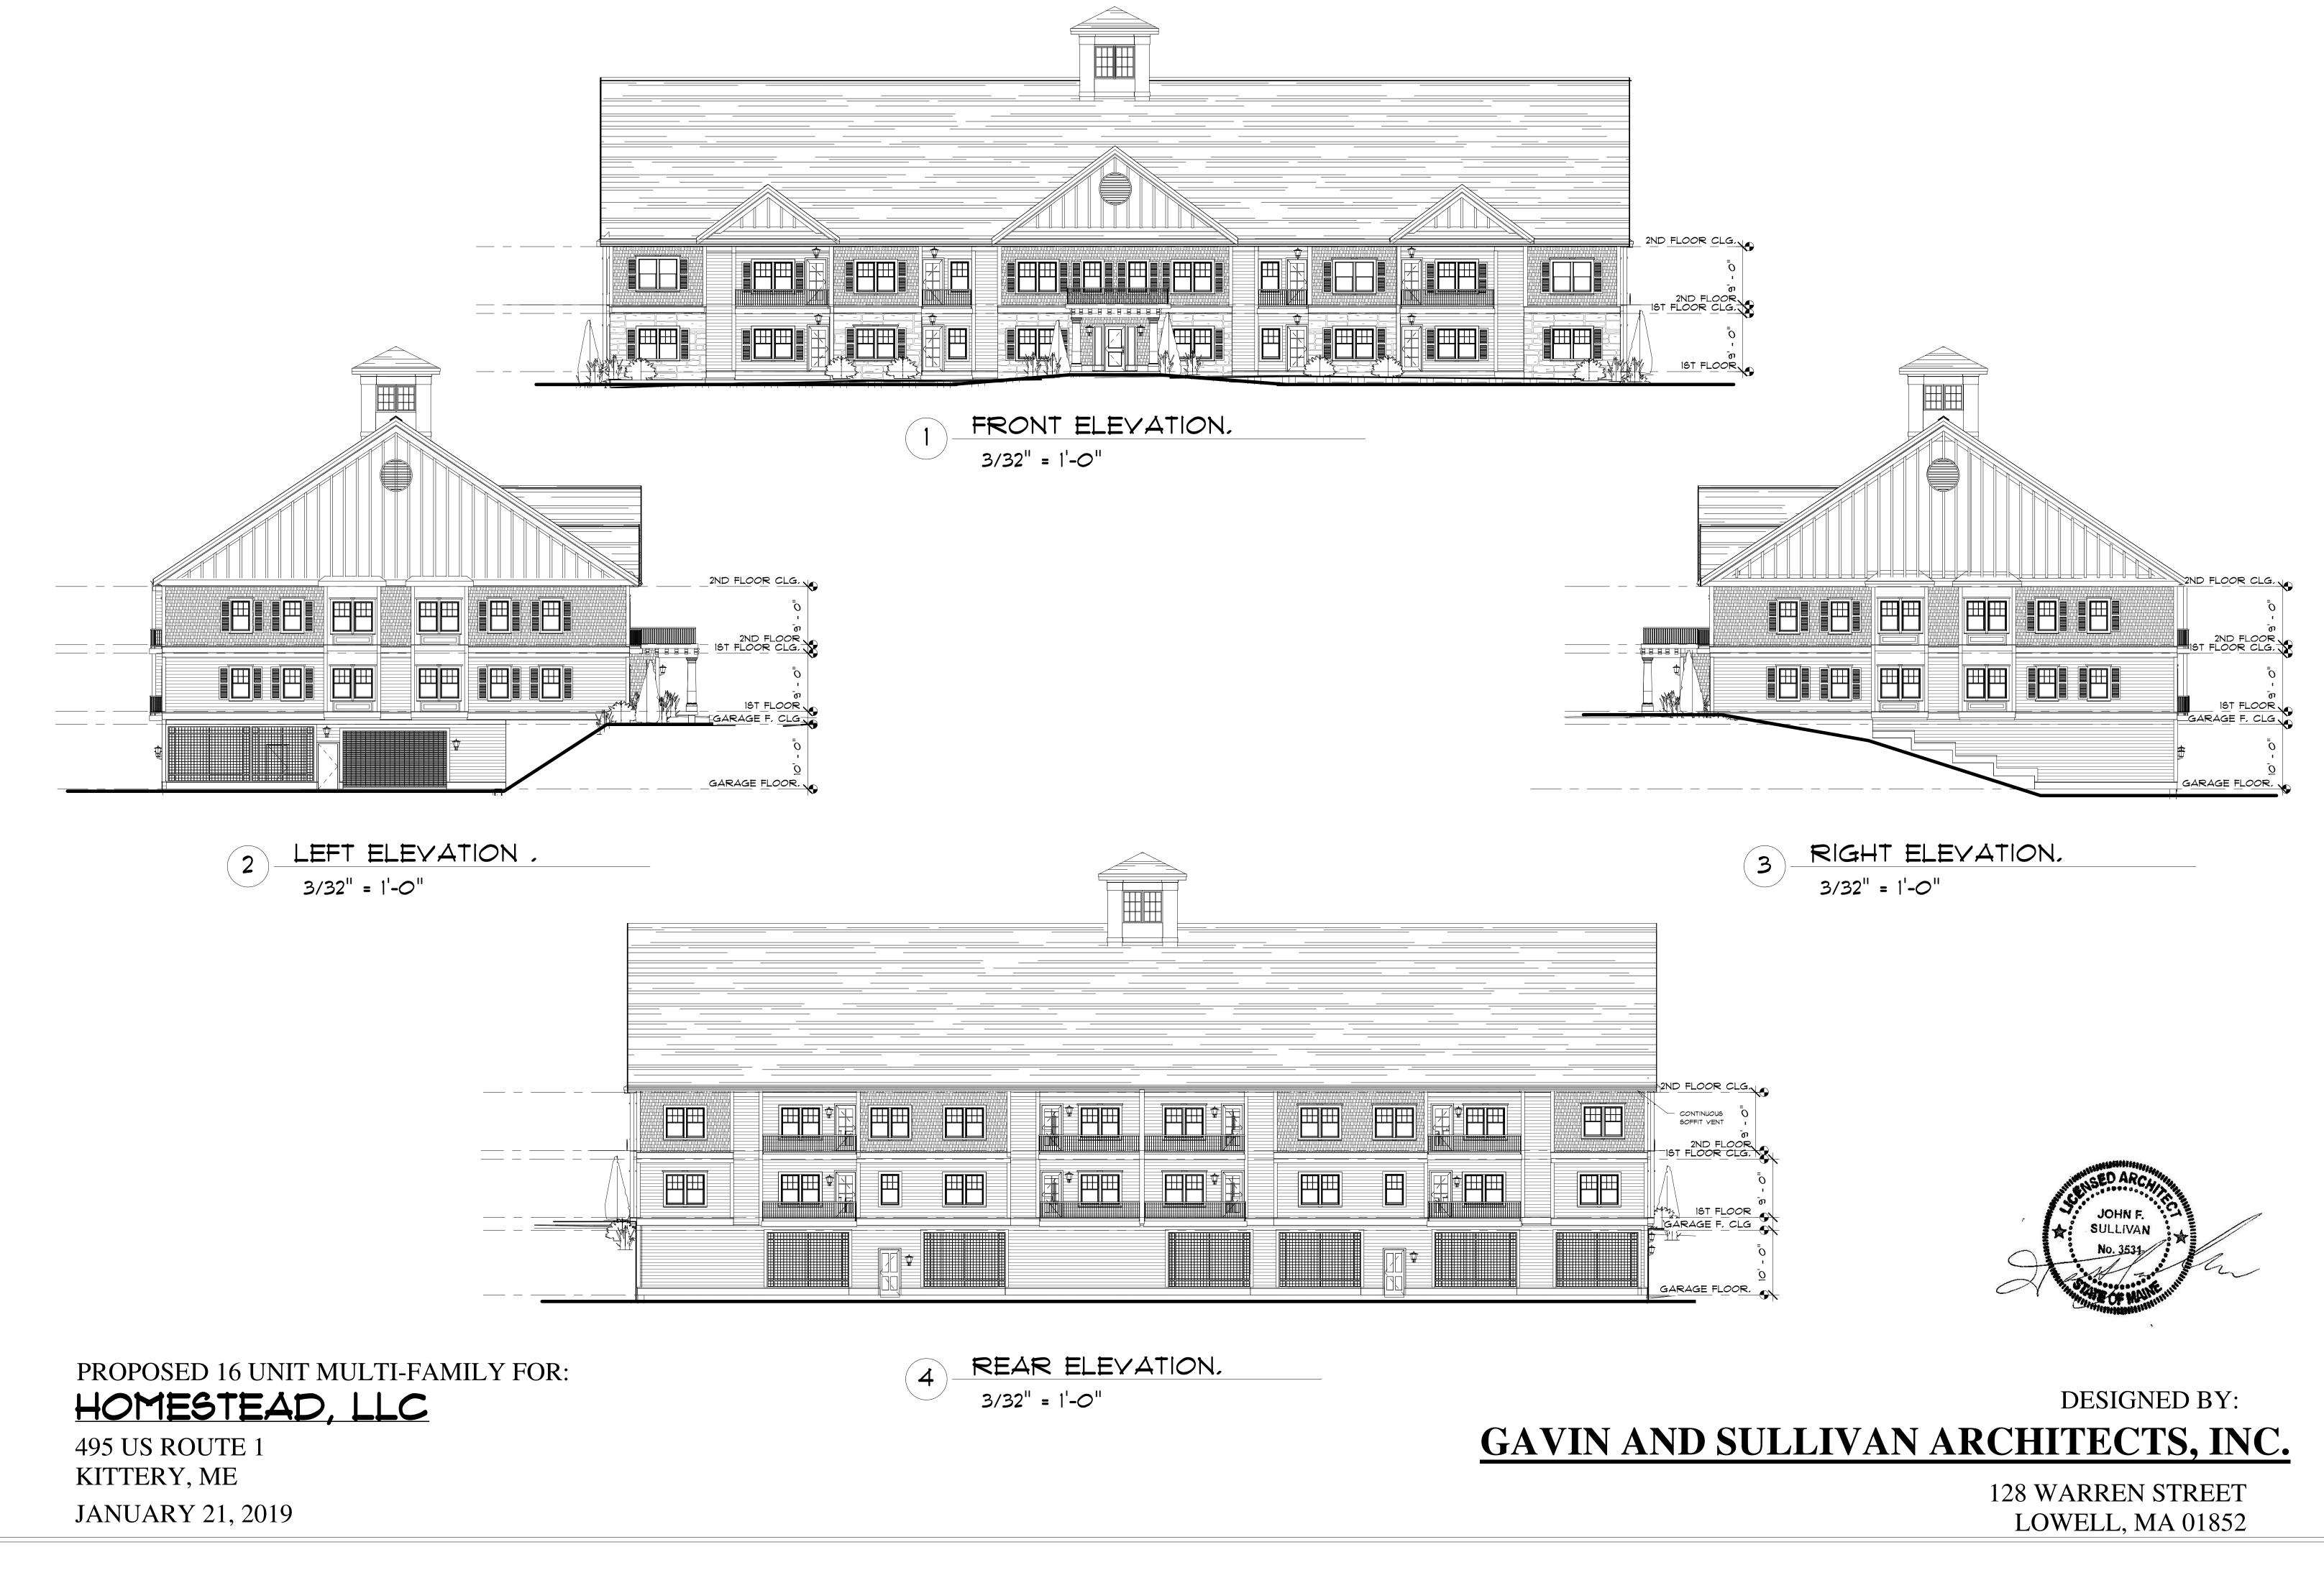

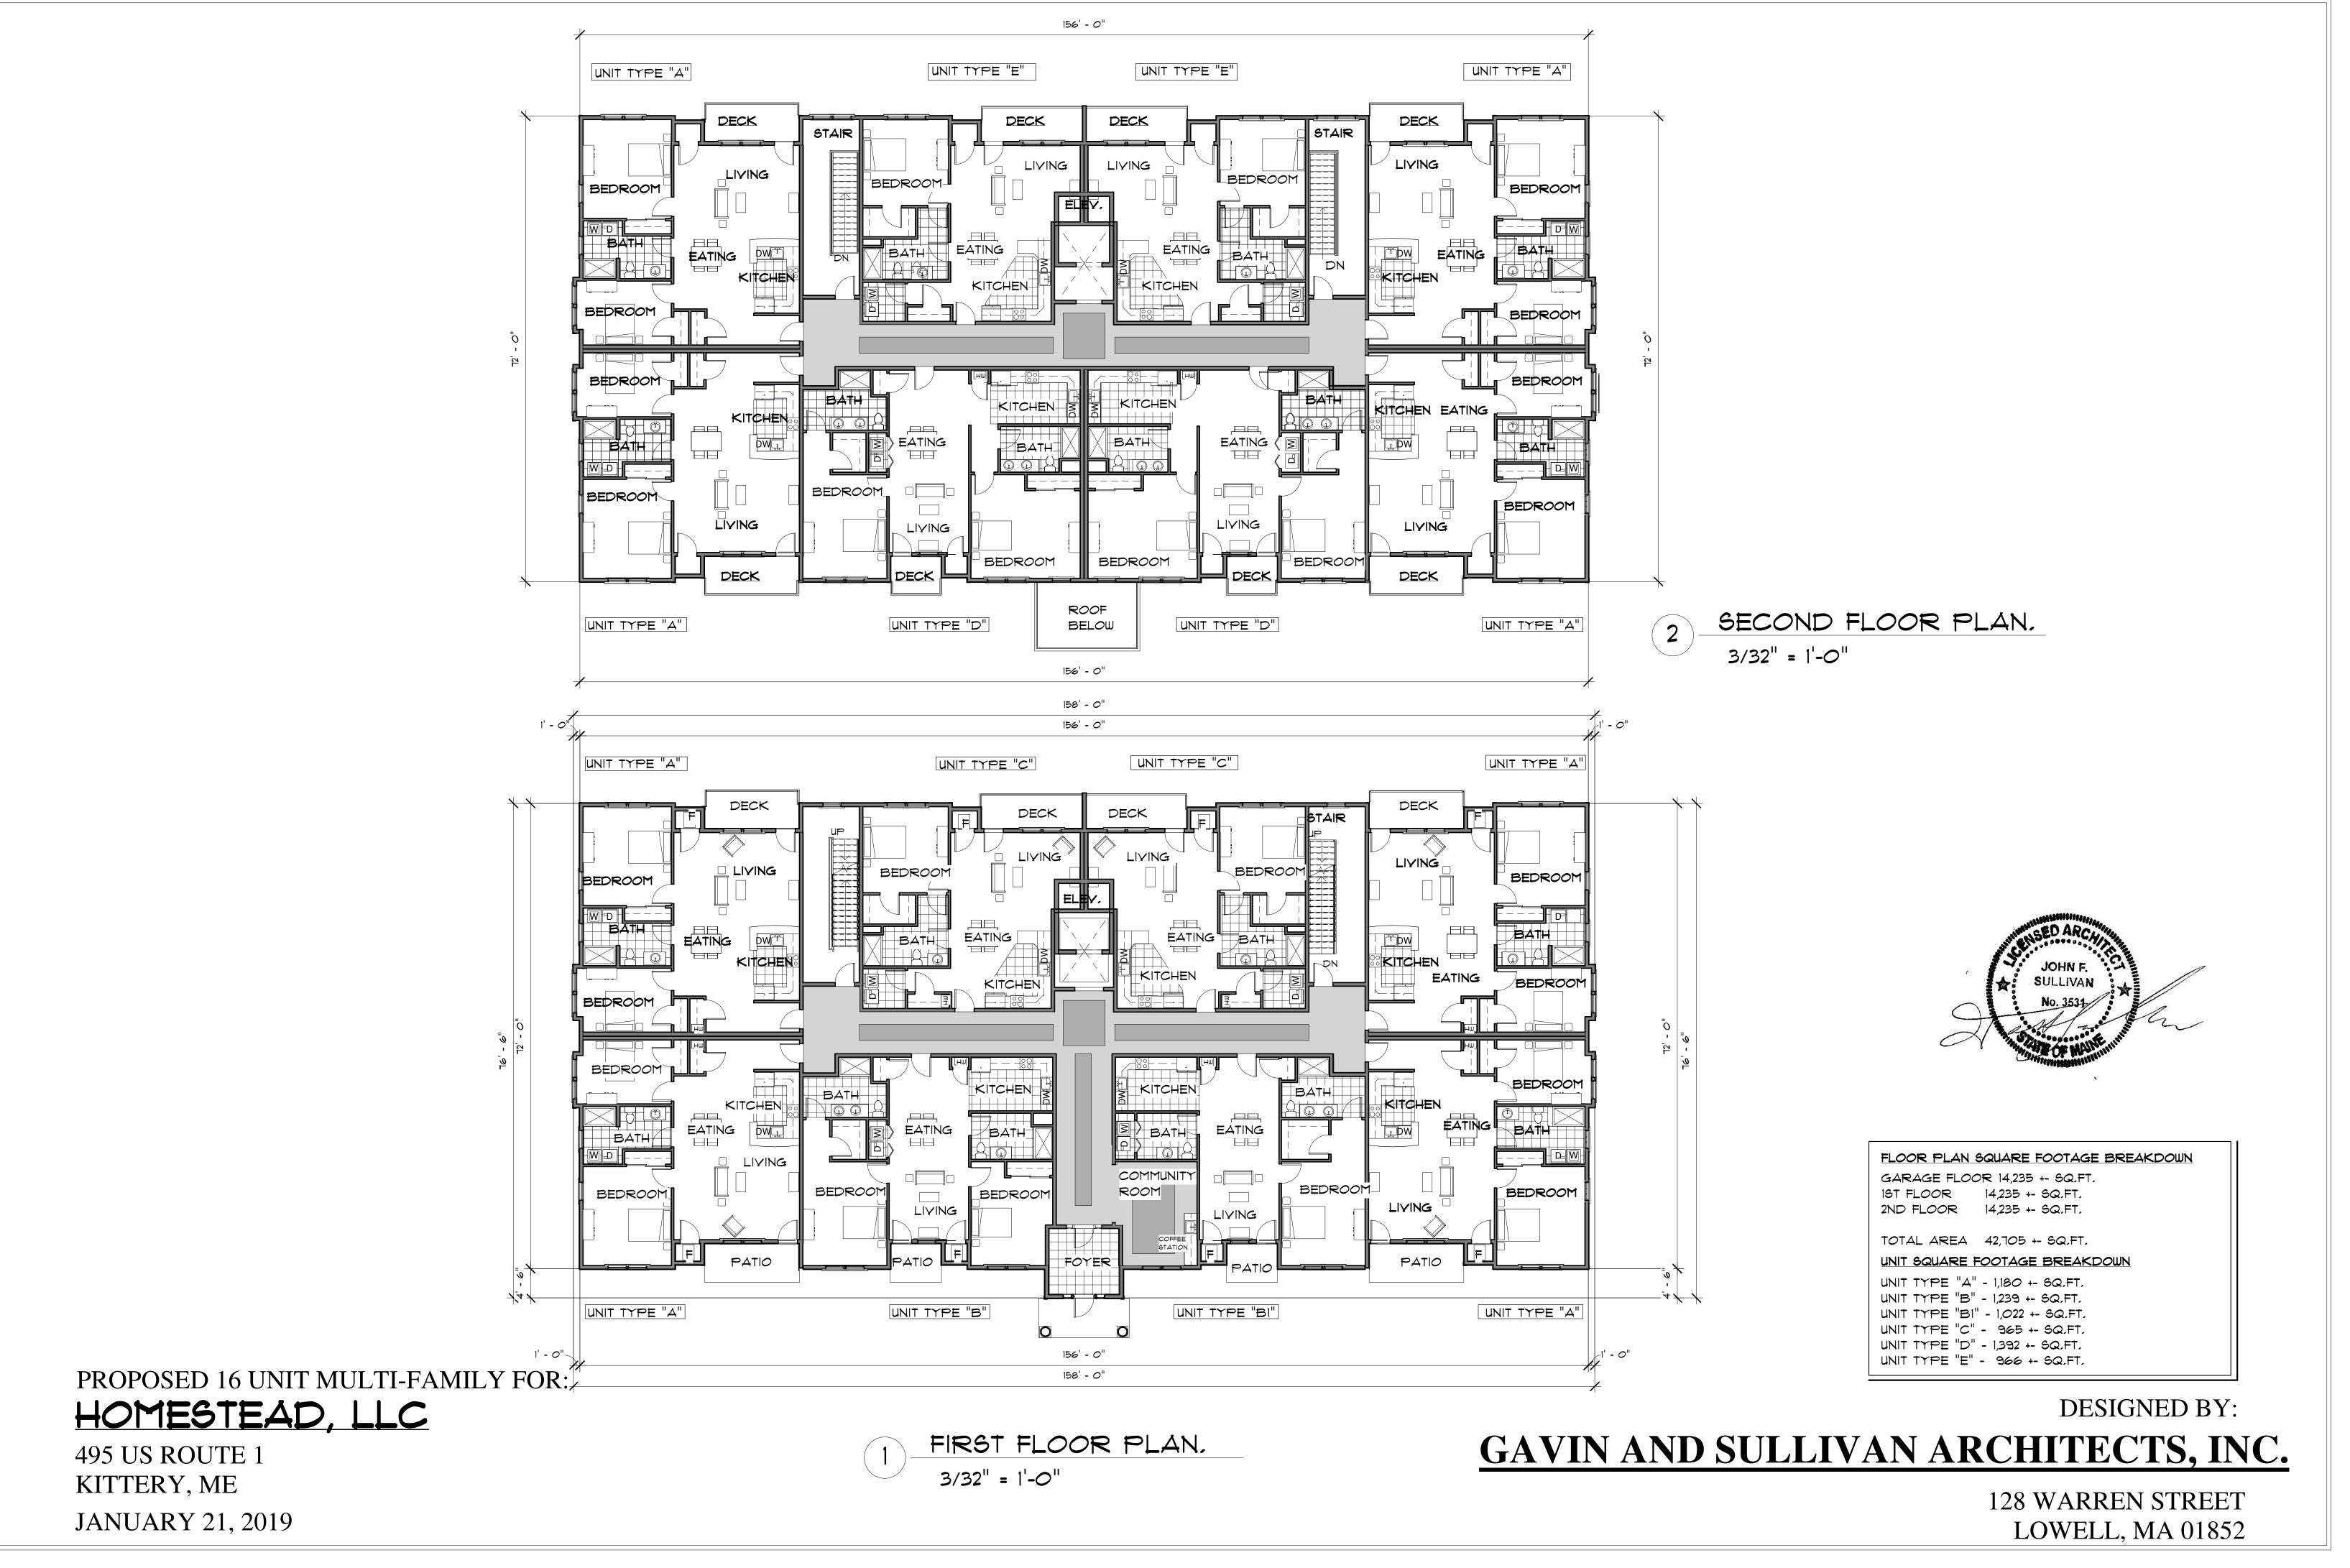

PROPOSED 16 UNIT MULTI-FAMILY FOR: HOMESTEAD, LLC

495 US ROUTE 1 KITTERY, ME JANUARY 21, 2019

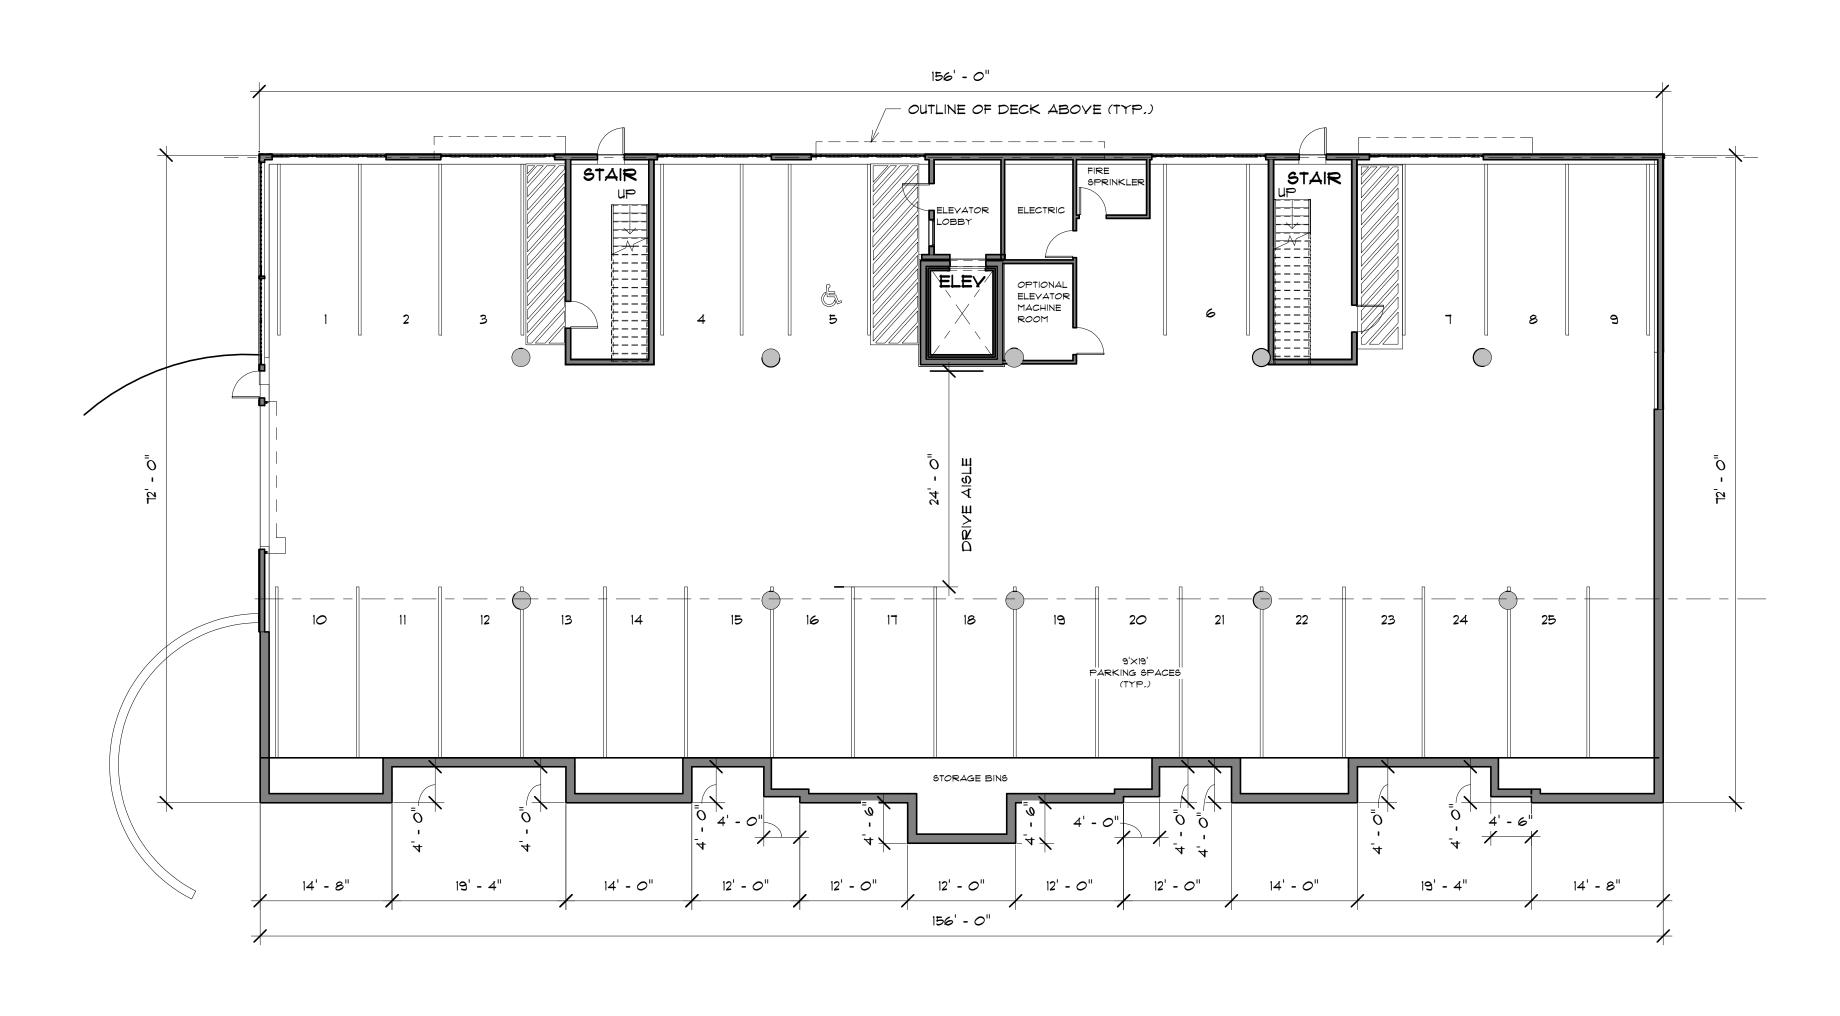




# **GAVIN AND SULLIVAN ARCHITECTS, INC.**

**128 WARREN STREET** LOWELL, MA 01852

**DESIGNED BY:** 

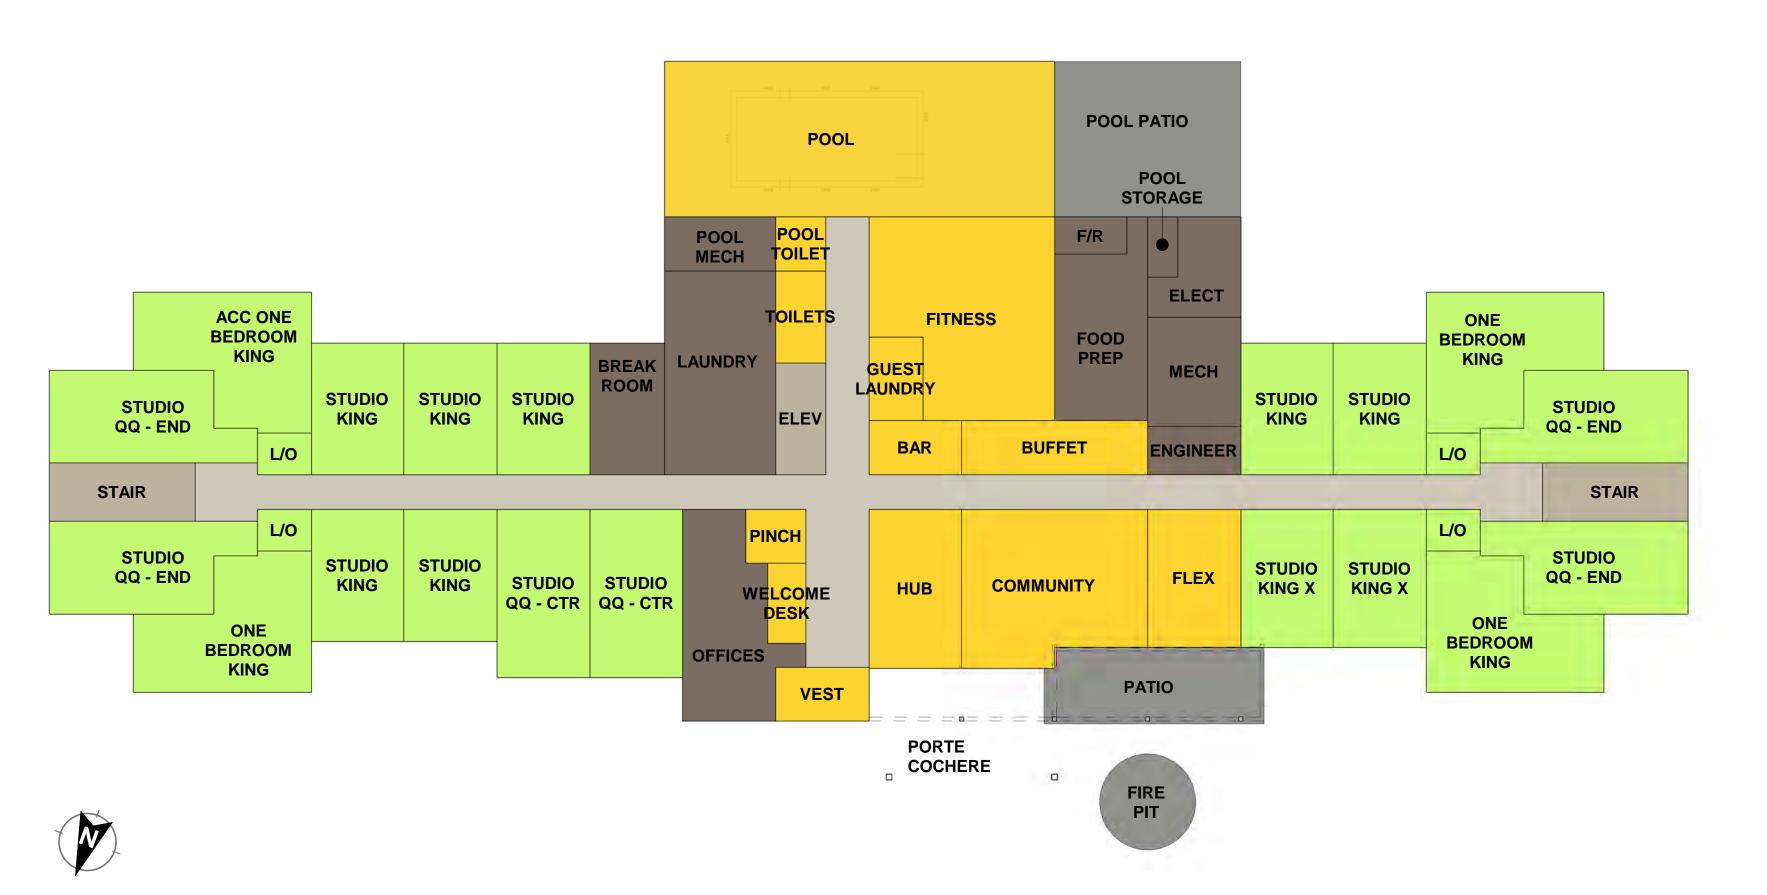

FIRST FLOOR PROGRAMMING PLAN







## **KITTERY TOWNEPLACE SUITES**

459 US ROUTE 1, KITTERY, MAINE

BUILDING AREA				
FLOOR	AREA			
FIRST FLOOR	18,915 SF			
SECOND FLOOR	15,356 SF			
THIRD FLOOR	15,356 SF			
FOURTH FLOOR	15,356 SF			
BUILDING TOTAL	64,984 SF			

TION OR BUILDINGS BEING SEIZED AND/OR MONETARY COMPENSATION

ROOM TYPE
ACC ONE BEDROOM KING
1
ACC STUDIO KING
3
ACC STUDIO QQ
3
ONE BEDROOM KING
15
STUDIO KING
55
STUDIO KING X
2
STUDIO KING XL
3
STUDIO QQ
14
STUDIO QQ END
16
Grand total: 112

GUE	STROOM TOTALS	
063	STUDIO KING (3 ACC)	56.25%
033	STUDIO QQ (3 ACC)	29.50%
<u>016</u>	ONE BDRM KING (1 ACC)	<u>14.25%</u>
112	TOTAL KEYS (7 ACC)	100%


$0  \frac{8'  16'  32'}{FLOOR}$	ST
SCALE:	
3135 - KITTERY TOWNEPLACE SUITES	




## JAI SHREE DURGA LAXMI LLC 3 TURTLE CREEK CIRCLE SHREWSBURY MA 01545

SECOND FLOOR PROGRAMMING PLAN


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THIRD FLOOR PROGRAMMING PLAN

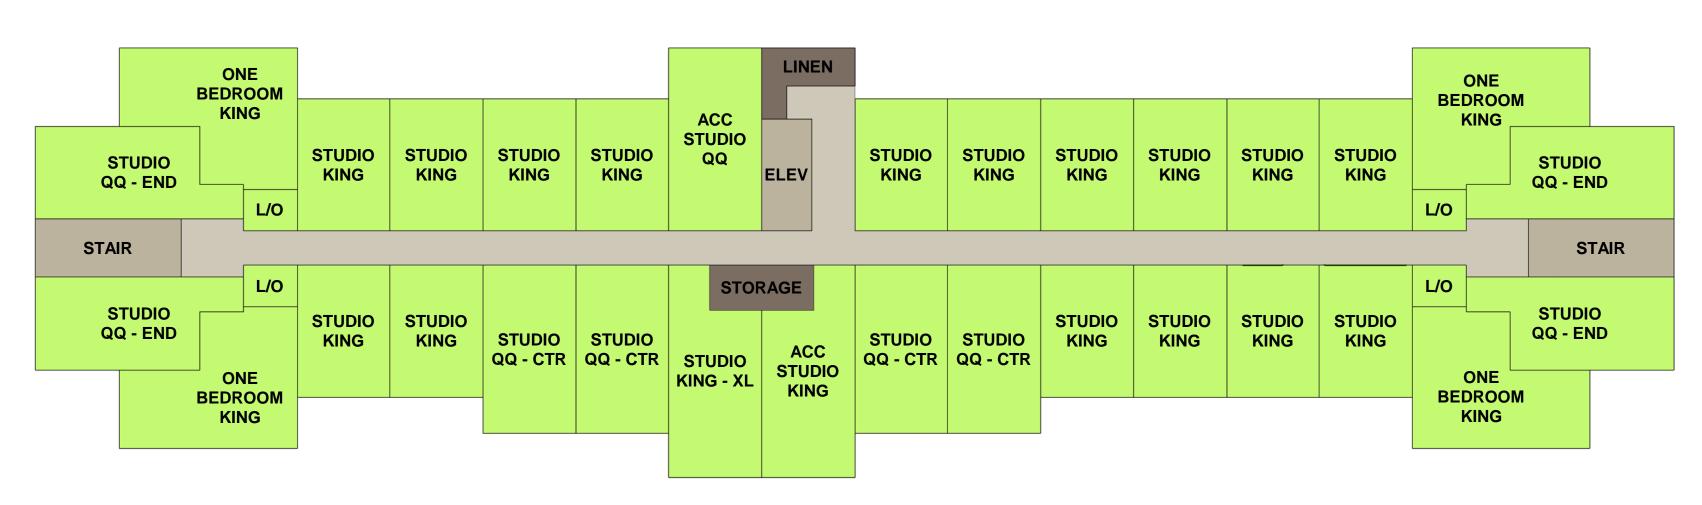

FOURTH FLOOR PROGRAMMING PLAN

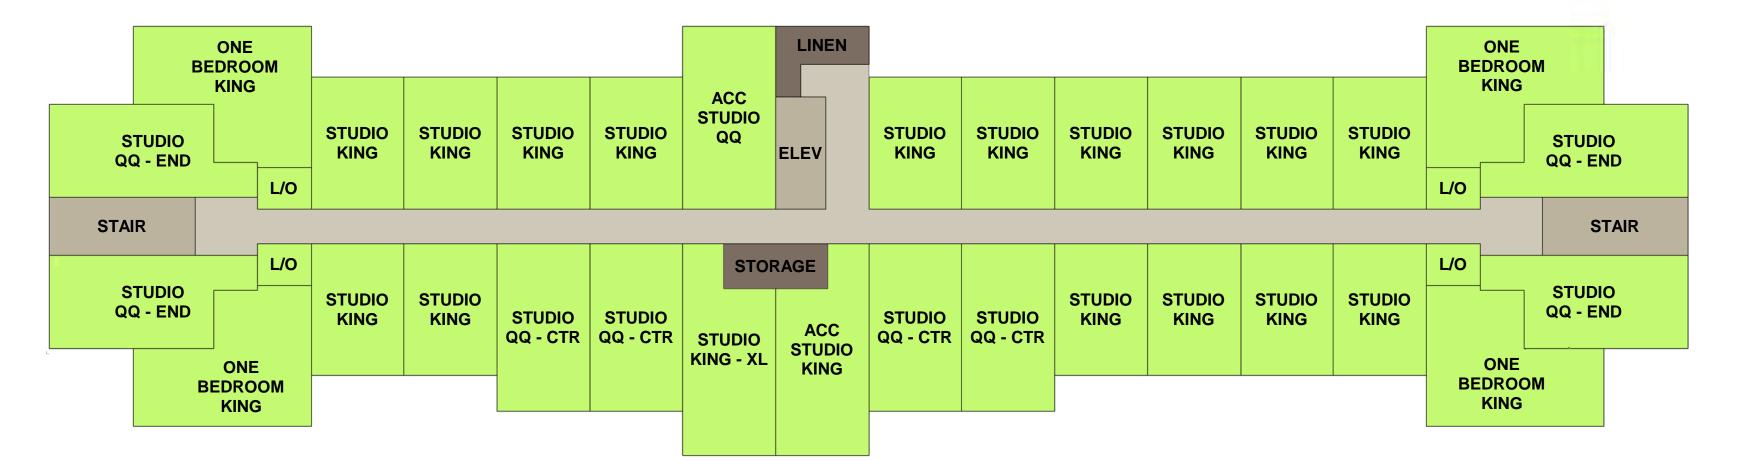

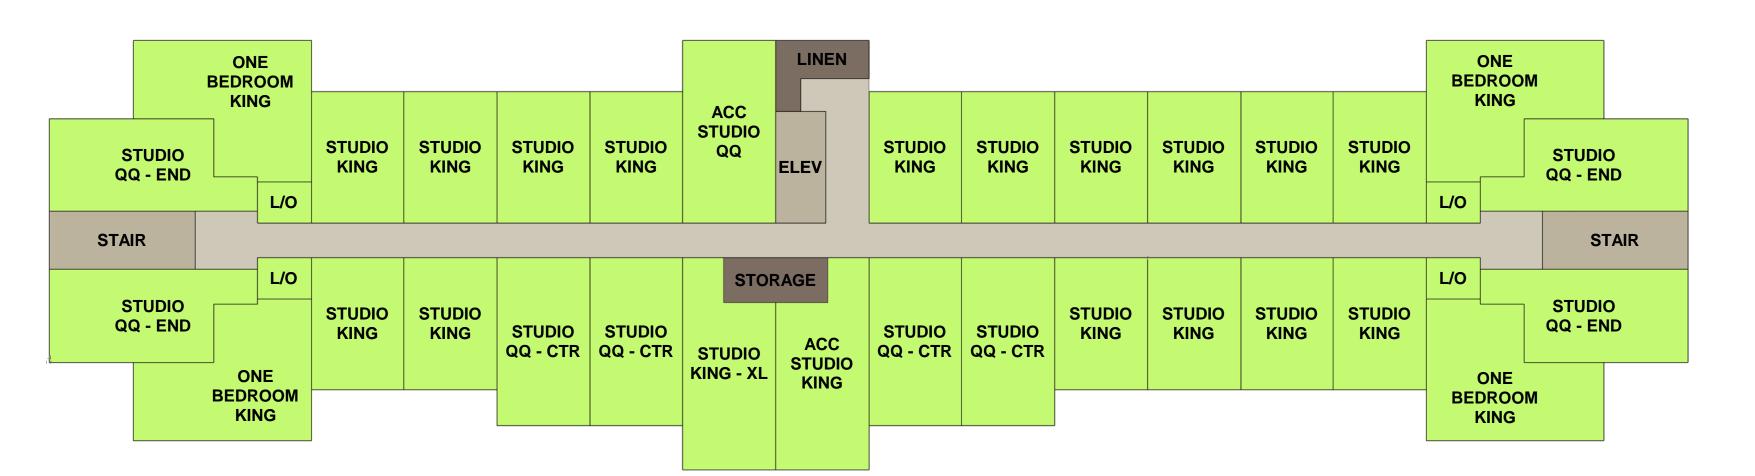

## **KITTERY TOWNEPLACE SUITES**

459 US ROUTE 1, KITTERY, MAINE

**NOT FOF** CONSTRUCT

	1020011012001	10,000 01
	THIRD FLOOR	15,356 SF
	FOURTH FLOOR	15,356 SF
	<b>BUILDING TOTAL</b>	64,984 SF
<b>GUESTROOM</b> T	OTALS	
063 STUDIO KI		56.25%
	· · · ·	
033 STUDIO Q	Q (3 ACC)	29.50%
016 ONE BDRM	/I KING (1 ACC)	14.25%
		1000/

112 TOTAL KEYS (7 ACC)

100%

ACC ONE BEDROOM KING 1 ACC STUDIO KING 3 ACC STUDIO QQ 3 ONE BEDROOM KING 15 STUDIO KING 55 STUDIO KING X 2 STUDIO KING X 2 STUDIO KING XL 3 STUDIO QQ 14 STUDIO QQ END 16 Grand total: 112	
ACC STUDIO KING 3 ACC STUDIO QQ 3 ONE BEDROOM KING 15 STUDIO KING 55 STUDIO KING X 2 STUDIO KING XL 3 STUDIO QQ 14 STUDIO QQ END 16	ACC ONE BEDROOM KING
3 ACC STUDIO QQ 3 ONE BEDROOM KING 15 STUDIO KING 55 STUDIO KING X 2 STUDIO KING XL 3 STUDIO QQ 14 STUDIO QQ END 16	1
ACC STUDIO QQ 3 ONE BEDROOM KING 15 STUDIO KING 55 STUDIO KING X 2 STUDIO KING XL 3 STUDIO QQ 14 STUDIO QQ END 16	ACC STUDIO KING
3 ONE BEDROOM KING 15 STUDIO KING 55 STUDIO KING X 2 STUDIO KING XL 3 STUDIO QQ 14 STUDIO QQ END 16	3
ONE BEDROOM KING 15 STUDIO KING 55 STUDIO KING X 2 STUDIO KING XL 3 STUDIO QQ 14 STUDIO QQ END 16	ACC STUDIO QQ
15 STUDIO KING 55 STUDIO KING X 2 STUDIO KING XL 3 STUDIO QQ 14 STUDIO QQ END 16	3
STUDIO KING 55 STUDIO KING X 2 STUDIO KING XL 3 STUDIO QQ 14 STUDIO QQ END 16	ONE BEDROOM KING
55 STUDIO KING X 2 STUDIO KING XL 3 STUDIO QQ 14 STUDIO QQ END 16	15
STUDIO KING X 2 STUDIO KING XL 3 STUDIO QQ 14 STUDIO QQ END 16	STUDIO KING
2 STUDIO KING XL 3 STUDIO QQ 14 STUDIO QQ END 16	55
STUDIO KING XL 3 STUDIO QQ 14 STUDIO QQ END 16	STUDIO KING X
3 STUDIO QQ 14 STUDIO QQ END 16	2
STUDIO QQ 14 STUDIO QQ END 16	STUDIO KING XL
14 STUDIO QQ END 16	3
STUDIO QQ END 16	STUDIO QQ
16	14
	STUDIO QQ END
Grand total: 112	16
	Grand total: 112

R				
ΓΙΟΝ	SCALE:	8'	16'	32'

## **PROGRAMMING - UPPER** FLOORS 3135 - KITTERY TOWNEPLACE SUITES










BMA, PC T: 603 673 1991 WWW.BMAWORLD.COM

## JAI SHREE DURGA LAXMI LLC 3 TURTLE CREEK CIRCLE SHREWSBURY MA 01545

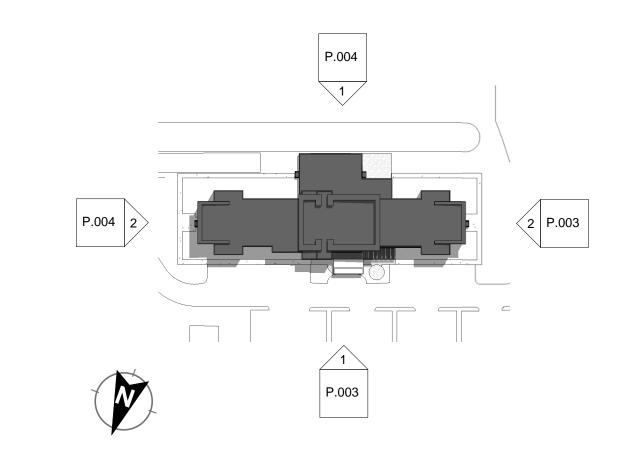



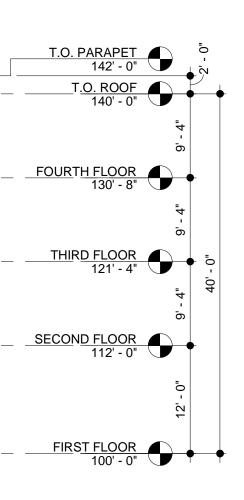

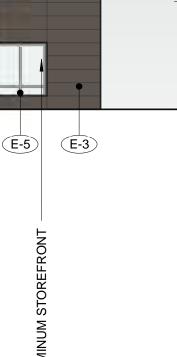

## **KITTERY TOWNEPLACE SUITES**

459 US ROUTE 1, KITTERY, MAINE

EXTERIOR M	ATERIALS LEGEND
E-1	FIBER CEMENT LAP SIDING 8" REVEAL - BENJAMIN MOORE MANOR BLUE
(E-2)	FIBER CEMENT LAP SIDING 4" REVEAL - BENJAMIN MOORE NOVEMBER RAIN
•	FIBER CEMENT PANELING HORIZONTAL - NICHIHA ILLUMINATION BENJAMIN MOORE NIGHT SHADE
E-4	WOOD LOOK FIBER CEMENT PANELING VERTICAL - NICHIHA ROUGH SAWN SMOKE
E-5	METAL, PAINTED PPG ANODIC CLEAR
E-6	CAST-IN-PLACE CONCRETE- PARGED

SCALE

## **EXTERIOR ELEVATIONS**

135 - KITTERY TOWNEPLACE SUITES

**PL003** APPROVALS - 2019.11.21







TED AND ARE SUBJECT TO COPYRIGH

### JAI SHREE DURGA LAXMI LLC 3 TURTLE CREEK CIRCLE SHREWSBURY MA 01545

U.S.O. AS AMENDED DECEMBER 1990 AND KNOWN AS ARCHITECTURAL WORKS CO

PROTECTION AS AN "ARCHITECTURAL WORK" UNDER SEC

459 US ROUTE 1, KITTERY, MAINE

**CONSTRUCTION** 

AND COMPOSITION OF SPACES AND ELEMENTS OF THE DESIGN. UNDER SUCH PROTECTION, UNAUTHORIZED USE OF THESE PLANS, WORK OR HOME REPRESENTED, CAN LEGALLY RESULT IN THE CESSATION OF CONSTRUCTION OR BUILDINGS BEING SEIZED AND/OR MONETARY COMPENSATION TO BMA ARCHITECTURAL GROUP, P

24

## EXTERIOR MATERIALS LEGEND FIBER CEMENT LAP SIDING 8" REVEAL - BENJAMIN MOORE MANOR BLUE FIBER CEMENT LAP SIDING 4" REVEAL - BENJAMIN MOORE NOVEMBER RAIN FIBER CEMENT PANELING HORIZONTAL - NICHIHA ILLUMINATION BENJAMIN MOORE NIGHT SHADE WOOD LOOK FIBER CEMENT PANELING VERTICAL - NICHIHA ROUGH SAWN SMOKE METAL, PAINTED PPG ANODIC CLEAR CAST-IN-PLACE CONCRETE-PARGED

BMA, PC T: 603 673 1991 WWW.BMAWORLD.COM

JAI SHREE DURGA LAXMI LLC

3 TURTLE CREEK CIRCLE SHREWSBURY MA 01545




CONCEPTUAL EXTERIOR PERSPECTIVE - VIA HOTEL PARKING LOT






**KITTERY TOWNEPLACE SUITES** NOT FC CONSTRUC 459 US ROUTE 1, KITTERY, MAINE

OR	0 1/2'	1'		PROGRAMMING - EXTERIOR PERSPECTIVES	D	DOF
CTION	SCALE:			3135 - KITTERY TOWNEPLACE SUITES	APPROVALS	2019.11.21
THORIZED USE OF THESE PLANS,	WORK OR HOME REPRESENTED, CAN L	EGALLY RESULT IN THE CESS	SATION O	CONSTRUCTION OR BUILDINGS BEING SEIZED AND/OR MONETARY COMPENSATION TO BMA	ARCHITECTURAL	GROUP, P.C.

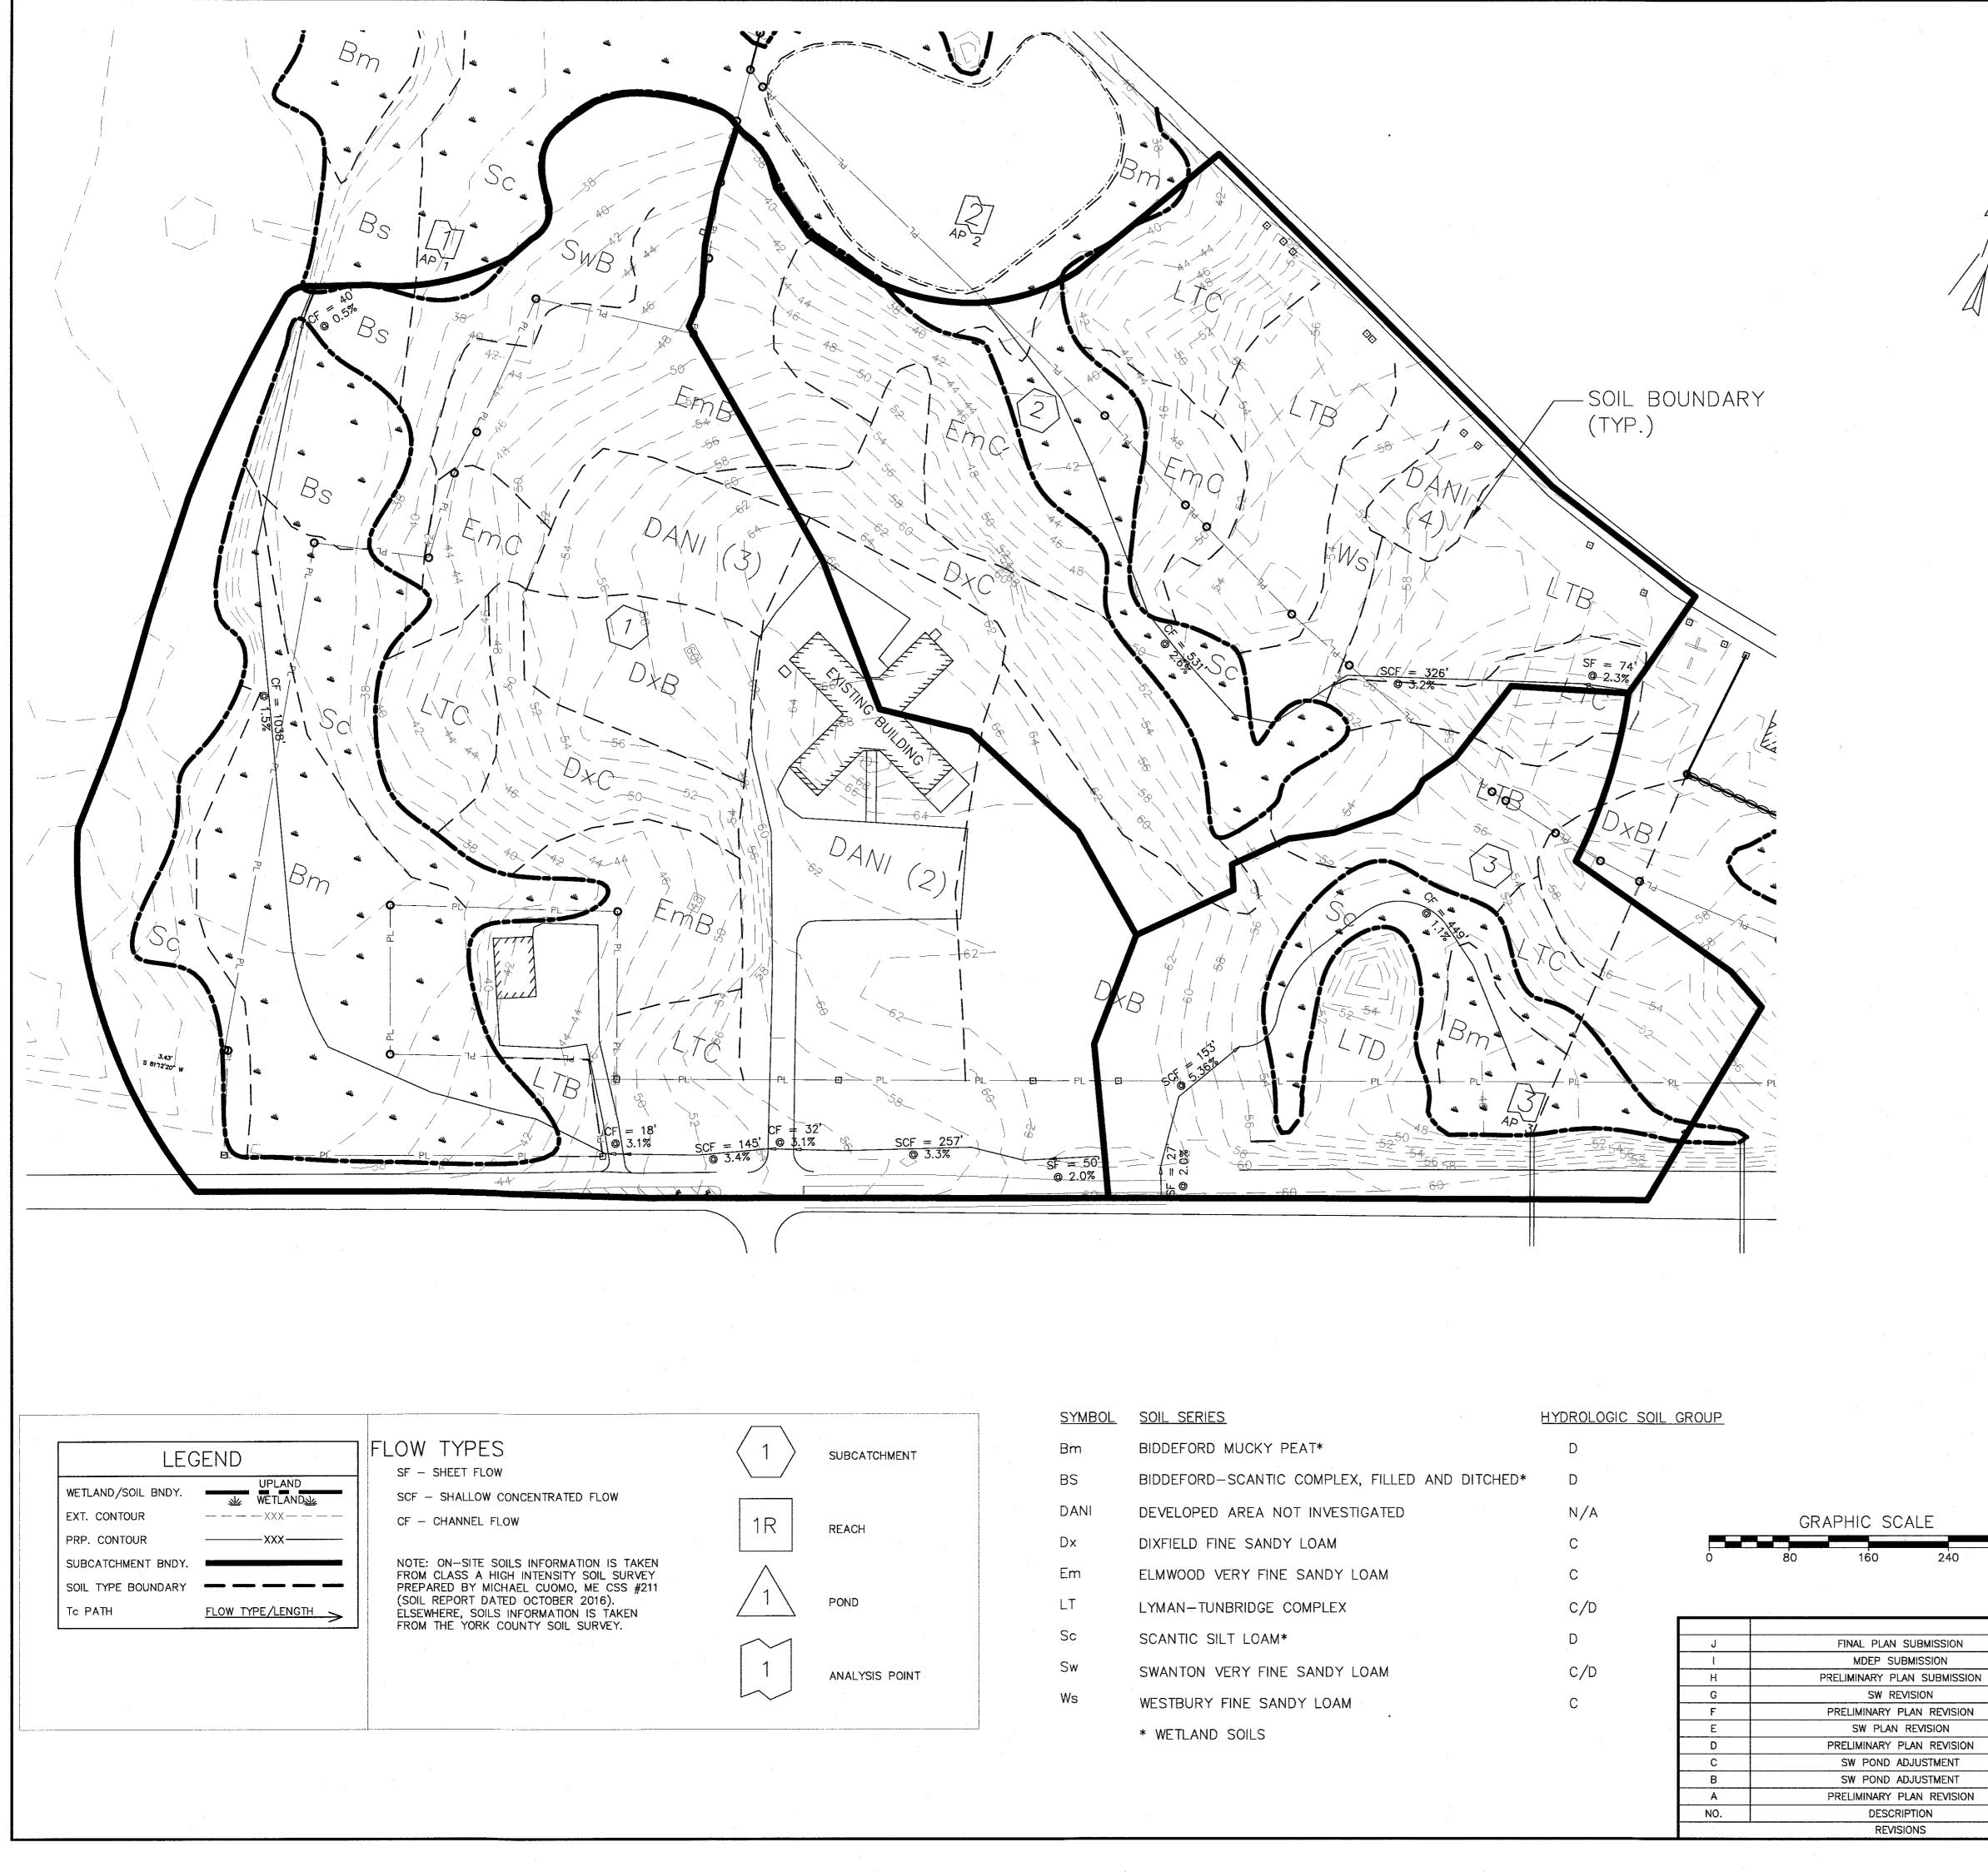

STORMWATER: EXISTING CONDITIONS 240 320 (FEET) 7.1 THE HOMESTEAD 459 US ROUTE 1 KITTERY, MAINE FOR: LANDMARK HILL, LLC 79 CONGRESS ST PORTSMOUTH, NH 03801 01/24/2019 E OF M 01/23/2019 9/20/2018 KENNETHA ATTAR ENGINEERING, INC. 4/20/2018 WOOD 4/19/2018 No 5382  $\langle \rangle$ 4/16/2018 CENSS: 03/27/2018 ISSIONAL P APPROVED BY: SCALE: DRAWN BY: 02/08/2018 1" = 80' BRN 02/06/2018 DATE: then REVISION : DATE 1/18/2018 J: 01/24/2019 02/08/2018 DATE JOB NO: C052-18 FILE: THE HOMESTEAD BASE SHEET 7.1 TAX MAP 60, LOT 24

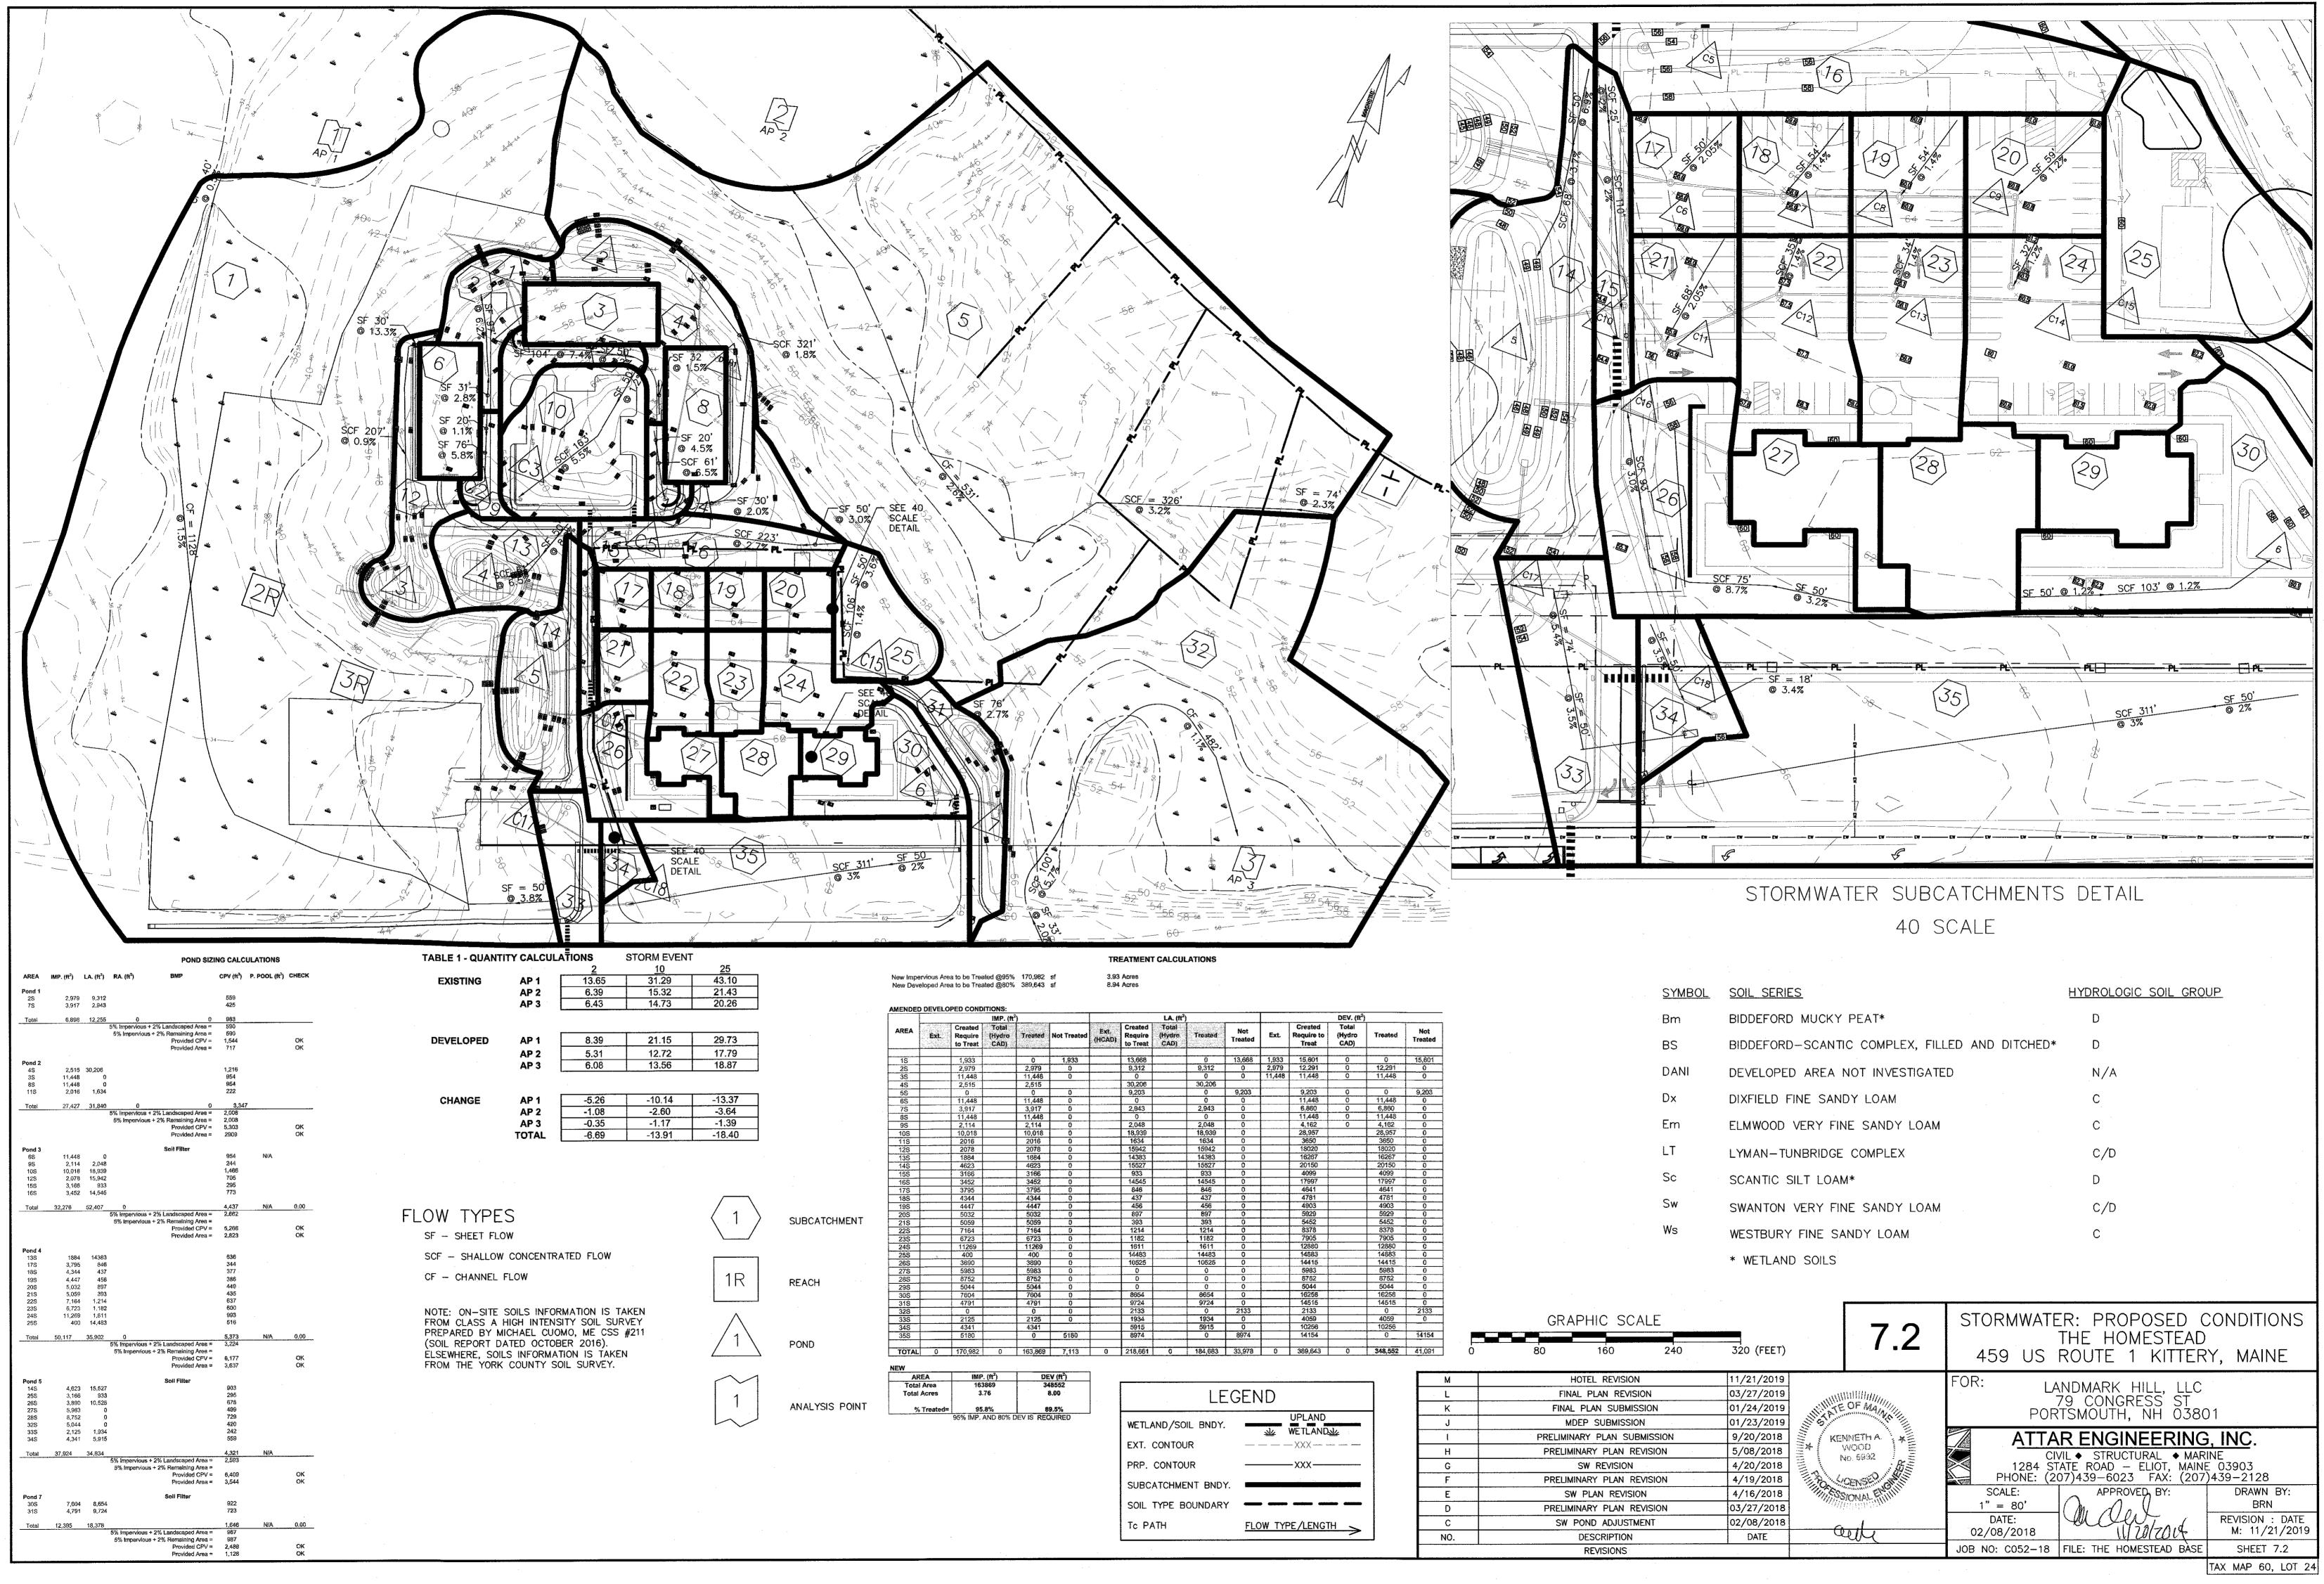

8.94 Acres	3.83	Acres
	8.94	Acres


	iMP. (tt²)						LA. (ff <sup>2</sup> )					DEV. (ft <sup>2</sup> )				
AREA	Ēxt.	Created Require to Treat	Total (Hydro CAD)	Treated	Not Treated	Ext. (HCAD)	Created Require to Treat	Total (Hydre CAD)	Treated	Not Treated	Ext.	Created Require to Treat	Total (Hydro CAD)	Treated	Not Treated	
15		1,933		0	1.933		13,668		0	13,668	1,933	15.601	0	0	15,601	
15 2S		2,979		2,979	0		9,312		9,312	0	2,979	12,291	0	12,291	0	
35		2,979		11,448	0		0		0	0	11.448	11,448	0	11,448	0	
				2,515	U U		30,206		30,206		11,440	11,440	<u> </u>	11,440		
4S .		2,515		2,515	0		9,203		0	9,203		9,203	0	0	9,203	
58		0		11.448	0		9,203		0	9,205		11,448	0	11,448	9,203	
6S				3,917	0		2,943		2.943	0	· · · · · · ·	6.860	0	6,860	0	
75		3,917			0		2,943		2,943	0	ļ	11,448	0	11,448	0	
8S		11,448		11,448	0		2,048		2,048	0	·	4,162	0	4,162	0	
9S 10S		2,114			0		18,939		18,939	0	<b> </b>	28,957		28,957	0	
		10,018		10,018	0		16,959	5	1634	0	· · · · · · · · · · · · · · · · · · ·	3650		3650	0	
115		2016		2016 2078			15942		15942	0		18020		18020	0	
125		2078		1884	0		10942		14383	0	· · ·	16267		16267	0	
135		1884					14303		14060	0		20150		20150	0	
148		4623		4623 3166	0		933		933	0		4099		4099	0	
155		3166		3166			933		933	0	· · · · ·	17997		4099	0	
165	-	3452		3452	0		846		846	0		4641		4641	0	
175		3795		4344	0		437		437	0		4041		4781	0	
185		4344		4344	0		457		456	0		4903		4101	0	
195		4447		5032			897		897	0		5929		5929	0	
205		5032			0		393		393	0		5452		5452	0	
215		5059		5059 7164	0		1214		1214	0		8378		8378	0	
225		7164 6723		6723	0		1214		1214	0	[	7905		7905	0	
235		11269		11269	0		1611		1611	- O		12880		12880	0	
24S 25S	<u> </u>	400		400	0		14483		14483	0		14883		14883	0	
26S	<u> </u>	3890		3890	0		10525		10525	ŏ		14415		14415	0	
275		5983	·	5983	0		0		0	0	<u></u>	5983		5983	0	
285	··	8752		8752	0		- ŏ		0	0	<u> </u>	8752		8752	- 0	
295		5044		5044	ő		0		i a	Ő	<u> </u>	5044		5044	0	
30\$		7604		7604	0	<u> </u>	8654		8654	Ő	<u> </u>	16258		16258	0	
31S		4791		4791	0		9724		9724	0		14515		14515	Ū Ū	
328		0		0	0		2133		0	2133		2133	· · ·	0	2133	
335		2125		2125	0		1934		1934	0		4059		4059	0	
345		4341		4341			5915		5915	Ő	t	10256		10256		
355		5180	-	0	5180		8974		0	8974		14154		0	14154	
TOTAL	0	170,982	0	163,869	7,113	0	218,661	0	184,683	33,978	0	389,643	0	348,552	41,091	


NALYSIS	POINT	

	AREA	IMP. (ft <sup>2</sup> )	DEV (ft <sup>2</sup> )
To	tal Area	163869	348552
То	tai Acres	3.76	8.00
	% Treated=	95.8%	89.5%

	8504		0004	<u> </u>		10200	l	10200	<u> </u>										
	9724		9724	0		14515		14515	0									······································	
	2133		0	2133		2133		0	2133		00				1				
	1934		1934 5915	0		4059 10256	· · · ·	4059 10256	0		GR/	APHIC SO	CALE			5	URMWAI	FER: PROPOSED (	JUNDIHUNS I
	5915 8974		0 19	8974		14154		10230	14154			<u></u>							
<u></u>	03/4			0014		14104		<u> </u>	14104									THE HOMESTEAD	)
3 (	218,661	0	184,683	33,978	0	389,643	0	348,552	41,091	Ó	80	160	240	320 (FEET)		1	AED UC		
													· .				409 US	ROUTE 1 KITTER	KI, MAINE
																			· · · · · · · · · · · · · · · · · · ·
									М			HOTEL REVISIO	ION	11/21/2019		FOR	•		
	1										L. I.		401031				· [	ANDMARK HILL, LLC	
			LE	EGEN	ID I				·		Fir	NAL PLAN REV	/ISION	03/27/2019				79 CONGRESS ST	
									K		FINA	AL PLAN SUBM	MISSION	01/24/2019	IN TE OF MAN			RTSMOUTH, NH 0380	0.1
	WETLA	ND/SOI	L BNDY.			UPLAND			J		N	MDEP SUBMISS	SION	01/23/2019	IN STORES		FU	KISMOUTH, NH 0380	
					_	WETLAND	_		1		PRELIM	INARY PLAN S	UBMISSION	9/20/2018	S KENNETHA KE		ΔΤΤ	AR ENGINEERING	A INC
	EXT.	CONTOU	R			- XXX ·			н		PRELI	MINARY PLAN	REVISION	5/08/2018	EX WOOD			CIVIL	
	PRP.	CONTOU	IR			-xxx—			G			SW REVISION	N	4/20/2018	BE NO. 6494		1284	STATE ROAD - ELIOT. MAIN	E 03903
	SUBC	TOUNE	NT BND	·		.:			F		PRELI	MINARY PLAN	REVISION	4/19/2018	12 Conservation		PHONE: (	STATE ROAD – ELIOT, MAIN 207)439–6023 FAX: (207	/)439–2128
	SUBCI								E		S	SW PLAN REVIS	SION	4/16/2018	THE SSIONAL FUILING		SCALE:	APPROVED BY:	DRAWN BY:
	SOIL	TYPE BO	DUNDAR	Y —	-				D		PRELI	MINARY PLAN	REVISION	03/27/2018			1" = 80 <b>'</b>	(m. And	BRN
	Tc PA	TH		FLC	W TYP	E/LENG	TH 👡		C		SW	POND ADJUS	STMENT	02/08/2018	0.1		DATE:	Malatad	REVISION : DATE
				· ····		_,	~~>		NC	).		DESCRIPTION	N	DATE	eik	0	2/08/2018	11/20/2014	M: 11/21/2019
										·····		REVISIONS	· · · · · · · · · · · · · · · · · · ·		· · · · · · · · · · · · · · · · · · ·	JOB	NO: C052-18	FILE: THE HOMESTEAD BASE	SHEET 7.2
									<b>.</b>				· ·			-			THE HAD OD LOT OU

SYMBOL	SOIL SERIES	HYDROLOGIC SOIL GROUP	
Bm	BIDDEFORD MUCKY PEAT*	D	
BS	BIDDEFORD-SCANTIC COMPLEX, FILLED AND DITCHED*	D	
DANI	DEVELOPED AREA NOT INVESTIGATED	N/A	·
Dx	DIXFIELD FINE SANDY LOAM	C	
Em	ELMWOOD VERY FINE SANDY LOAM	C	
LT	LYMAN-TUNBRIDGE COMPLEX	C/D	
Sc	SCANTIC SILT LOAM*	D	i.
Sw	SWANTON VERY FINE SANDY LOAM	C/D	
Ws	WESTBURY FINE SANDY LOAM	С	
	* WETLAND SOILS		

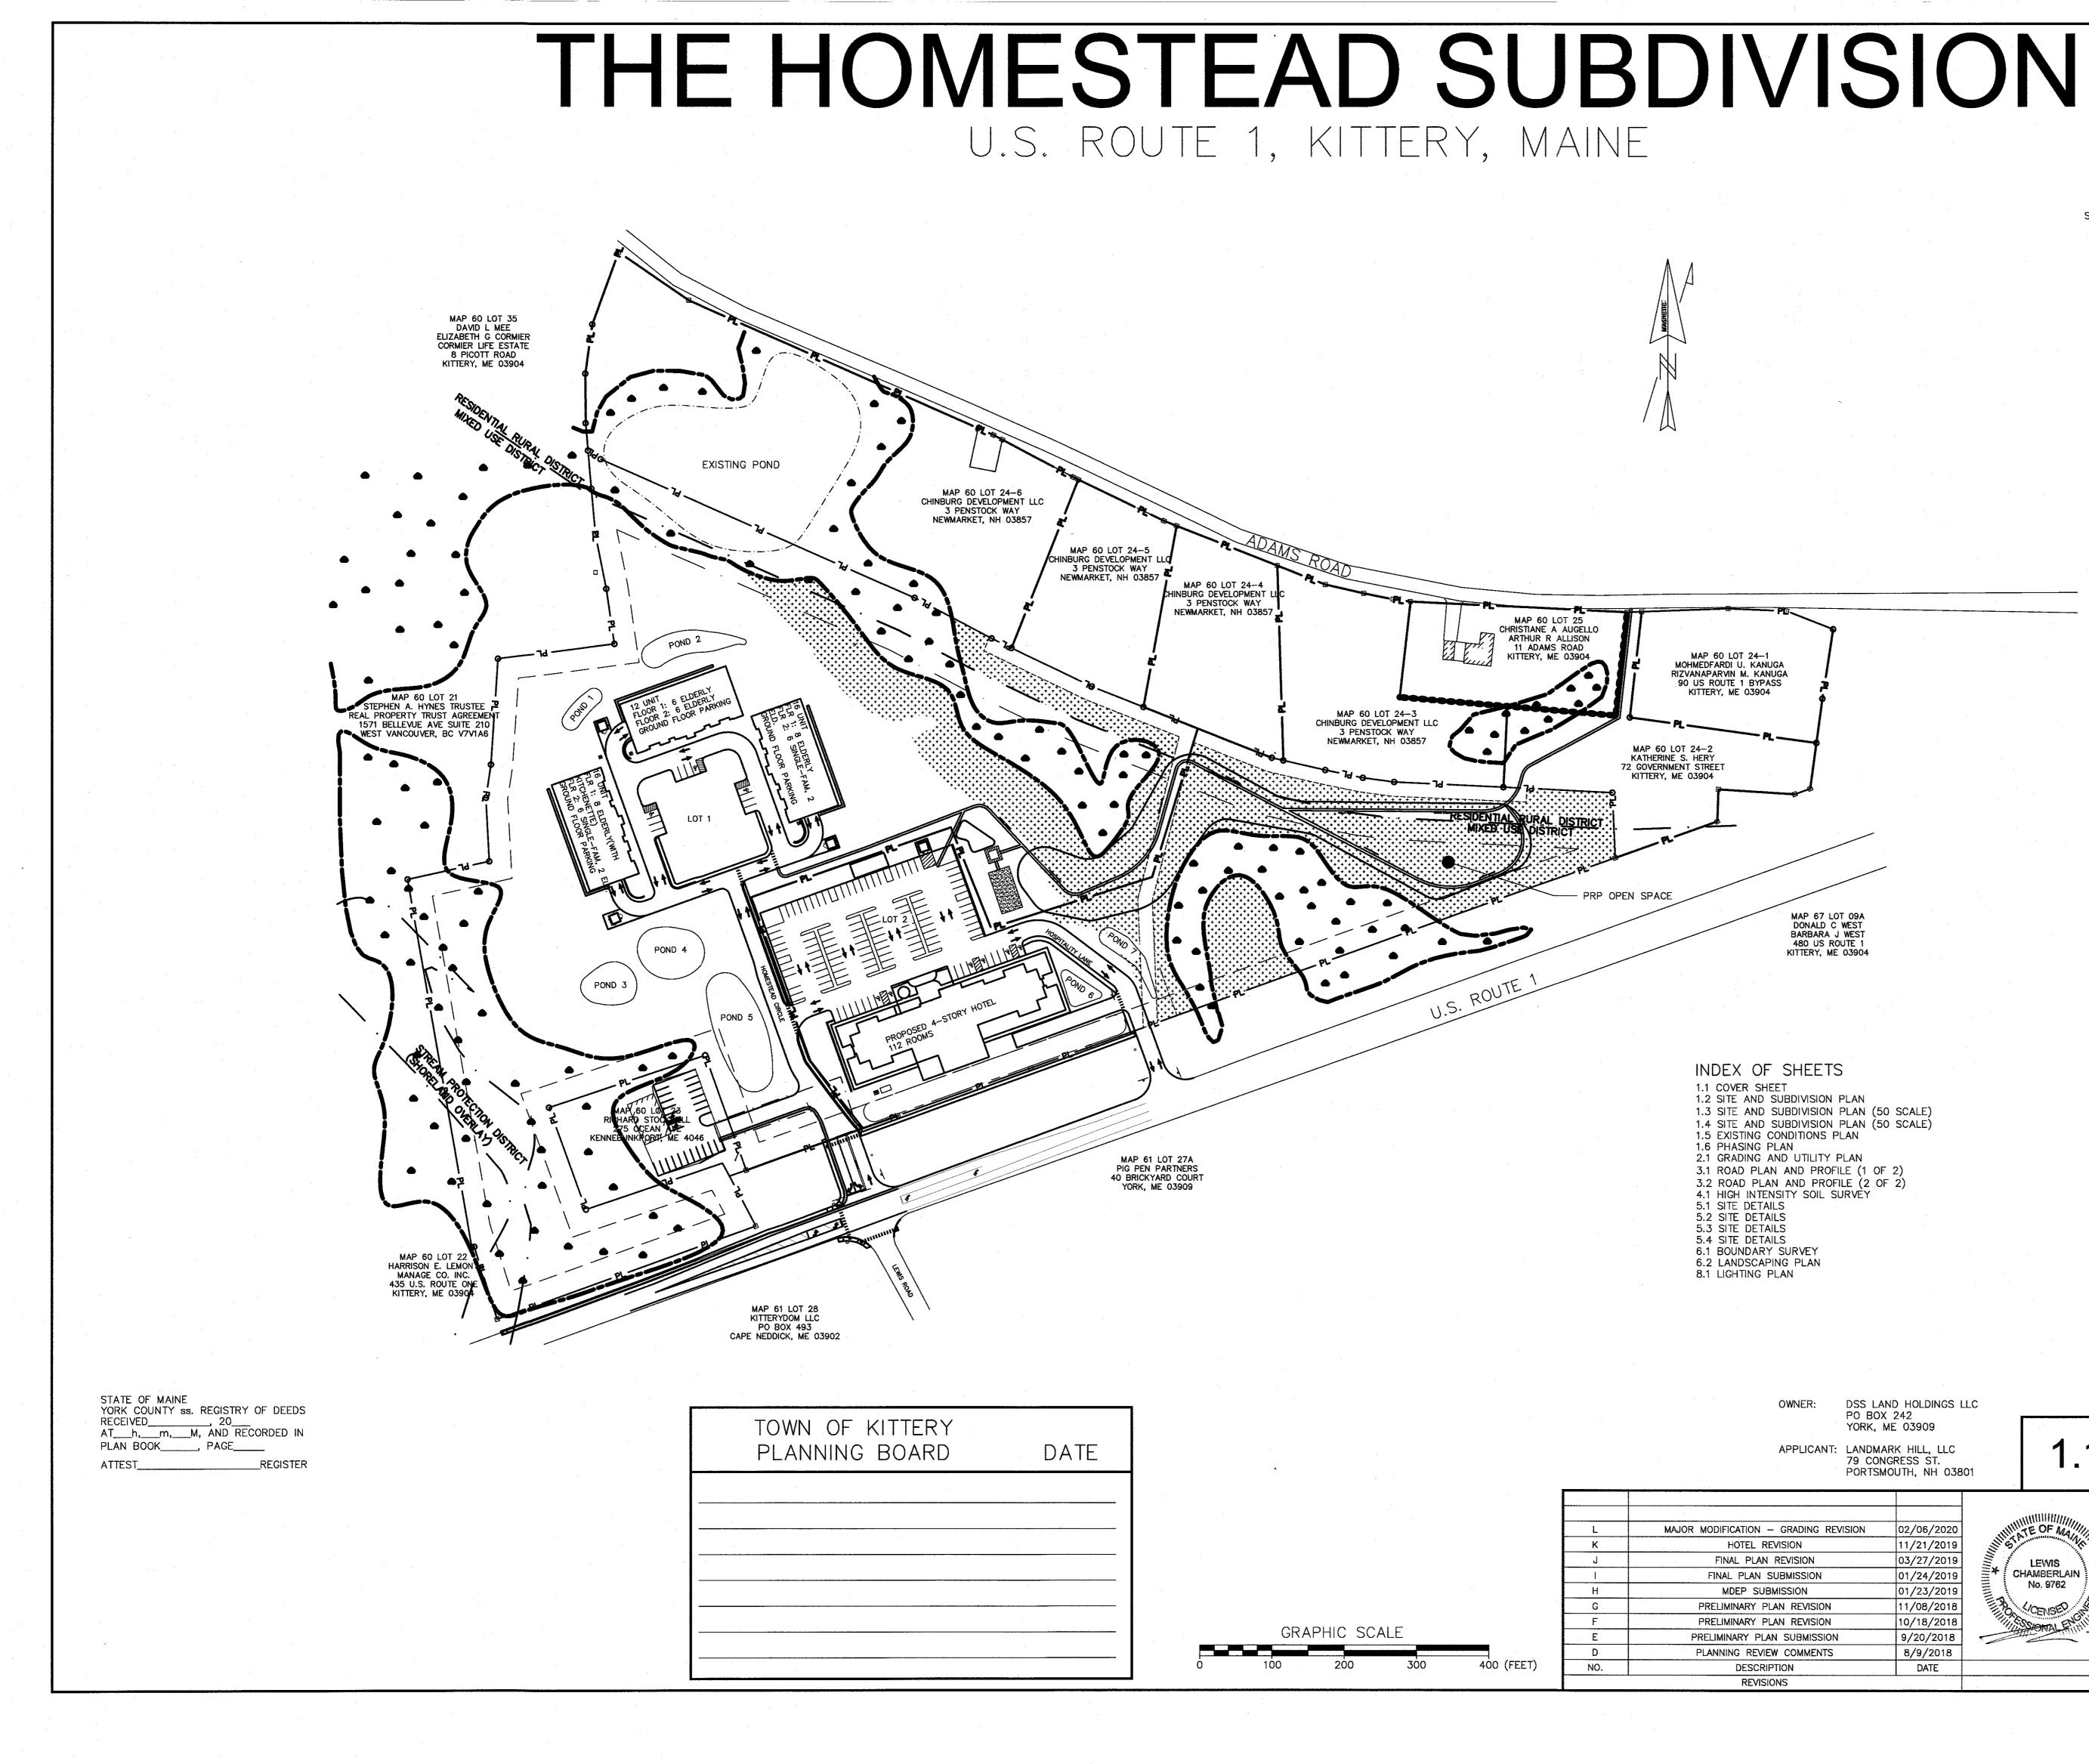

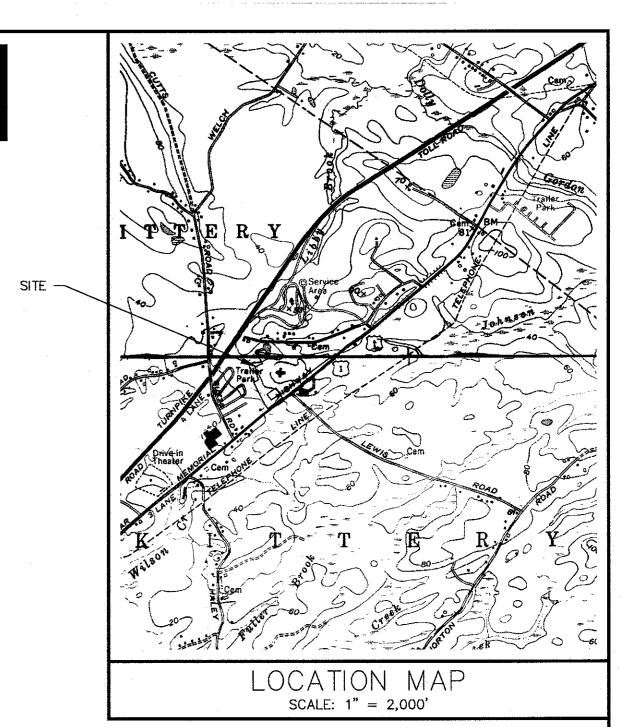

OWNER: DSS LAND HOLDINGS LLC PO BOX 242 YORK, ME 03909 COVER SHEET APPLICANT: LANDMARK HILL, LLC THE HOMESTEAD 79 CONGRESS ST. 459 US ROUTE 1 KITTERY, MAINE PORTSMOUTH, NH 03801 FOR: LANDMARK HILL, LLC 79 CONGRESS ST PORTSMOUTH, NH 03801 IN TE OF MA 02/06/2020 11/21/2019 ATTAR ENGINEERING, INC. 03/27/2019 LEWIS CHAMBERLAIN 01/24/2019 No. 9762 01/23/2019 11/08/2018 (CENSE) 10/18/2018 SCALE: APPROVED BY: DRAWN BY:


9/20/2018

8/9/2018

DATE

1" = 100' BRN -----DATE: **REVISION : DATE** 2/6/20 02/08/2018 L: 02/06/2020 JOB NO: C052-20 FILE: THE HOMESTEAD BASE SHEET 1.1

TAX MAP 60, LOT 24

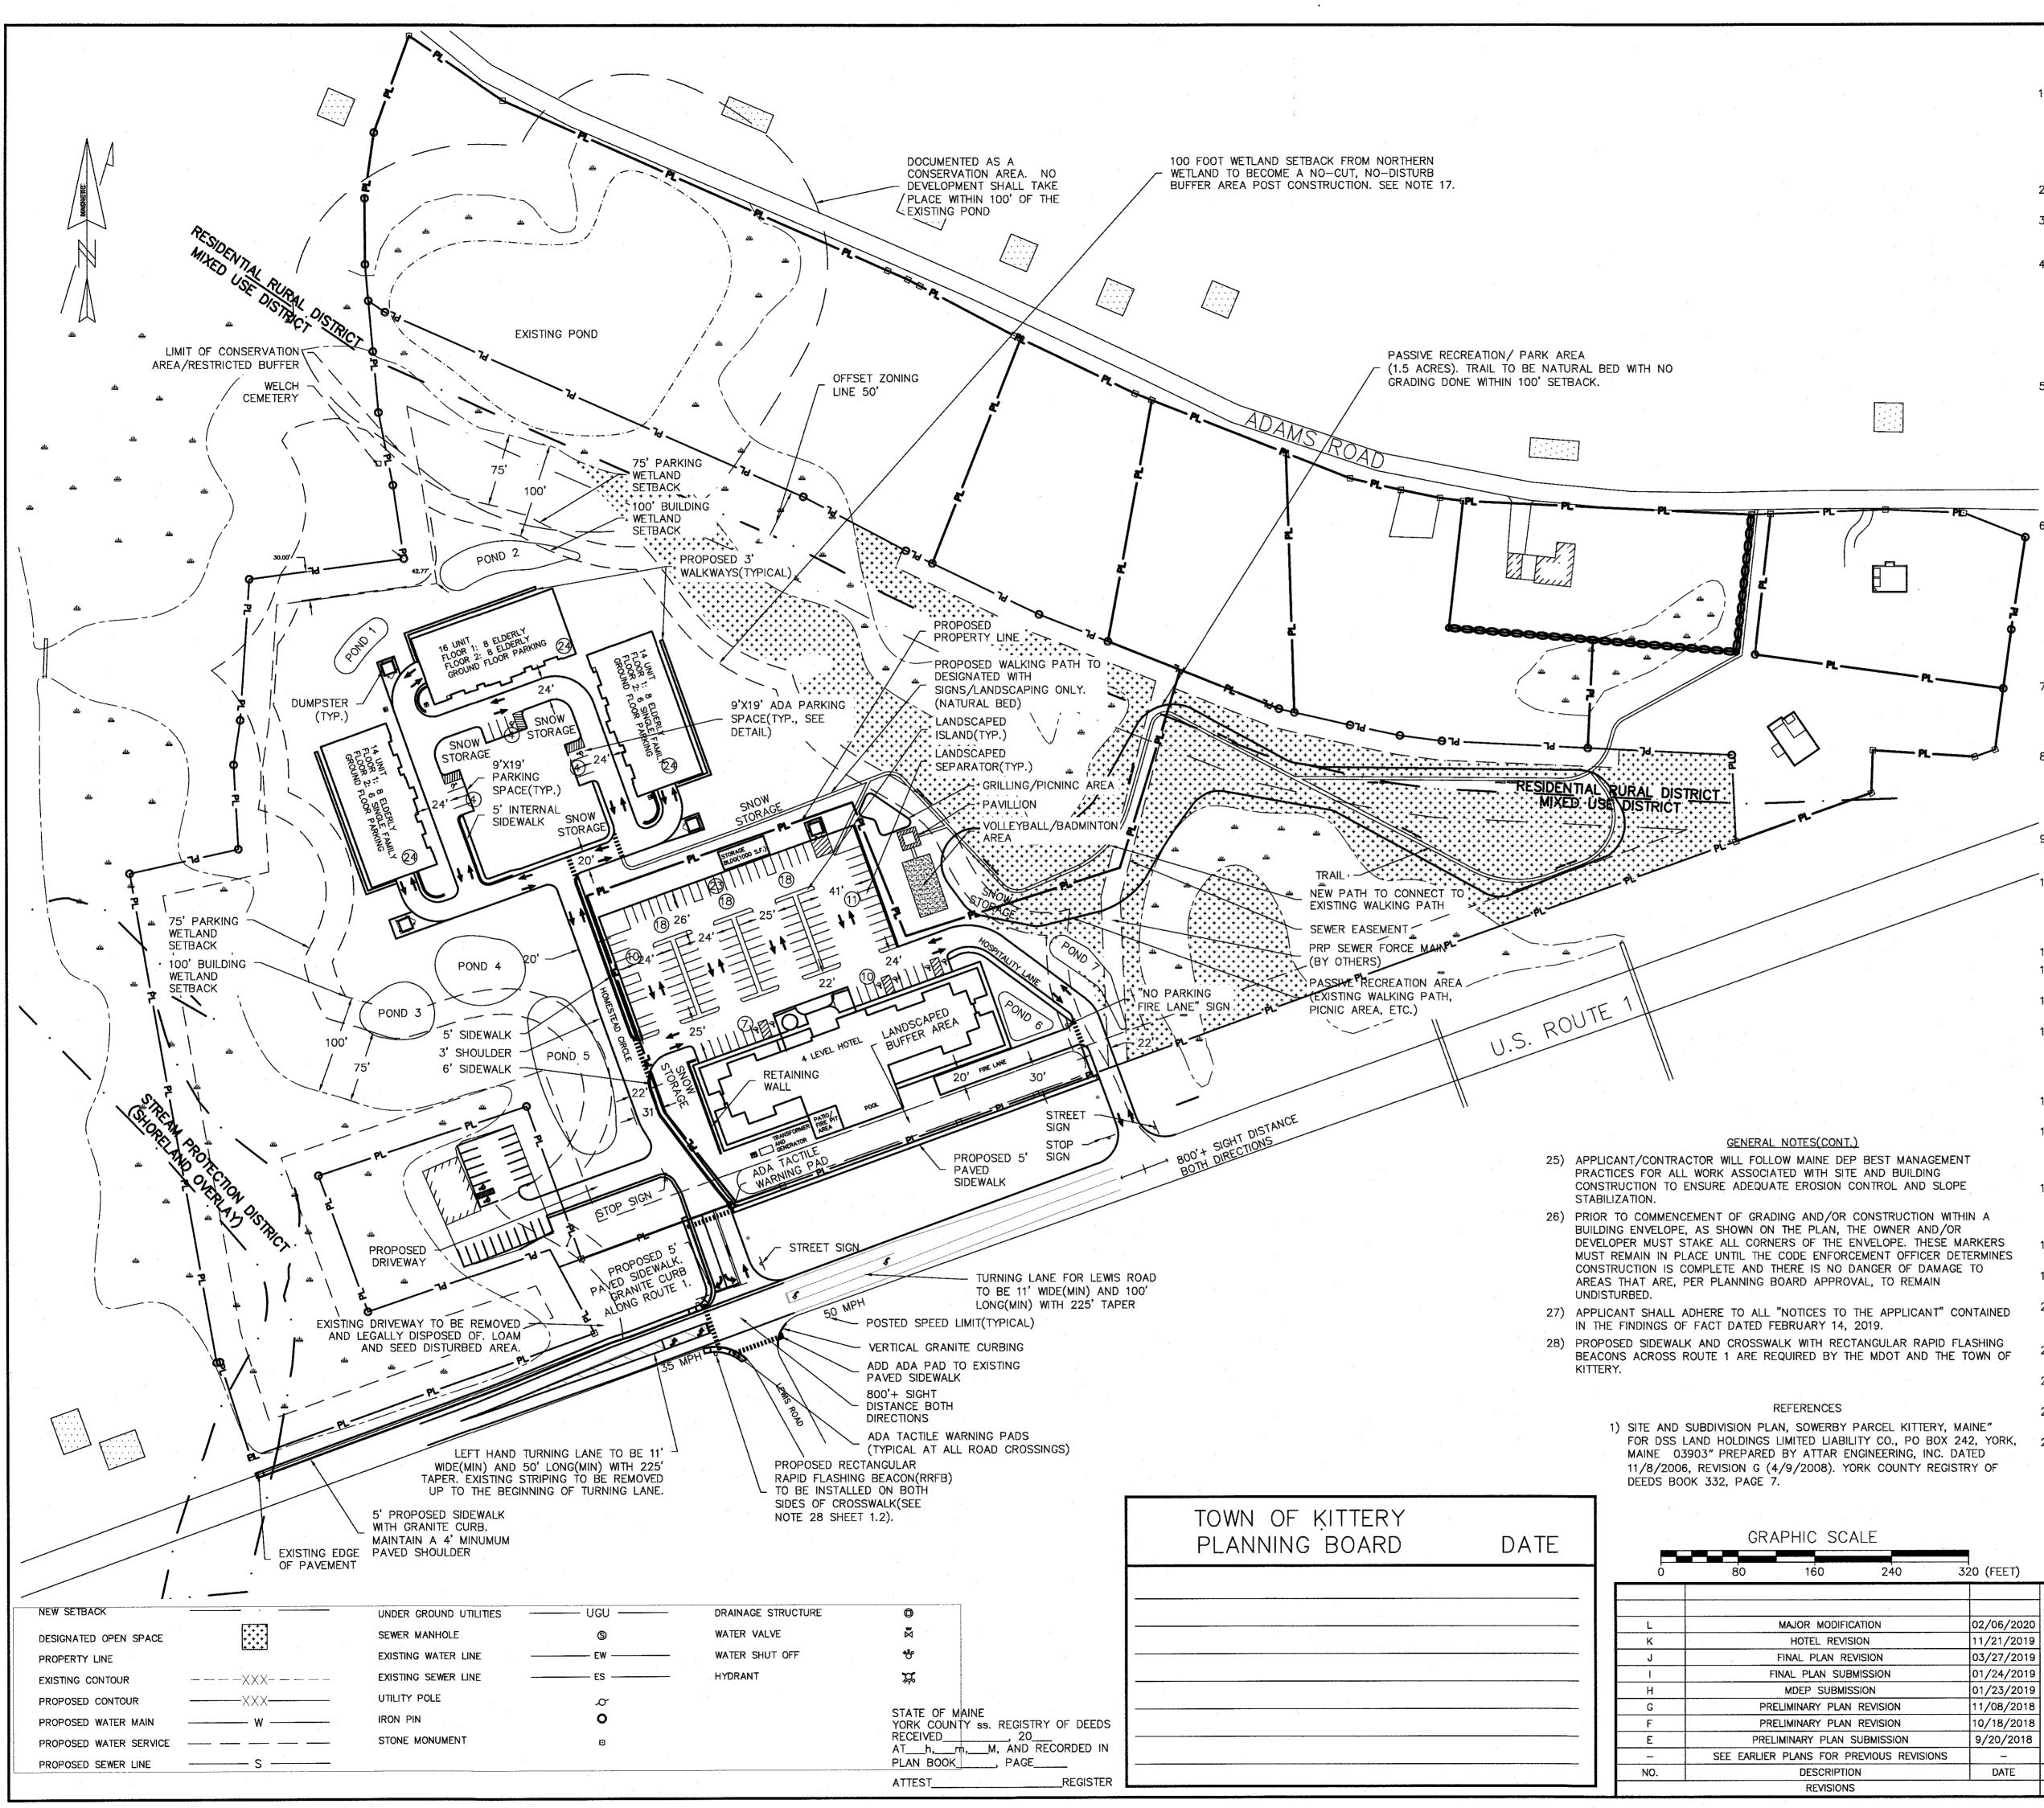

### GENERAL NOTES

- 1) THIS PLAN PROVIDES DETAILS FOR A MIXED USE DEVELOPMENT AT 459 U.S. ROUTE 1 CONSISTING OF 32 SINGLE-FAMILY (ELDERLY) APARTMENTS AND 12 SINGLE-FAMILY RESIDENTIAL UNITS IN 3 BUILDINGS AND A 112 ROOM HOTEL, SINGLE-FAMILY RESIDENTIAL UNITS ON THE UPPER FLOORS OF A MIXED-USE BUILDING ARE A "PERMITTED USE". HOUSING FOR THE ELDERLY AND A HOTEL ARE "SPECIAL EXCEPTION USES". THE PROPERTY IS TO BE SUBDIVIDED INTO TWO SEPARATE PROPERTIES (SEE PROPOSED PROPERTY LINE ON SITE PLANS). LOT 1 HAS 590,468 SF OF AREA AND 552' OF STREET FRONTAGE. LOT 2 HAS 285,904 SF OF AREA AND 1104' OF STREET FRONTAGE.
- 2) THIS SITE WAS PREVIOUSLY APPROVED AS THE SOWERBY MIXED-USE PROJECT IN 2008. SEE REF.
- 3) THE PARCEL, IDENTIFIED AS LOT 24 ON TAX MAP 60, CONTAINS APPROXIMATELY 20.12 ACRES; AND IS LOCATED WITHIN THE MIXED-USE (MU), RESIDENTIAL RURAL (R-RL) AND SHORELAND OVERLAY ZONING DISTRICTS. THE PARCEL IS SERVED BY MUNICIPAL WATER AND SEWER SYSTEMS. 4) SPACE AND BULK REQUIREMENTS FOR THE MIXED USE ZONING DISTRICT ARE AS FOLLOWS:
- MIXED USE DISTRICT MIN. LOT AREA 200,000 SF (LOT 1: 590,468 SF, LOT 2: 285,904 SF) MIN. STREET FRONTAGE 250' (LOT 1: 552', LOT 2: 1104') MIN. FRONT SETBACK MIN. SIDE SETBACK 40' (100' WETLAND SETBACK SUPERCEDES) MIN. REAR SETBACK 40' (100' WETLAND SETBACK SUPERCEDES) MAX BUILDING HEIGHT 5) PARKING IS CALCULATED AS FOLLOWS;
- NO. OF UNITS./SF SPACES/UNIT SF/UNIT REQUIRED UNIT TYPE ELDERLY 32 UNITS 1.5 N/A 48 APARTMENTS 12 UNITS 24 N/A 115(CONF.ROOM) HOTEL 112 N/A

TOTAL REQUIRED SPACES = 187 WITH 199 PROVIDED(24 ON GROUND FLOOR OF RESIDENTIAL BUILDINGS, EACH WITH 2 ADA SPACES, 12 EXTERIOR GUEST SPACES (3 ADA), 6 ADA SPACES AT HOTEL)

6) BUILDABLE AREA/RESIDENTIAL DENSITY


TOTAL PARCEL AREA = LESS 50% OF WETLANDS SETBACK =	876,427.2 S.F. = 137,495.6 S.F. =	
LESS UNSUITABLE SOILS* LESS RIGHTS OF WAY/EASEMENTS**	= 200,630 S.F. = 124,314 S.F.	


NET RESIDENTIAL AREA => 413,987.5 S.F. = 9.50 AC. \*INCLUDES WETLANDS, POORLY DRAINED AND VERY POORLY DRAINED SOILS

- \*\*INCLUDING TRAVELED WAYS AND PARKING <u>NET RESIDENTIAL DENSITY</u> = 413,987.5 - (32 ELD. X 10,000) - (12 SINGLE X 7,500) = 3987.5
- => 0K MIXED-USE REQUIREMENT IS CALCULATED AS FOLLOWS: APARTMENTS = 11,232 S.F. X 2 FLOORS = 22,464 S.F.
- APARTMENTS(ELD.) = 11,232 S.F. X 4 FLOORS = 44,928 S.F.HOTEL = 15,712 S.F. X 4 FLOORS = 62,848 S.F.
- 22,464/130,240 = 17.2% WHICH IS GREATER THAN 10% (REQUIRED).
- PROPERTY LINES, WETLANDS, EXISTING CONDITIONS AND TOPOGRAPHY ARE FROM REFERENCE 1. WETLANDS WERE IDENTIFIED IN THE FIELD BY KENNETH A. WOOD, CWS IN DECEMBER, 1999 AND MICHAEL R. CUOMO, CWS, CSS IN MARCH, 2000. WETLANDS WERE LOCATED WITH SURVEY INSTRUMENT BY ATTAR ENGINEERING, INC. FROM DECEMBER, 1999 THROUGH APRIL, 2000. WETLAND DELINEATION WAS VERIFIED IN 2017 BY KENNETH A. WOOD, CWS. NO CHANGES WERE NOTED FROM THE PREVIOUS DELINEATION.
- TOTAL OPEN SPACE REQUIRED IS 35%; 25% OF OPEN SPACE MUST BE IN FRONT 50% OF THE PARCEL: 20.23 AC X 0.35 = 7.08 AC REQUIRED WITH 7.29 AC PROVIDED: 7.08 AC X 0.25 =1.77 AC REQUIRED WITH 5.58 AC PROVIDED IN THE FRONT OF THE PARCEL.
- 10) LANDSCAPING ALONG THE FRONTAGE OF US ROUTE 1 SHALL CONSIST OF A MIXTURE OF EVERGREEN AND DECIDUOUS TREES AND SHRUBS. TREES TO BE ON 25' C.L. SPACING AND A MIX OF 10 SHRUBS AND/OR FLOWERING PERENNIAL PLANT SPECIES FOR EVERY 40' OF FRONTAGE. 66 TOTAL TREES AND 410 SHRUBS TO BE PLANTED IN LANDSCAPED PLANTER STRIP ALONG STREET FRONTAGE. TREES TO BE A MINIMUM 2.5" CALIPER AND 12' HIGH AT TIME OF PLANTING.
- 11) ALL BUILDINGS WILL BE SPRINKLED FOR FIRE PROTECTION
- 12) TOTAL AREA TO BE DISTURBED: 8.92 ACRES, TOTAL IMPERVIOUS AREA: 3.89 ACRES, TOTAL LOT STREET FRONTAGE 1655.7 FT.
- 13) A 50' ZONE BOUNDARY EXTENSION IS REQUESTED FOR THE MIXED-USE BOUNDARY TO THE NORTH(SHOWN ON SITE PLAN).
- 14) EXPECTED ANNUAL AVERAGE DAILY TRAFFIC(AADT) = 32 X 3.48(ELDERLY, ITE 252) + 12 X 6.59(RESIDENTIAL/APARTMENT, ITE 221) + 112 X 8.92(HOTEL, ITE 310/320) = 1,190 TRIPS/DAY 190 TRIPS WILL BE GENERATED BY THE RESIDENTIAL AND ELDERLY UNITS ON HOMESTEAD CIRCLE AM AND PM PEAK HOUR TRIPS ESTIMATED AT 115 AND 133 RESPECTIVELY(DEVELOPMENT AND ABUTTING MEDICAL OFFICE). SEE TRAFFIC STUDY FOR ADDITIONAL INFORMATION.
- 15) RESIDENTS OF THE ELDERLY AND APARTMENT UNITS WILL BE ALLOWED TO PURCHASE HEALTH CLUB/POOL MEMBERSHIPS FROM THE HOTEL.
- 16) HOMESTEAD CIRCLE AND HOSPITALITY LANE TO BE AND MUST REMAIN PRIVATE ROADS. WITH THE PROPERTY OWNERS OR OTHER SUCH ENTITIES BEARING ALL RESPONSIBILITY FOR MAINTENANCE INCLUDING BUT NOT LIMITED TO, SNOWPLOWING, PAVING AND STORMWATER SYSTEM OPERATION AND REPAIR. NO ON-STREET PARKING WILL BE PERMITTED.
- 17) WITH THE EXCEPTION OF THE PROPOSED CONSTRUCTION IN THIS PLAN THE 100 FT SETBACK FROM THE NORTHERN WETLAND WILL BECOME A NO CUT, NO DISTURB RESTRICTED BUFFER AREA AND MUST REMAIN UNDEVELOPED AND UNDISTURBED IN PERPETUITY, INCLUDING NO MOWING OR REMOVAL OF ANY VEGETATION WITHOUT A PERMIT FROM THE CODE ENFORCEMENT OFFICER.
- 18) IF ON-SITE SNOW STORAGE AREAS DO NOT HAVE ENOUGH CAPACITY ADDITIONAL SNOW SHALL BE REMOVED FROM THE SITE. 19) KITCHENETTE/MEETING SPACE TO BE INCLUDED ON FIRST FLOOR OF WESTERN APARTMENT
- BUILDING. 20) SEE THE APPROVED "THE HOMESTEAD-MIXED USE DEVELOPMENT, OPERATION AND MAINTENANCE
- PROGRAM STORMWATER MANAGEMENT BMP'S" FOR MAINTENANCE OF ALL STORMWATER BEST MANAGEMENT PRACTICES.
- 21) A ROAD ACCESS EASEMENT SHALL BE PROVIDED TO LOT 2(HOTEL) FOR THE USE OF HOMESTEAD CIRCLE IN ORDER TO ENTER AND EXIT THE HOTEL PARKING LOT. 22) BUILDING DESIGN PLANS FOR THE HOTEL MUST BE APPROVED BY THE PLANNING BOARD PRIOR TO
- ISSUANCE OF A BUILDING PERMIT FOR THE HOTEL BUILDING. 23) A MAINTENANCE PLAN AND AGREEMENT MUST BE PROVIDED TO THE SATISFACTION OF THE TOWN
- PEER REVIEW ENGINEER AND THE TOWN ATTORNEY. 24) NO CHANGES, ERASURES, MODIFICATIONS, OR REVISIONS MAY BE MADE TO THE APPROVED PLAN,
- INCLUDING NO FURTHER LAND DIVISION OR ADDITIONAL DWELLING UNITS MAY BE ESTABLISHED WITHOUT PLANNING BOARD APPROVAL.

			·			
240 3			1.2		ND SUBDIVISION THE HOMESTEAD ROUTE 1 KITTEF	)
DIFICATION	02/06/2020	NIN STATE	OF MANNE		NDMARK HILL, LLC 79 CONGRESS ST TSMOUTH, NH 0380	
REVISION SUBMISSION BMISSION	03/27/2019 01/24/2019 01/23/2019		LEWIS MBERLAIN Io. 9762		RENGINEERING	RINE E 03903
LAN REVISION LAN REVISION AN SUBMISSION	11/08/2018 10/18/2018 9/20/2018		ONAL	PHONE: (20 SCALE: 1" = 80'	07)439-6023 FAX: (207 APPROVED BY:	)439-2128 DRAWN BY: BRN
R PREVIOUS REVISIONS	– DATE			DATE: 02/08/2018	2/6/20	REVISION : DATE L: 02/06/2020
ONS			· · · · · · · · · · · · · · · · · · ·	JOB NO: C052-20	FILE: THE HOMESTEAD BASE	SHEET 1.2


TAX MAP 60, LOT 24

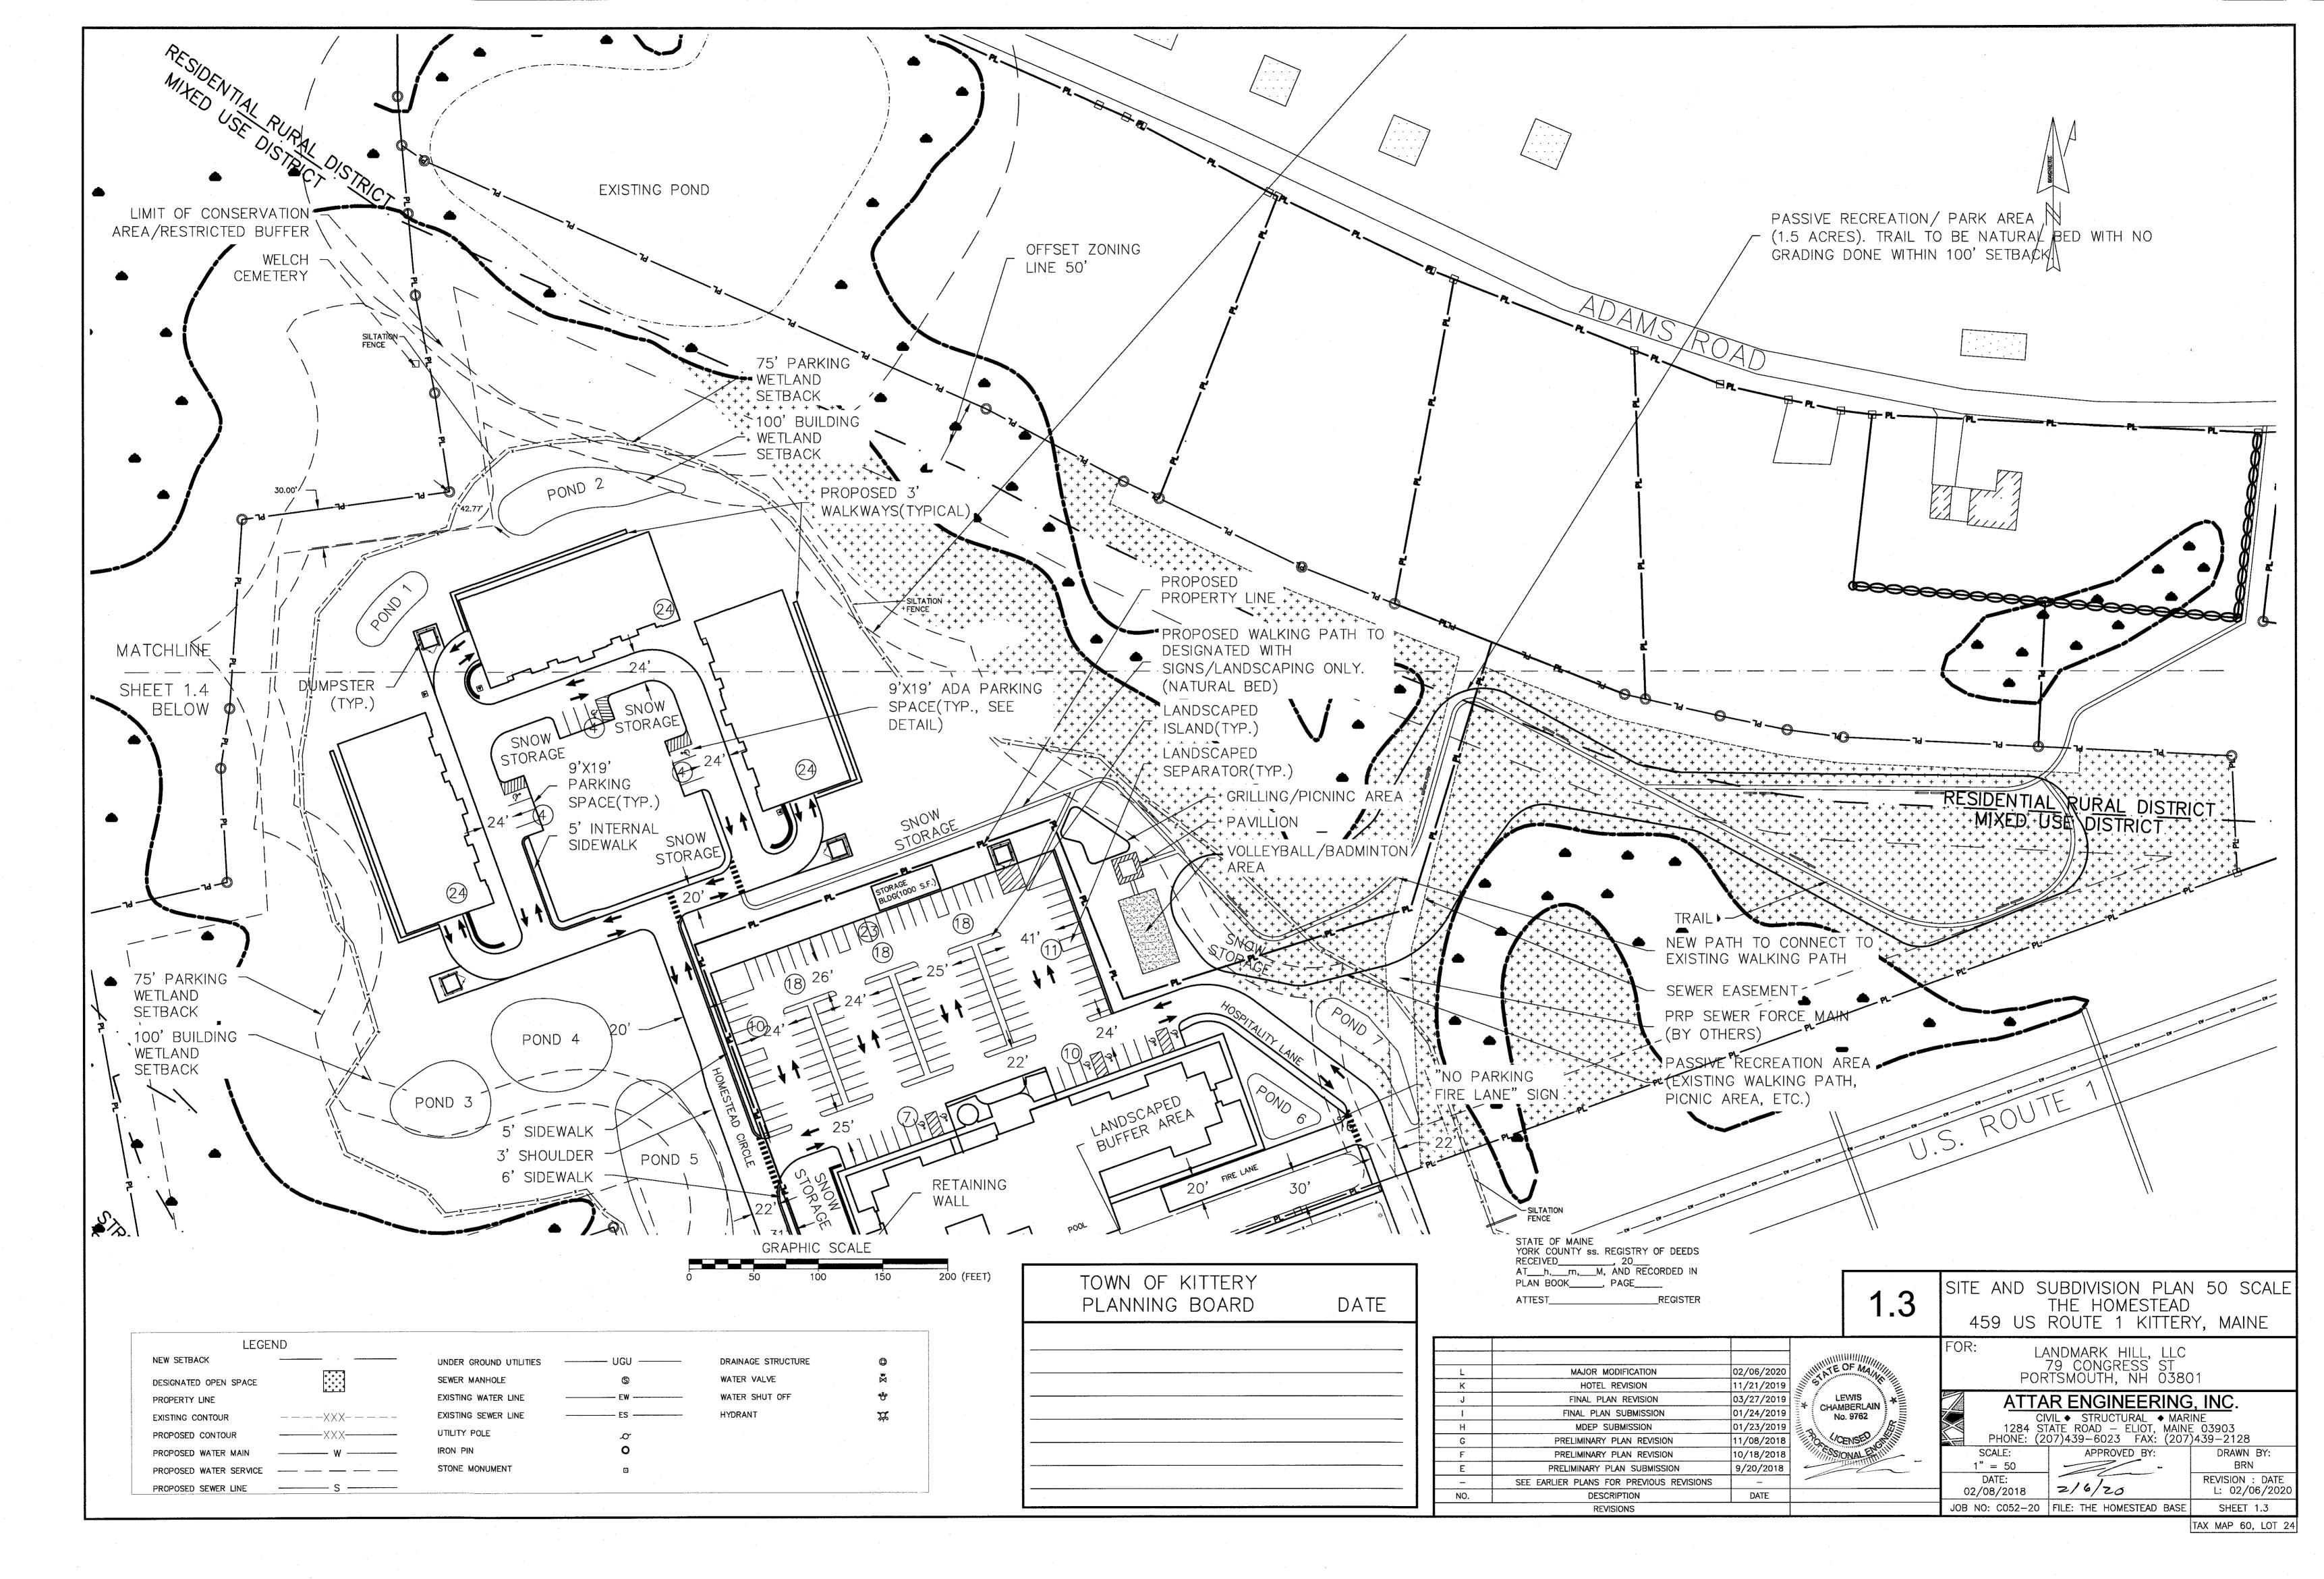


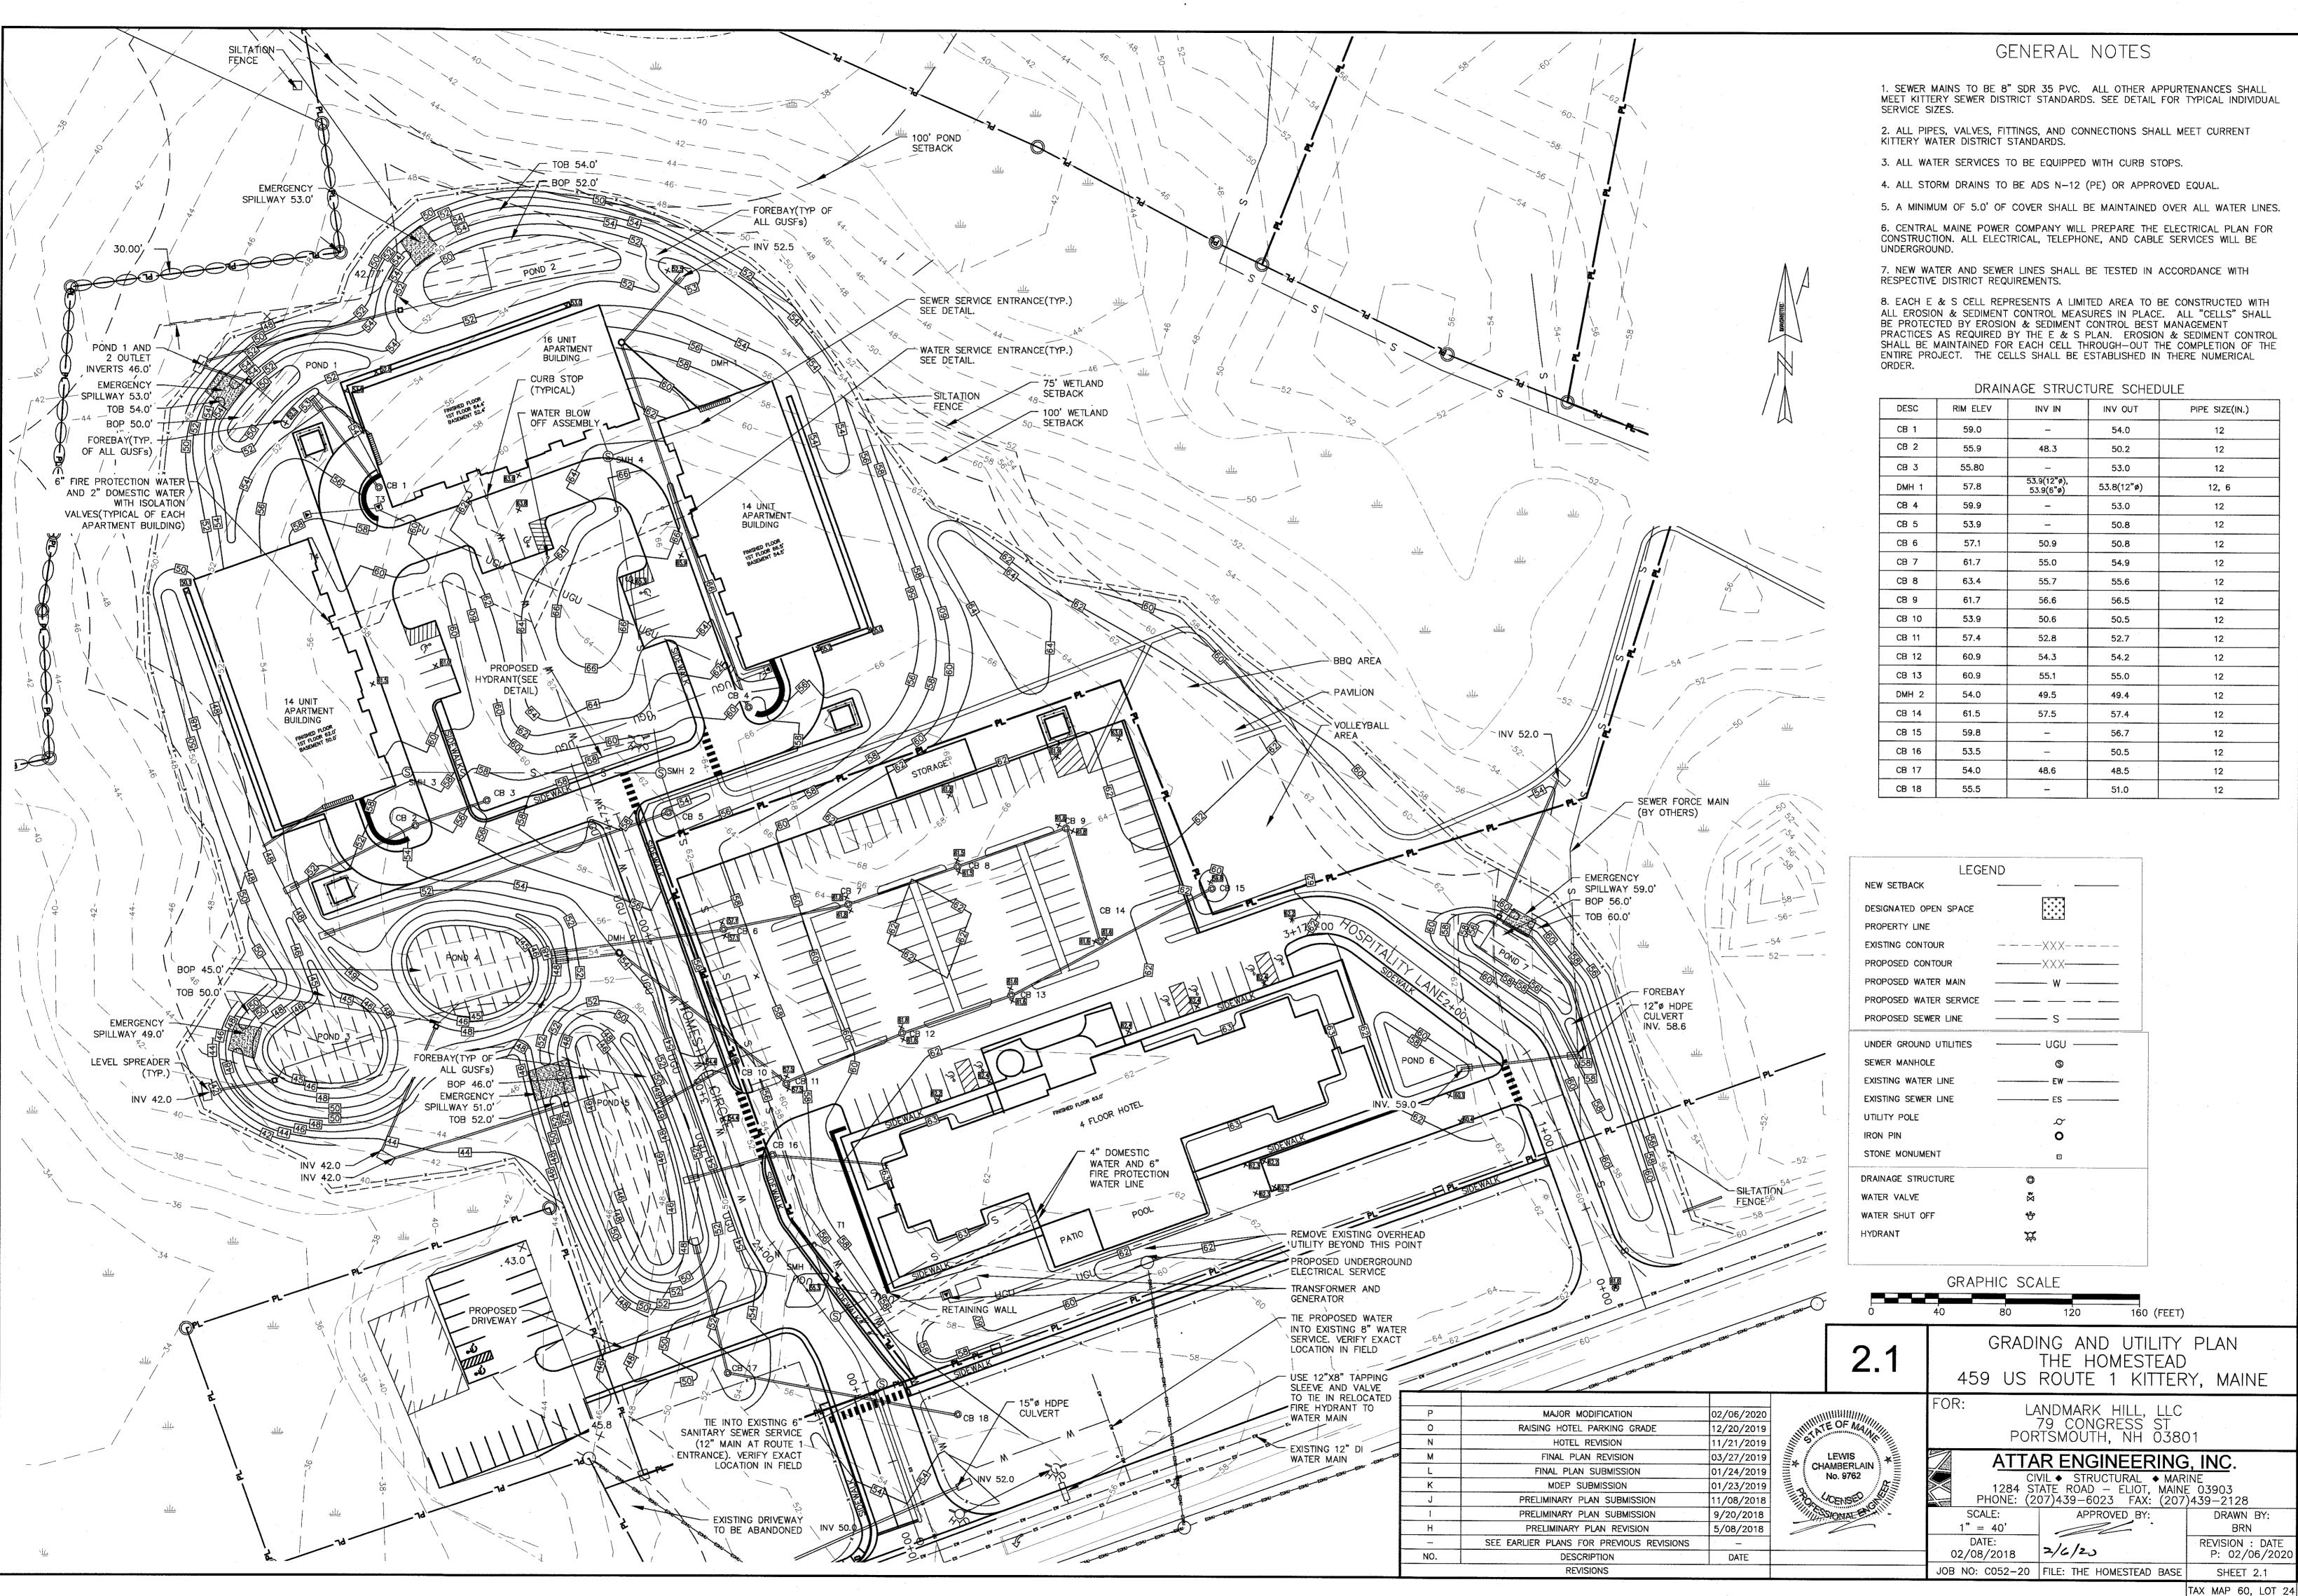


DRAINAGE	STRUCTURE	SCHEDULE
----------	-----------	----------

DESC		1818.7 181		
DESC	RIM ELEV	INV IN	INV OUT	PIPE SIZE(IN.)
CB 1	59.0		54.0	12
CB 2	55.9	48.3	50.2	12
CB 3	55.80	·	53.0	12
DMH 1	57.8	53.9(12"ø), 53.9(6"ø)	53.8(12"ø)	12, 6
CB 4	59.9	-	53.0	12
CB 5	53.9		50.8	12
CB 6	57.1	50.9	50.8	12
CB 7	61.7	55.0	54.9	12
CB 8	63.4	55.7	55.6	12
CB 9	61.7	56.6	56.5	12
CB 10	53.9	50.6	50.5	12 <sup>.</sup>
CB 11	57.4	52.8	52.7	12
CB 12	60.9	54.3	54.2	12
CB 13	60.9	55.1	55.0	12
DMH 2	54.0	49.5	49.4	12
CB 14	61.5	57.5	57.4	12
CB 15	59.8		56.7	12
CB 16	53.5		50.5	12
CB 17	54.0	48.6	48.5	12
CB 18	55.5		51.0	12

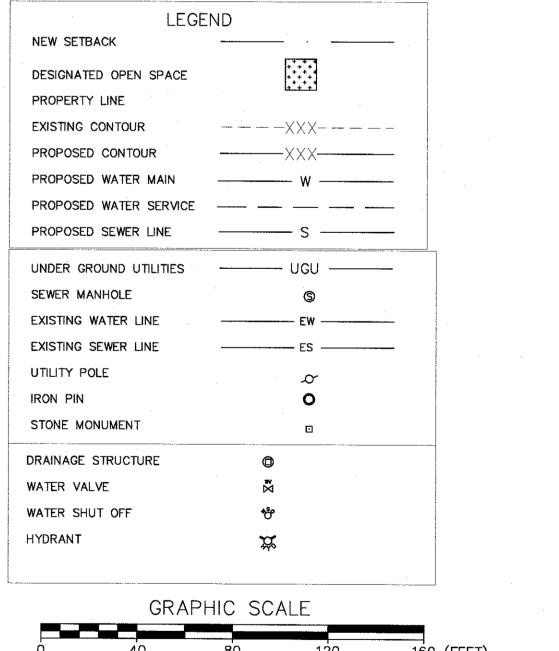

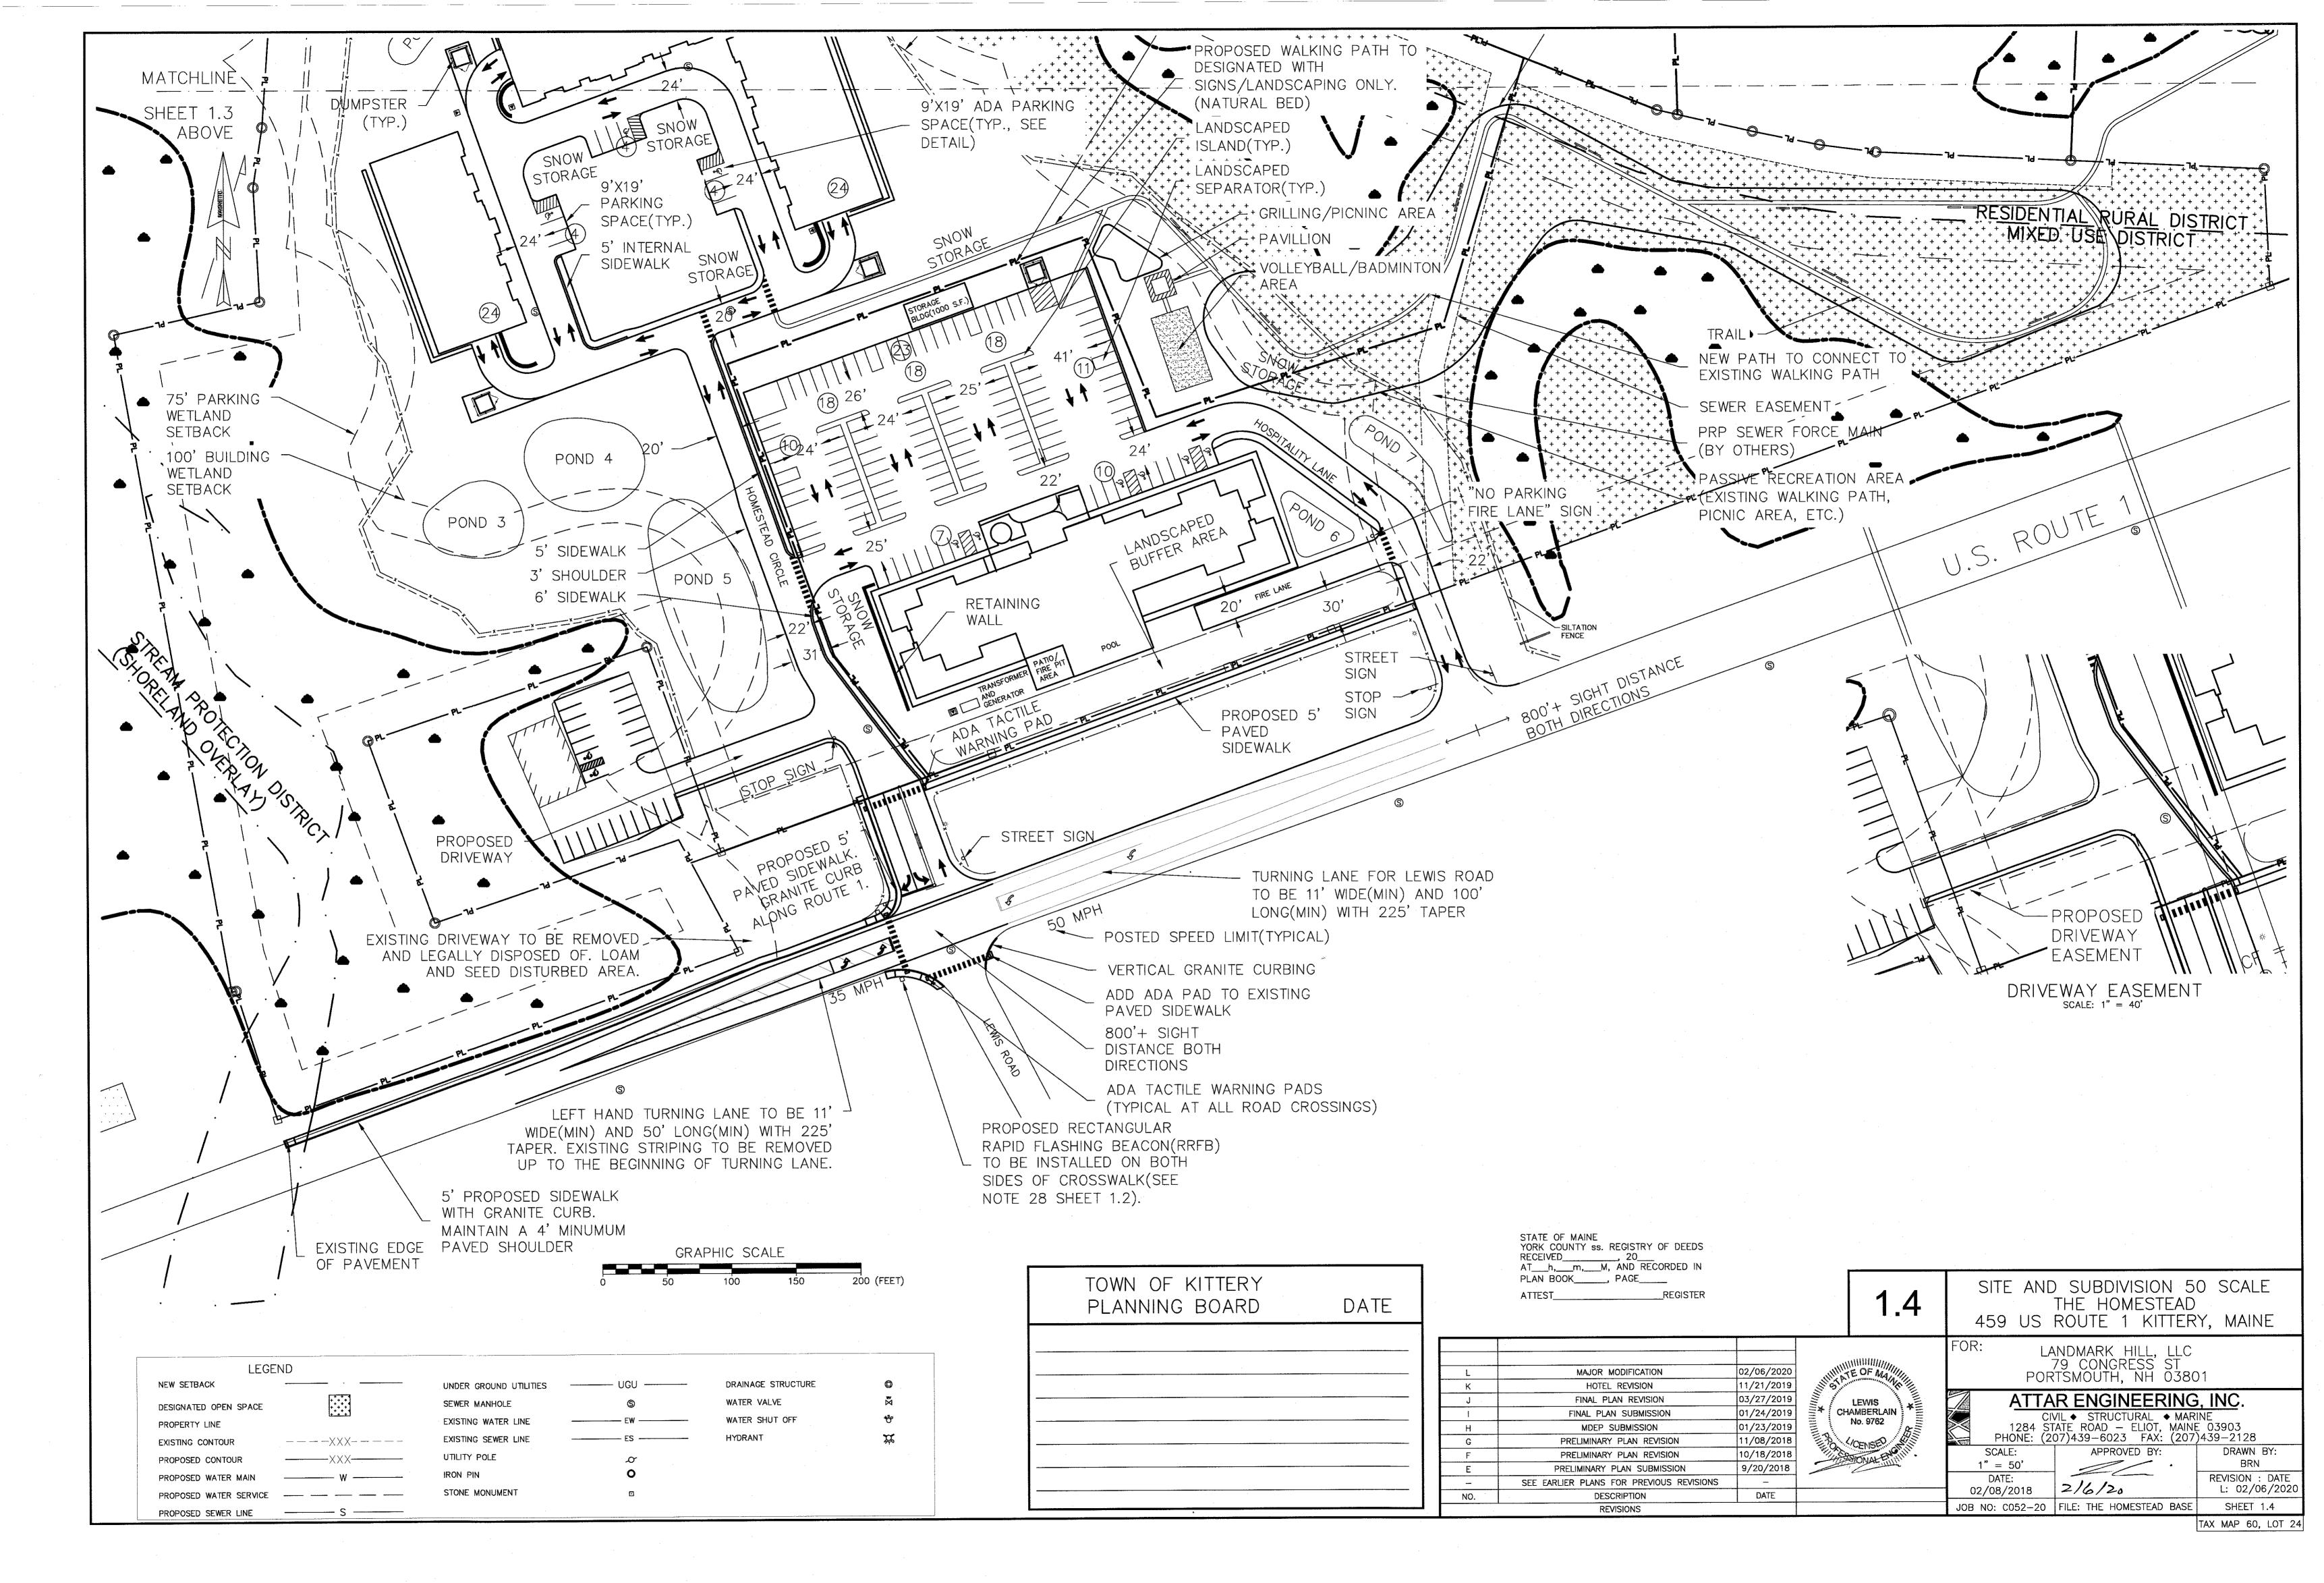

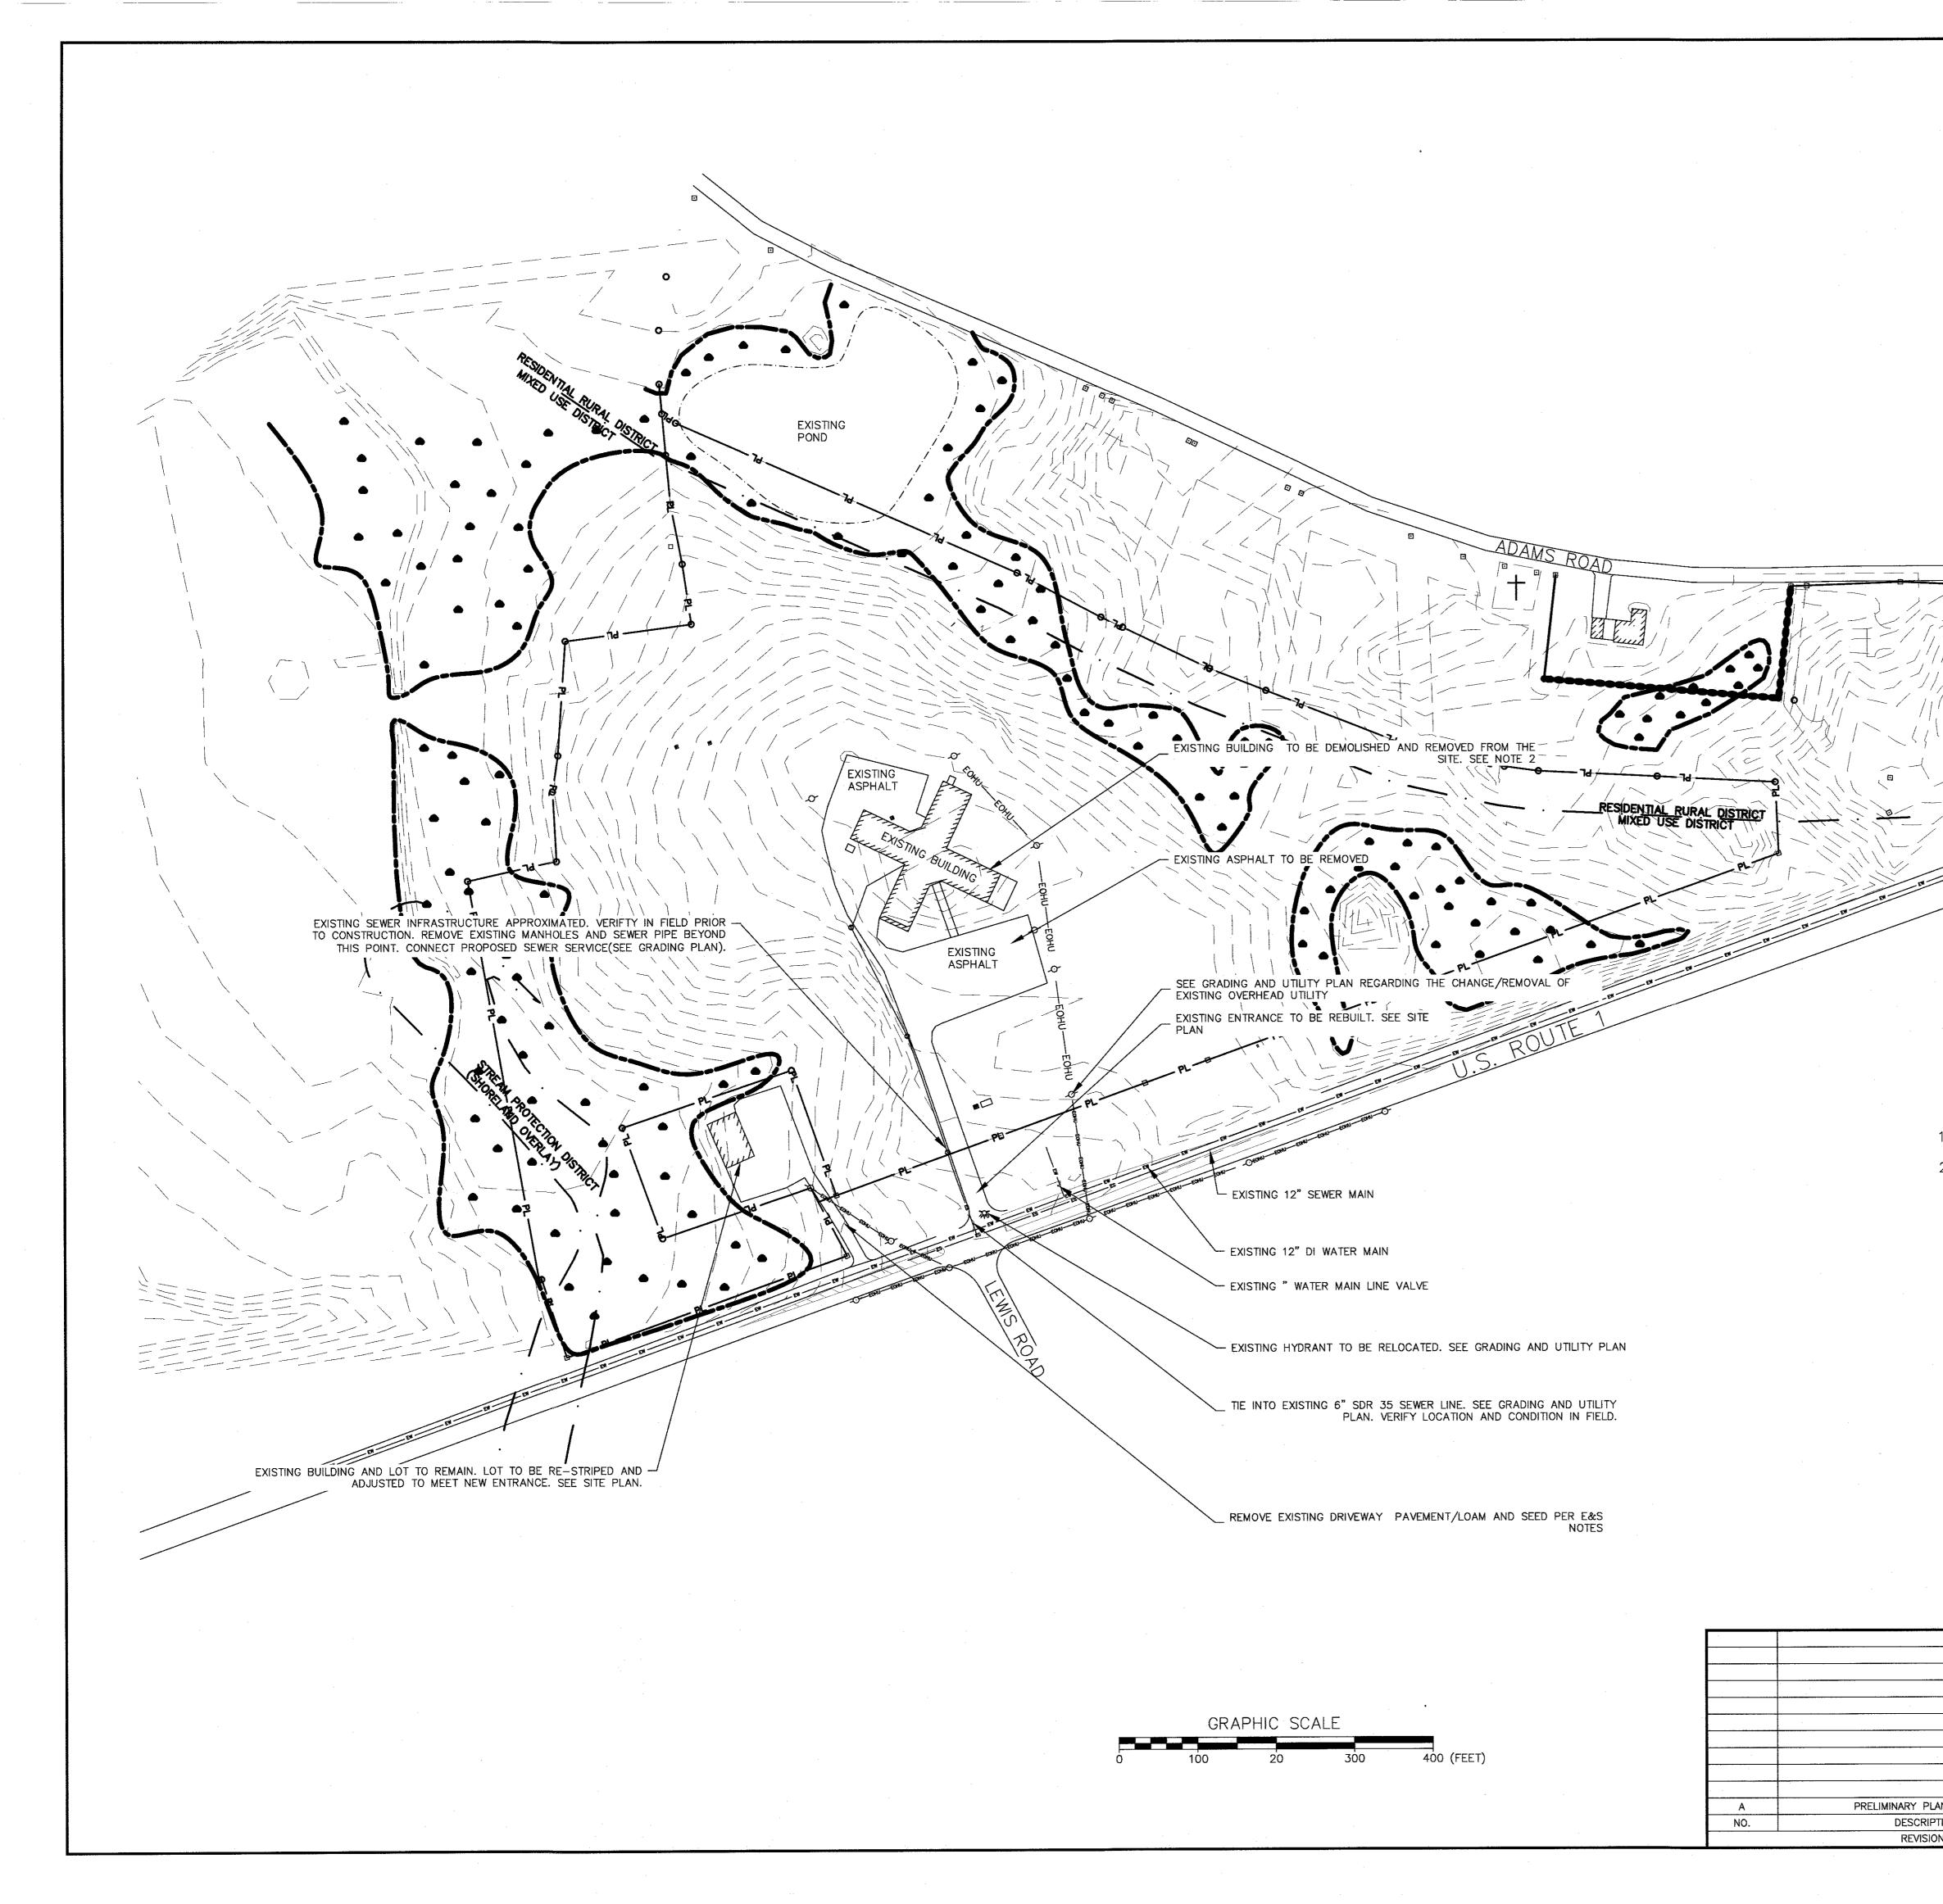




## GENERAL NOTES

 LEGAL, OFFSITE DISPOSAL OF DEMOLISHED MATERIALS SHALL BE THE RESPONSIBILITY OF THE GENERAL CONTRACTOR.
 FILLING OF EXISTING EXCAVATED AREAS AFTER DEMOLITION SHALL BE ACCOMPLISHED IN ACCORDANCE WITH PRACTICES RECOMMENDED BY A LICENSE GEOTECHNICAL ENGINEER.

		1.5		NG CONDITION THE HOMESTE ROUTE 1 KITT	AD
			-	NDMARK HILL, L 79 CONGRESS S TSMOUTH, NH O	T
				R ENGINEERI /IL ◆ STRUCTURAL ◆ ATE ROAD – ELIOT, N D7)439-6023 FAX: (	MARINE
		The second s	SCALE: 1" = 100'	APPROVED BY:	DRAWN BY: BRN
AN REVISION	5/8/2018		DATE: 1/18/2018	Stor Cal	REVISION : DATE A: 05/08/2018
TION	DATE		JOB NO: C052-18	FILE: THE HOMESTEAD E	
		· · · · · · · · · · · · · · · · · · ·			TAX MAP 60, LOT 24

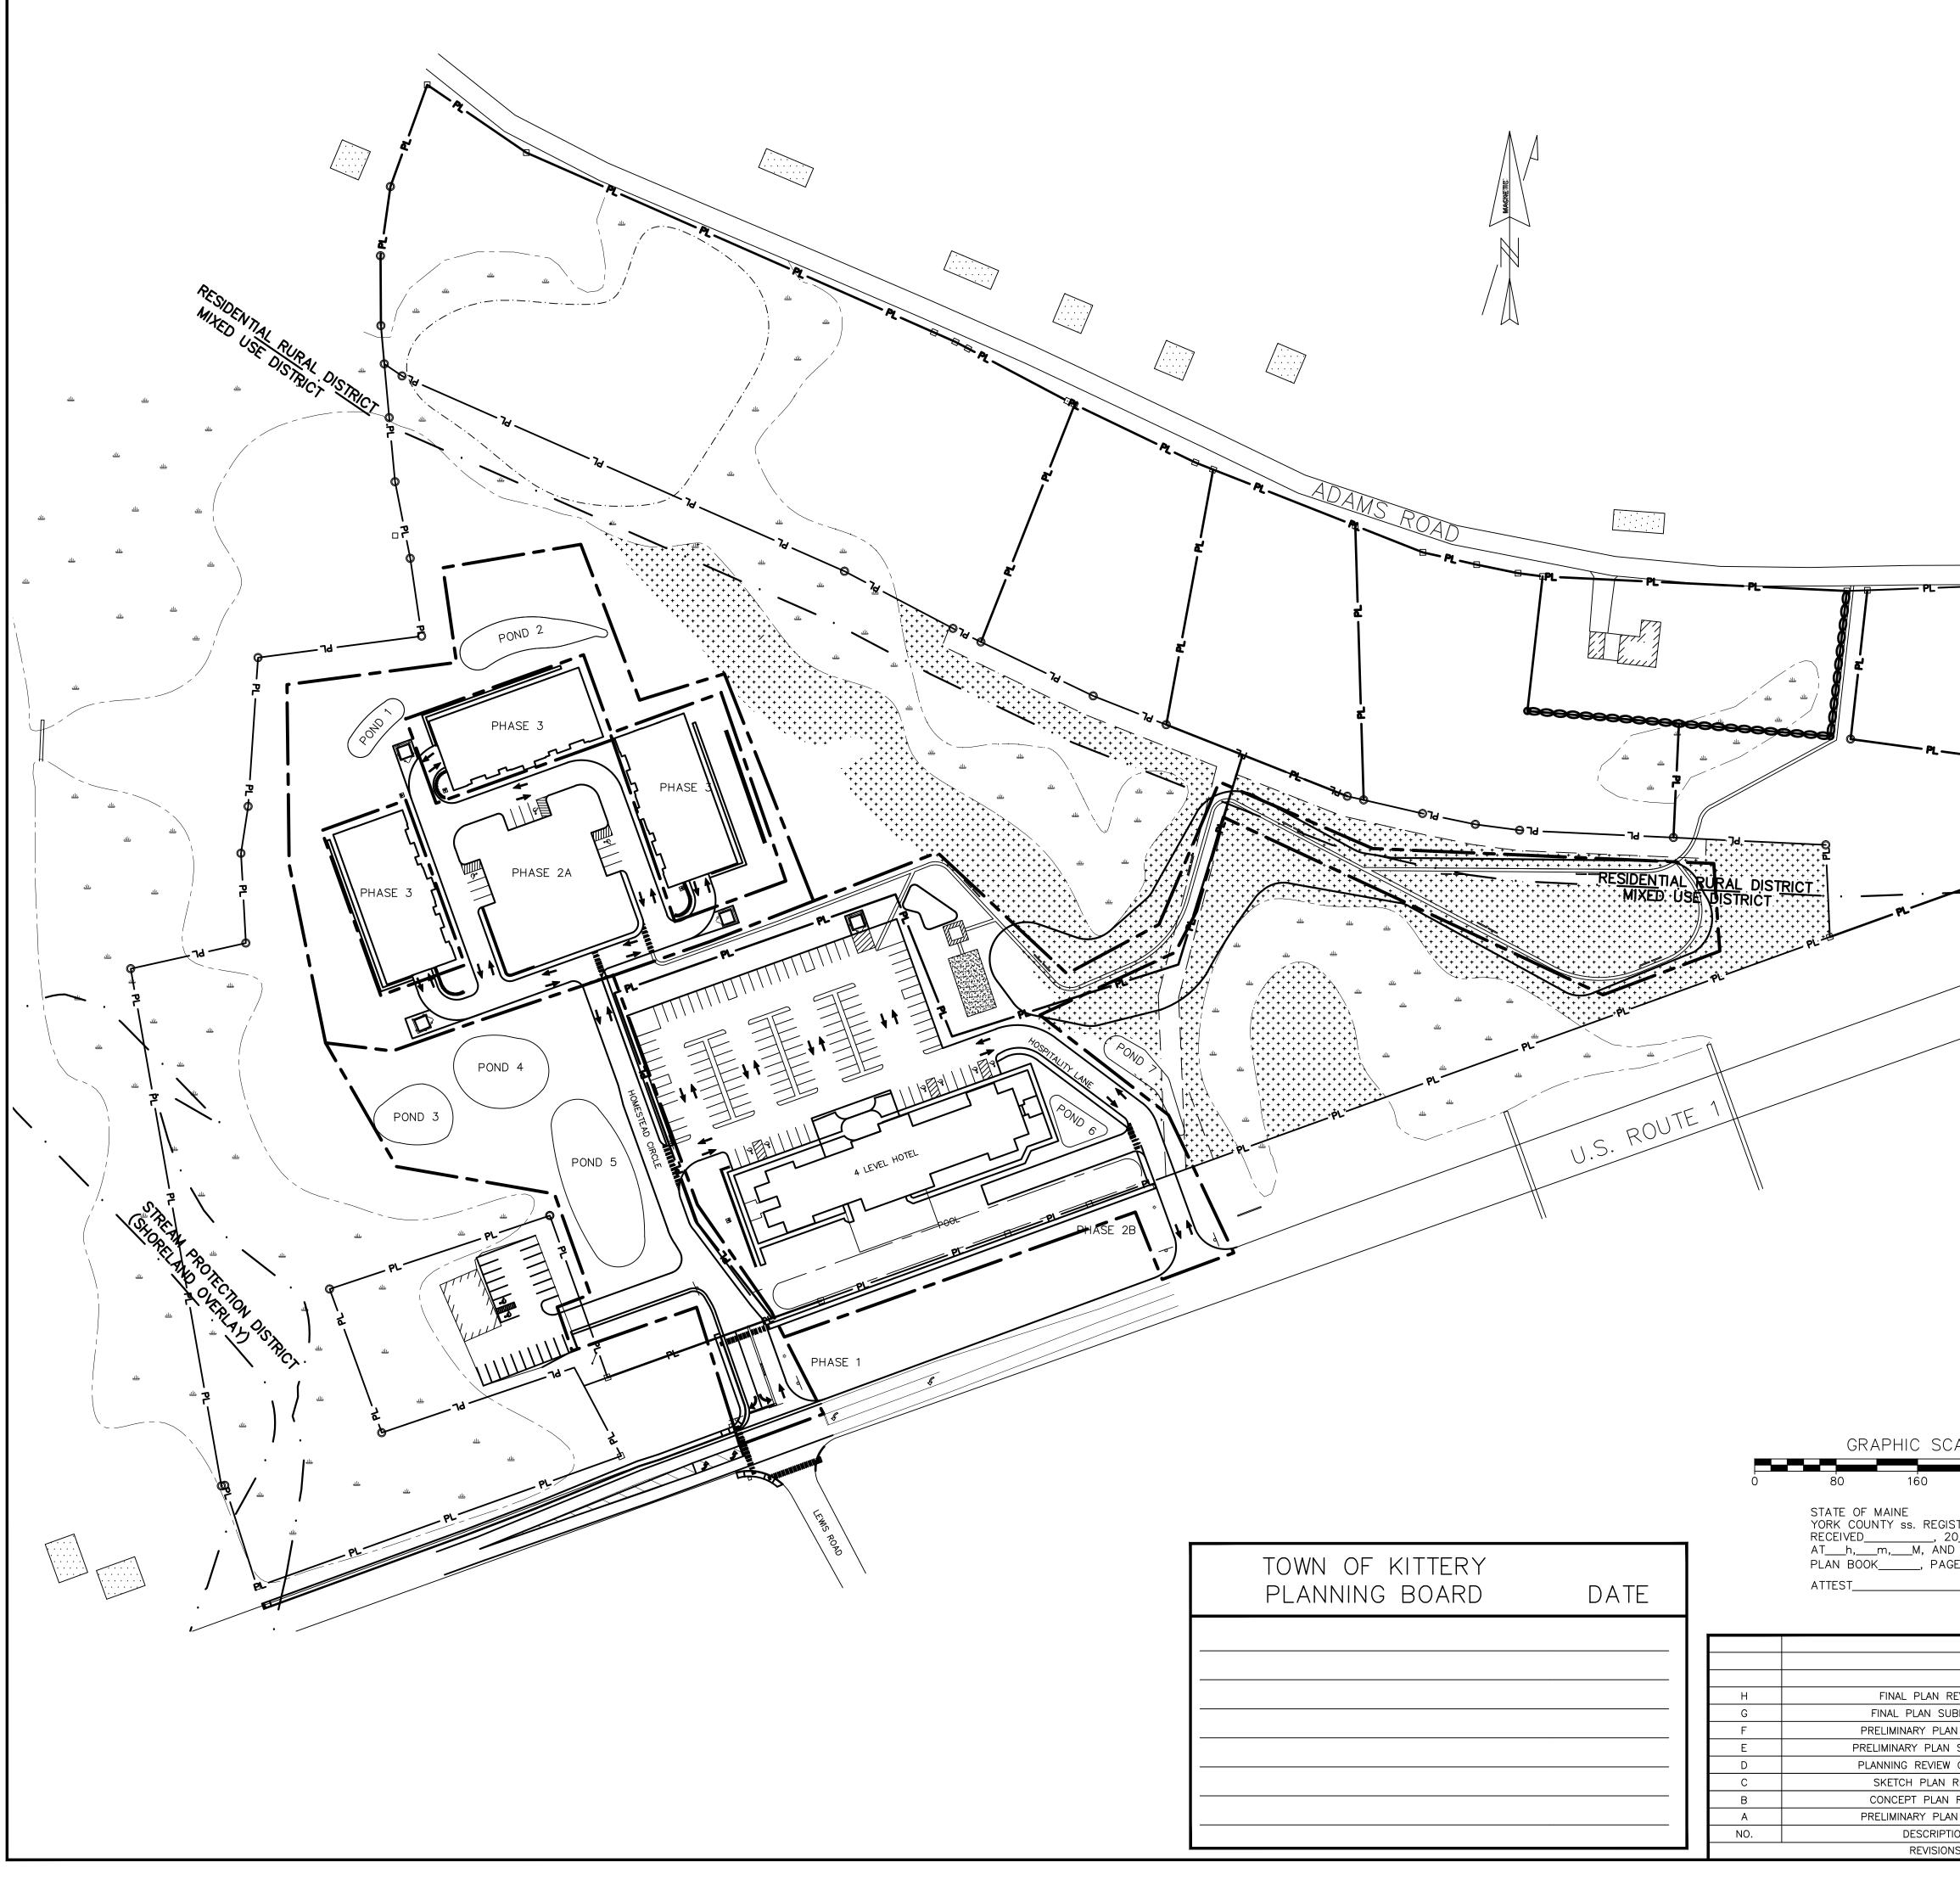

### <u>PHASING NOTES</u>

### CONSTRUCTION PHASING TO BE AS FOLLOWS:

NOTE: PHASING LINES ARE FOR PLANNING AND COORDINATION PURPOSES ONLY. THEY ARE NOT INTENDED TO DEPICT THE LIMITS OF PROPOSED CONSTRUCTION.


- 1) PHASE 1: PROPOSED ROAD, PROPOSED DRIVEWAY TO ABUTTER(OFFICE), ABUTTER PARKING LOT RE-STRIPING, WATER, SEWER, ELECTRICAL SITE CONNECTIONS, AND UNDERDRAINED SOIL FILTERS (POND 3, POND 4 AND POND 5) TO BE CONSTRUCTED.
- 2) PHASE 2A: APARTMENT BUILDING FOUNDATIONS AND UNDERDRAINED SOIL FILTERS (PONDS 1 AND 2) TO BE CONSTRUCTED. PHASE 2A AND 2B CAN OCCUR SIMULTANEOUSLY.
- 3) PHASE 2B: HOTEL, UNDERDRAINED SOIL FILTER (POND 7), LANDSCAPED BUFFER AREA AND PASSIVE RECREATION AREA TO BE CONSTRUCTED.
- 4) PHASE 3: INDIVIDUAL APARTMENT BUILDINGS TO BE CONSTRUCTED ON A SCHEDULE PROVIDED BY THE OWNER.


240 320 (FEET)	78	DRIVEWA	VEWAY SEMENT AY EASEMENT Ale: 1" = 40'	
GISTRY OF DEEDS 20 ND RECORDED IN				
AGE REGISTER	1.6		PHASING PLAN THE HOMESTEAD ROUTE 1 KITTER	
REVISION 03/27/2019	STATE OF MANARE	FOR: LA	NDMARK HILL, LLC 79 CONGRESS ST TSMOUTH, NH 0380	)1
SUBMISSION         01/24/2019           LAN REVISION         10/18/2018           AN SUBMISSION         9/20/2018           EW COMMENTS         8/9/2018	KENNED AL	CIN 1284 ST	R ENGINEERING /IL ◆ STRUCTURAL ◆ MAR ATE ROAD – ELIOT, MAINE D7)439-6023 FAX: (207	INE E 03903
N REVISION         7/19/2018           AN REVISION         6/20/2018           LAN REVISION         1/18/2018	The second secon	SCALE: 1" = 80' DATE:	APPROVED BY:	DRAWN BY: BRN REVISION : DATE
PTION DATE		02/08/2018 JOB NO: C052-18	FILE: THE HOMESTEAD BASE	H: 03/27/2019 SHEET 1.5


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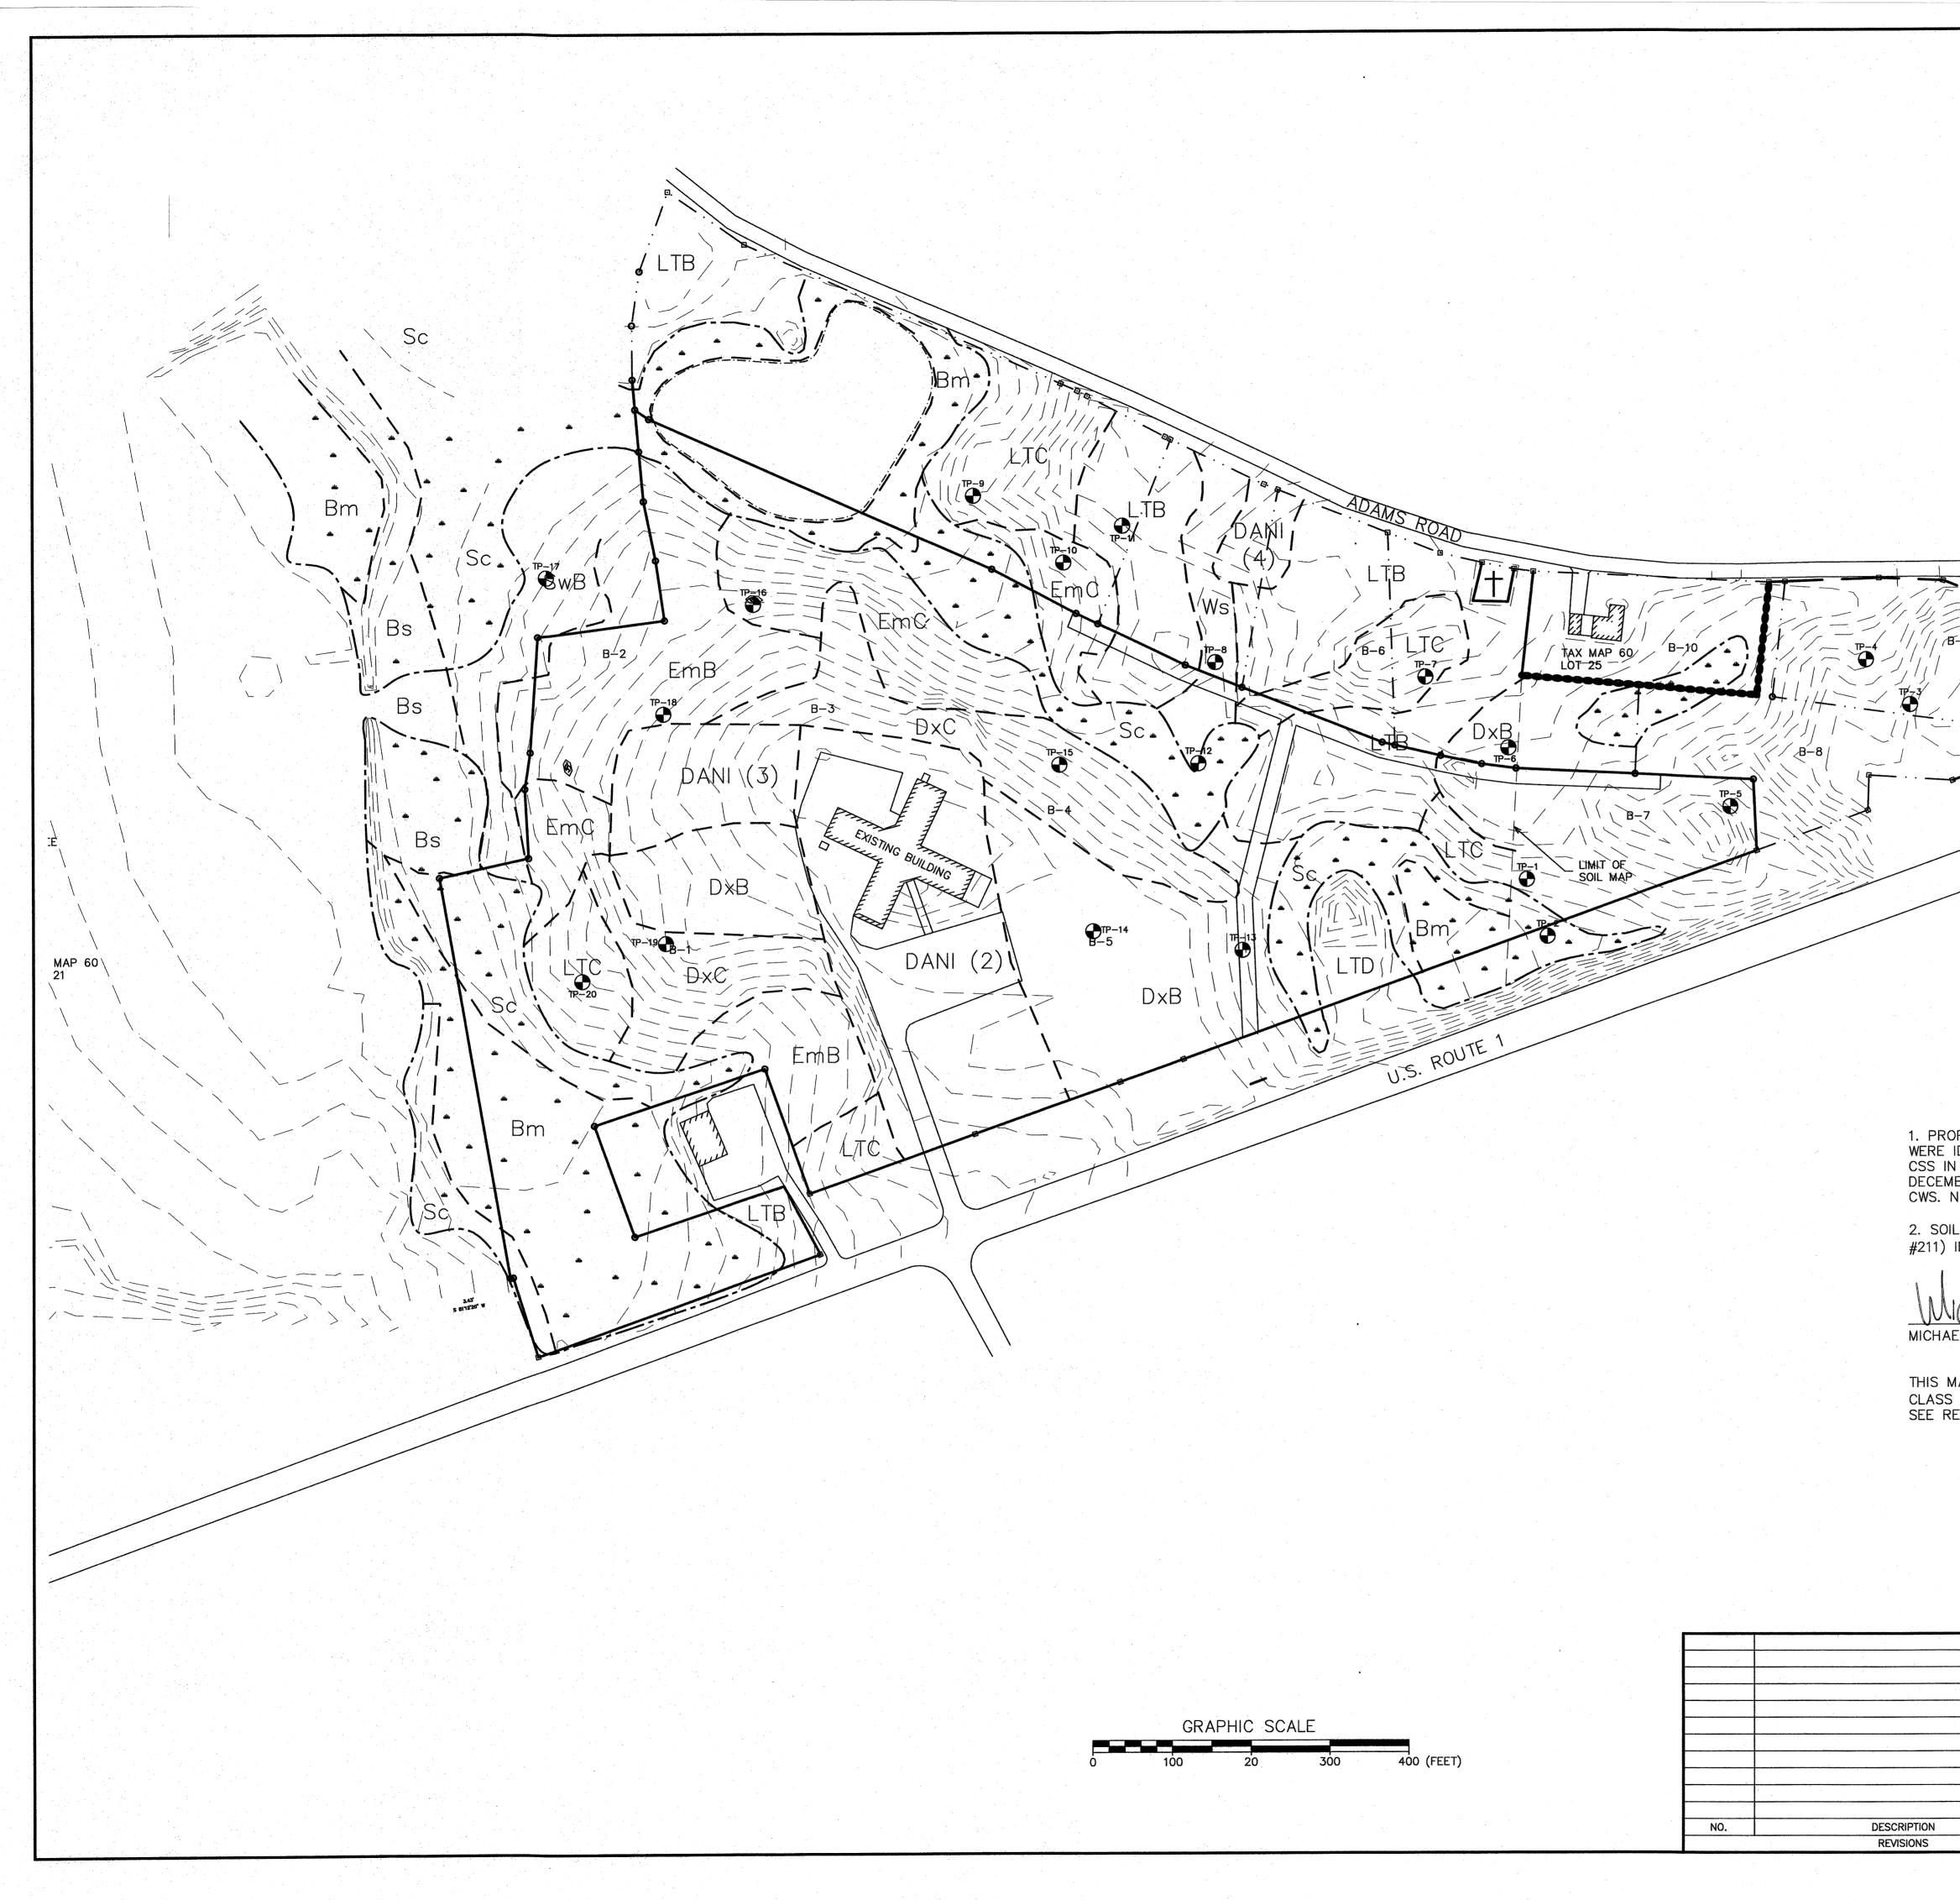
TAX MAP 60, LOT 24





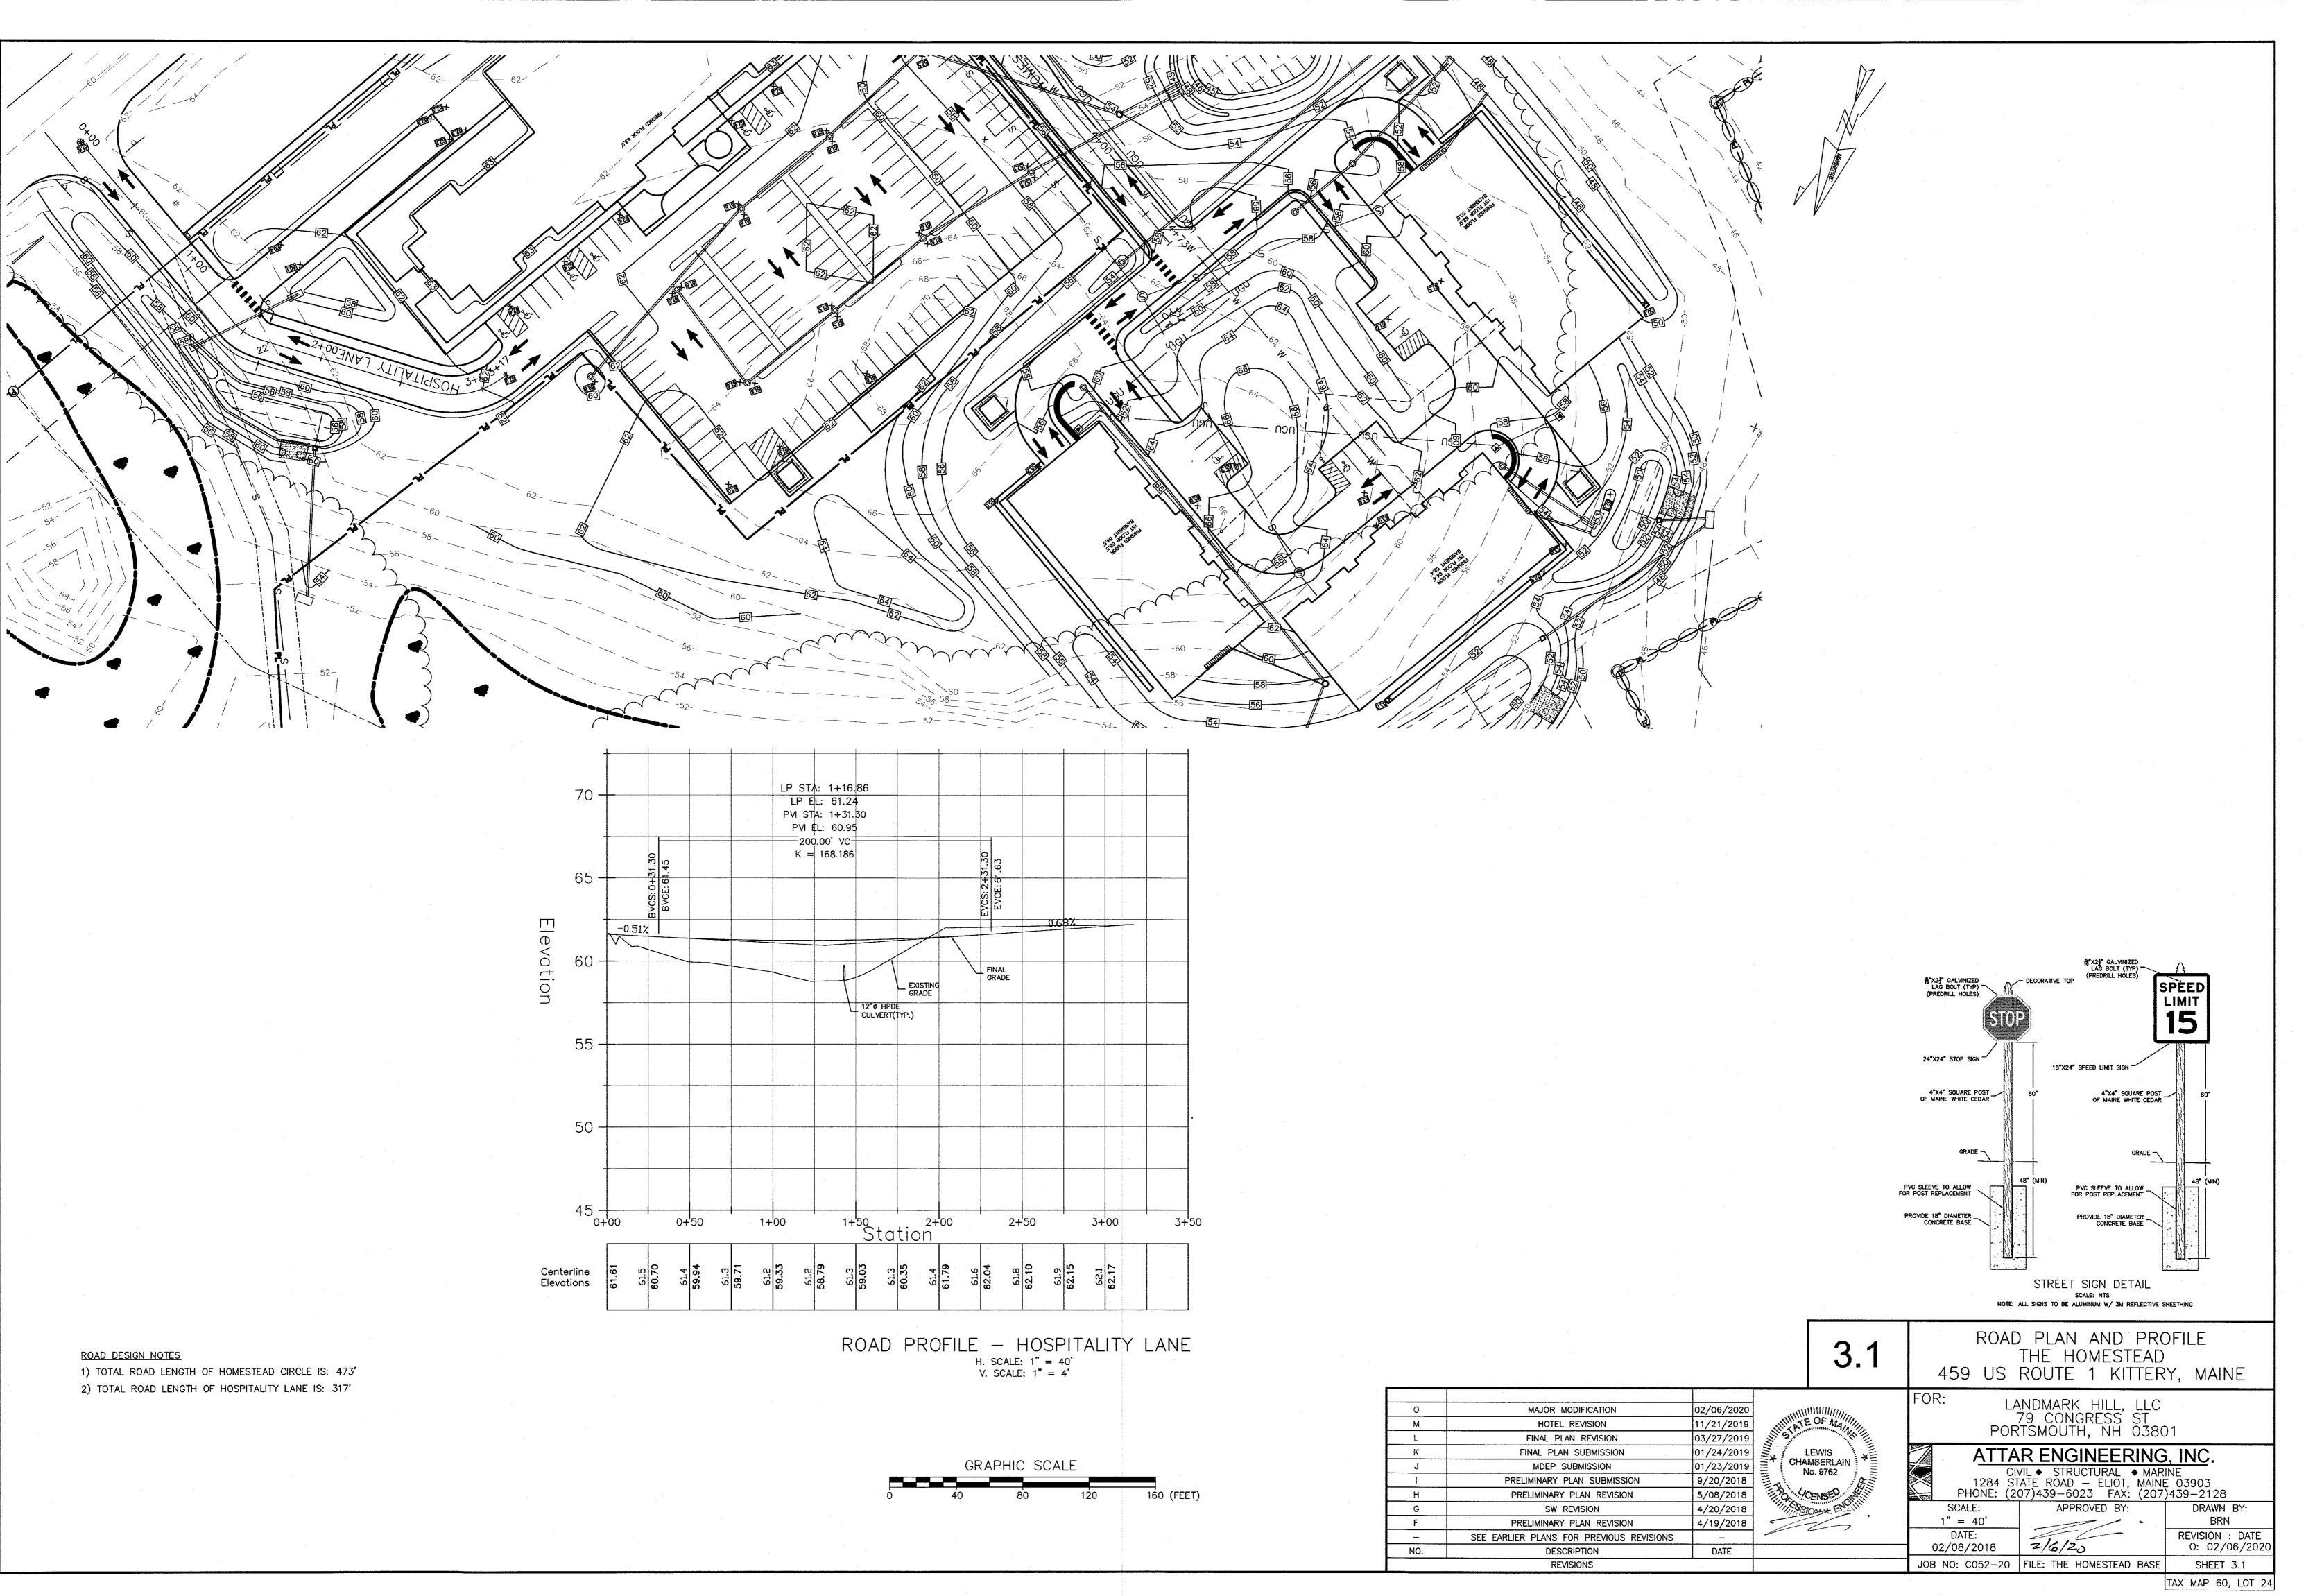
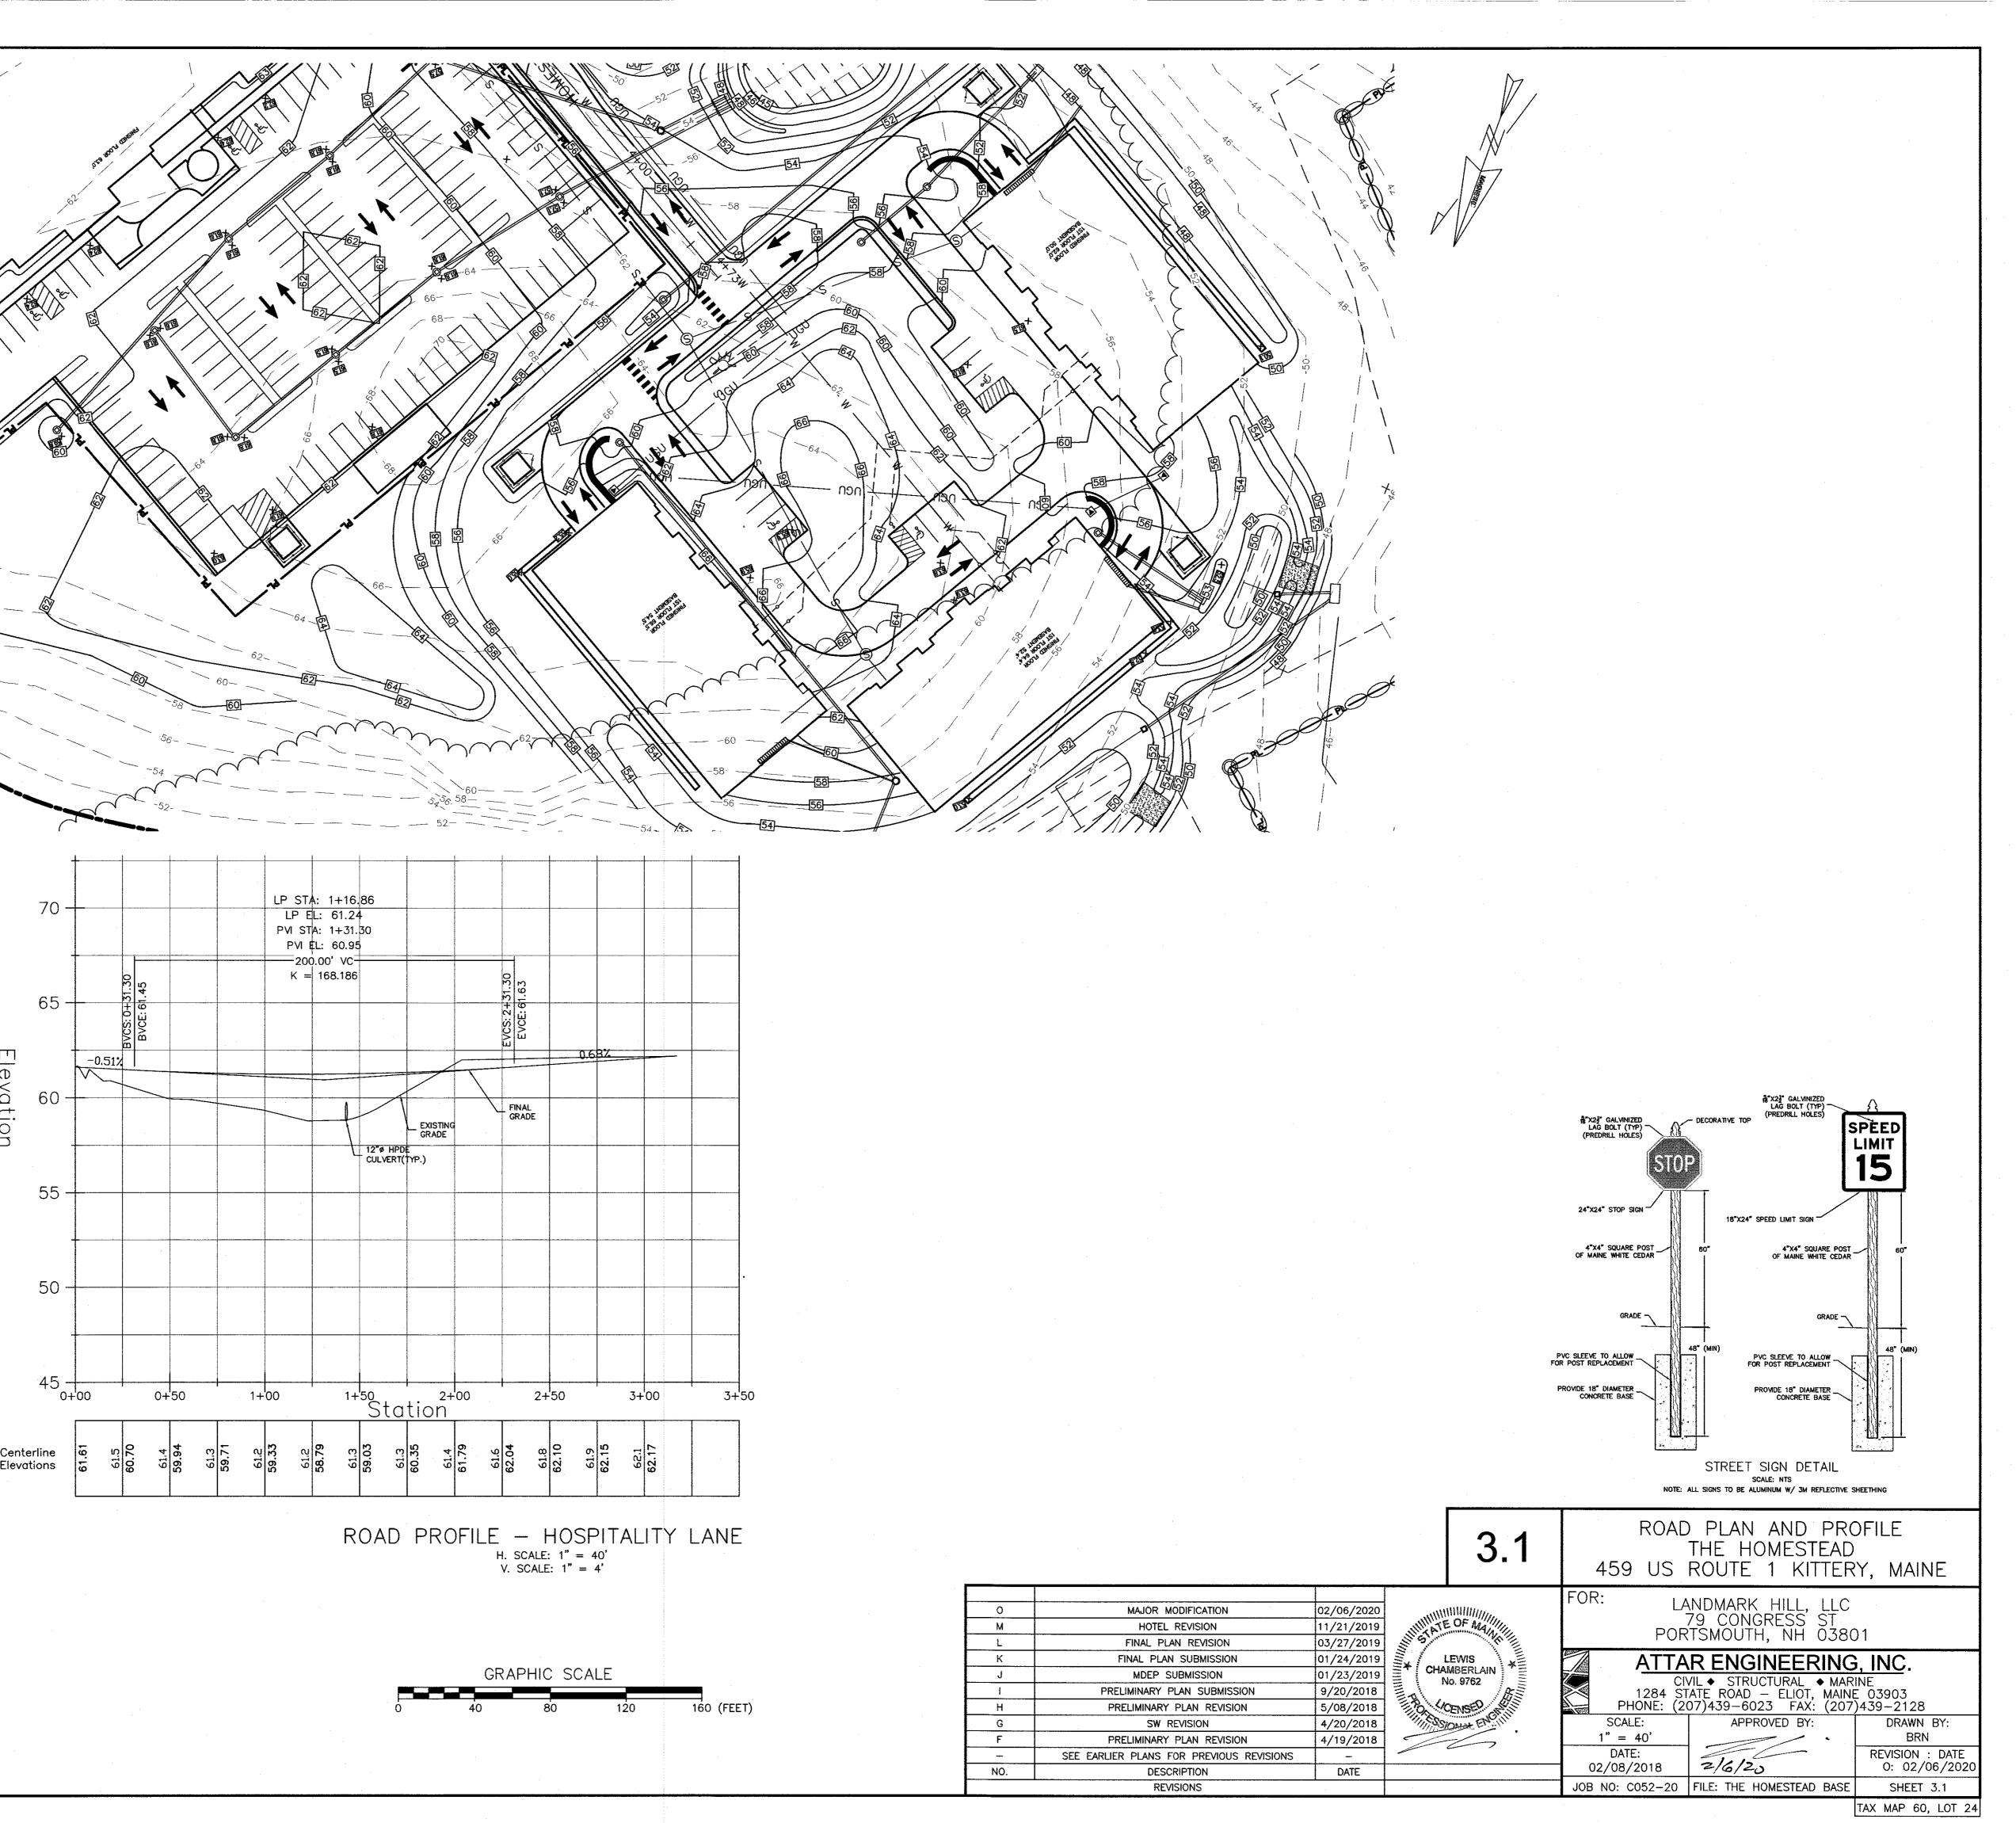
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	01/24/2019 01/23/2019	LEWIS CHAMBERLAIN No. 9762		ATTAR	ENGINEE	RING,	INC.	
l	9/20/2018 5/08/2018 4/19/2018	YCENSE ANTI	SCALE	:	<ul> <li>STRUCTURAL</li> <li>ROAD – ELIO</li> <li>439–6023 FA</li> <li>APPROVED B</li> </ul>	T, MAINE X: (207)4 Y:	03903 39-2128 DRAWN	BY:
VISIONS	4/16/2018		1" = 4 DATE: 02/08/2	+0'	16/20	-	BRN REVISION : M: 02/0	DATE
	DATE		JOB NO: CC		E: THE HOMESTE		SHEET AX MAP 60,	3.2

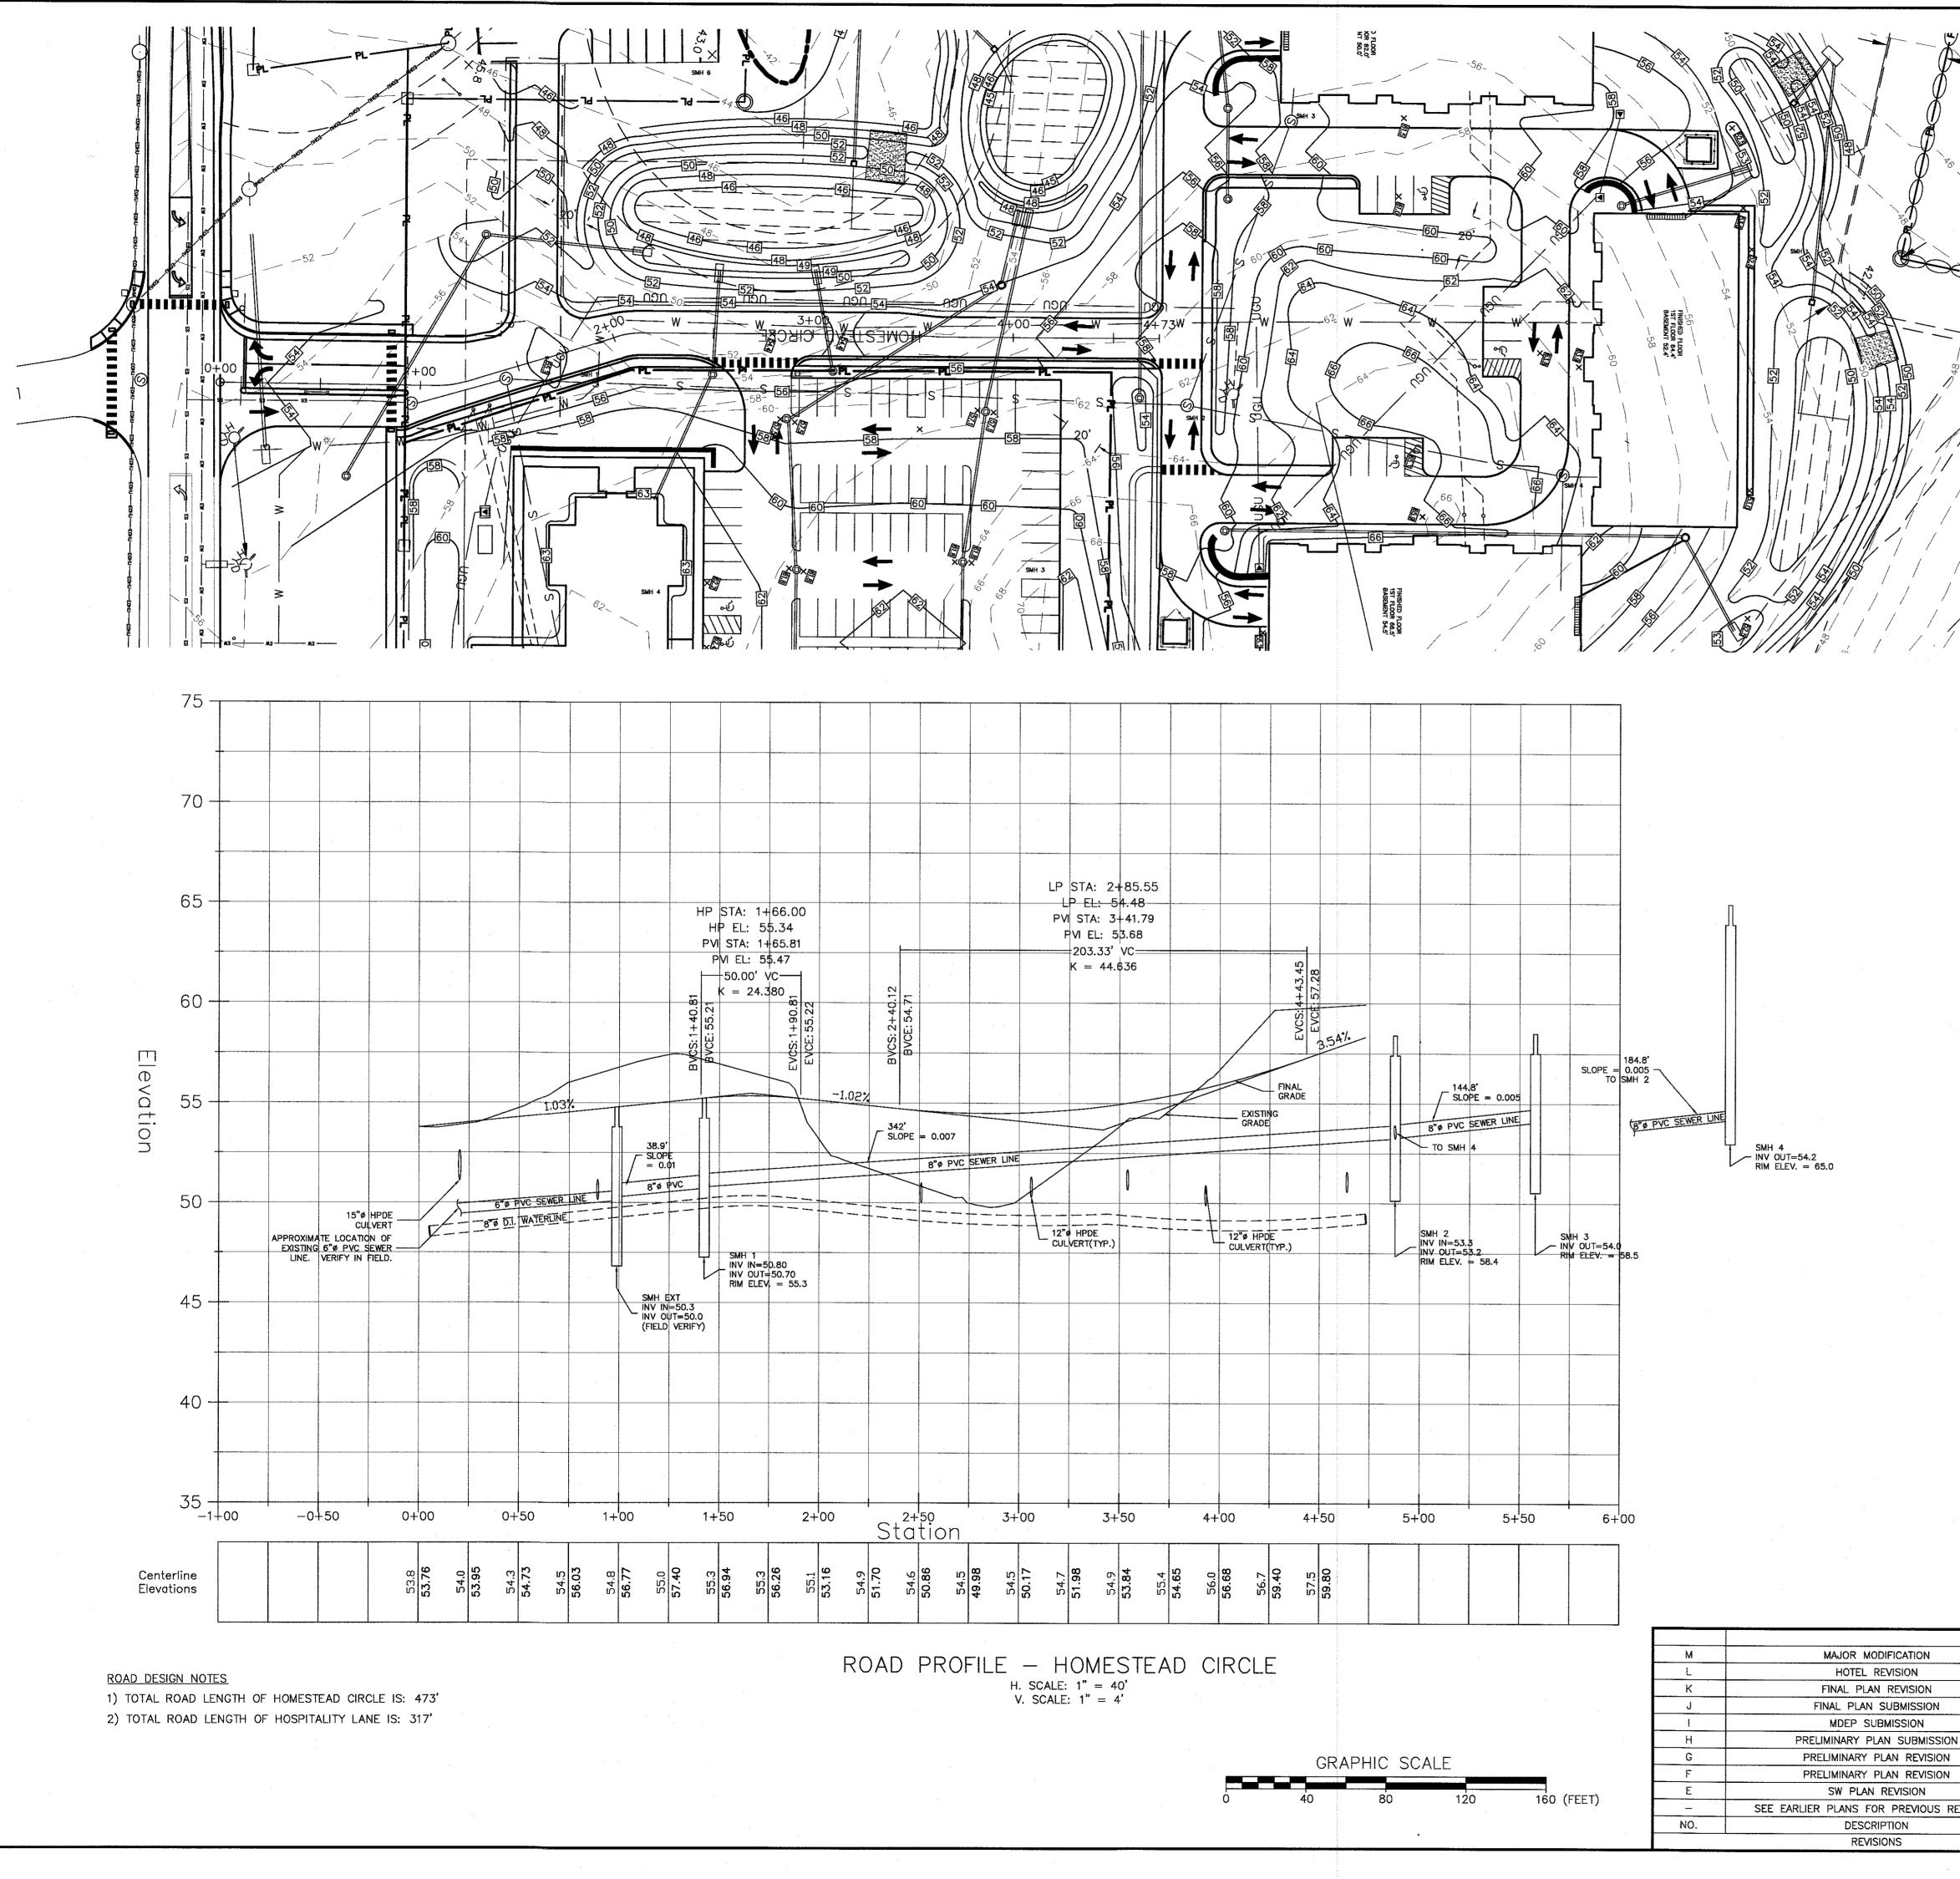

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$\Lambda$	
MAGNETIC	
	SYMBOL SOIL SERIES
	Bm BIDDEFORD MUCKY PEAT*
/ 八	BIDDEFORD—SCANTIC COMPLEX, FILLED AND DITCHED*
	DANI DEVELOPED AREA NOT INVESTIGATED
	Dx DIXFIELD FINE SANDY LOAM
	Em ELMWOOD VERY FINE SANDY LOAM
	LT LYMAN-TUNBRIDGE COMPLEX
	Sc SCANTIC SILT LOAM*
	SW SWANTON VERY FINE SANDY LOAM
	Ws WESTBURY FINE SANDY LOAM
	* WETLAND SOILS
	SOIL BOUNDARY
	SOIL/WETLANDBOUNDARY
	SOIL BORING 🗢
	SLOPE LEGEND
	(NONE) 0 – 3%
	B 3 – 8%
	C 8 - 15%
	D 15 - 25%

## GENERAL NOTES

1. PROPERTY LINES, WETLANDS, EXISTING CONDITIONS AND TOPOGRAPHY ARE FROM REFERENCE 1. WETLANDS WERE IDENTIFIED IN THE FIELD BY KENNETH A. WOOD, CWS IN DECEMBER, 1999 AND MICHAEL R. CUOMO, CWS, CSS IN MARCH, 2000. WETLANDS WERE LOCATED WITH SURVEY INSTRUMENT BY ATTAR ENGINEERING, INC. FROM DECEMBER, 1999 THROUGH APRIL, 2000. WETLAND DELINEATION WAS VERIFIED IN 2017 BY KENNETH A. WOOD, CWS. NO CHANGES WERE NOTED FROM THE PREVIOUS DELINEATION.

2. SOIL TYPES SHOWN ON THIS PLAN WERE IDENTIFIED BY MICHAEL CUOMO (MAINE CERTIFIED SOIL SCIENTIST #211) IN APRIL, 2000.

10JAN 2013 MICHAEL CUOMO, MAINE CERTIFIED SOIL SCIENTIST #211



							The second second
THIS MAP	COMPLIES	WITH THE	STANDAR	DS FOR			
CLASS "B"	HIGH INT	ENSITY SO	IL SURVEY.				
SEE REPOR	T DATED	14 APRIL	2000 FOR	DESCRIPTION	METHODS	OF	SOIL.

		4.1		NTENSITY SOIL S THE HOMESTEAD ROUTE 1 KITTER	
			FOR: LA POR	NDMARK HILL, LLC 79 CONGRESS ST TSMOUTH, NH 0380	)1
	· · · · · · · · · · · · · · · · · · ·			RENGINEERING VIL	INE
	DATE		SCALE: 1" = 100' DATE: 12/20/2017	APPROVED BY:	DRAWN BY: BRN REVISION : DATE -:-
			JOB NO: C052-17	CAD FILE: MBRIGHAM LBASE	SHEET 4.1
·	 •	 			TAX MAP 24 LOT 60


TAX MAP 24, LOT 60

## EROSION & SEDIMENTATION CONTROL NOTES

- SILTATION FENCE OR HAY BALE BARRIERS WILL BE INSTALLED DOWNSLOPE OF ALL STRIPPING OR CONSTRUCTION OPERATIONS. A DOUBLE SILT FENCE BARRIER SHALL BE INSTALLED DOWNSLOPE OF ANY SOIL MATERIAL STOCKPILES. SILT FENCES SHALL BE INSPECTED AFTER EACH RAIN EVENT AND DAILY DURING PROLONGED RAIN. SILT AND SOIL PARTICLES ACCUMULATING BEHIND THE FENCE SHALL BE REMOVED AFTER EACH SIGNIFICANT RAIN EVENT AND IN NO INSTANCE SHOULD ACCUMULATION EXCEED 1/2 THE HEIGHT OF THE FENCE. TORN OR DAMAGED AREAS SHALL BE REPAIRED.
- TEMPORARY AND PERMANENT VEGETATION AND MULCHING IS AN INTEGRAL COMPONENT OF THE EROSION AND SEDIMENTATION CONTROL PLAN. ALL AREAS SHALL BE INSPECTED AND MAINTAINED UNTIL THE DESIRED VEGETATIVE COVER IS ESTABLISHED. THESE CONTROL MEASURES ARE ESSENTIAL TO EROSION PREVENTION AND ALSO REDUCE COSTLY REWORK OF GRADED AND SHAPED AREAS.
- SEEDING, FERTILIZER AND LIME RATES AND TIME OF APPLICATION WILL BE DEPENDENT ON SOIL REQUIREMENTS. TEMPORARY VEGETATION SHALL BE MAINTAINED IN THESE AREAS UNTIL PERMANENT SEEDING IS APPLIED. ADDITIONALLY, EROSION AND SEDIMENTATION MEASURES SHALL BE MAINTAINED UNTIL PERMANENT VEGETATION IS ESTABLISHED.
- ALL LAWN AREA, OUTER POND SIDE SLOPES AND SWALES SHALL BE PERMANENTLY SEEDED WITH THE FOLLOWING MIXTURE: 20 LB/ACRE CREEPING RED FESCUE, 2 LB/ACRE REDTOP AND 20 LB/ACRE TALL FESCUE FOR A TOTAL OF 42 LB/ACRE FERTILIZER AND LIME RATES SHALL BE DEPENDENT ON SOIL TESTING. IN THE ABSENCE OF SOIL TESTS, FERTILIZE WITH 10-20-20 (N-P205-K201) AT 800 LB/ACRE AND LIME AT 3 TONS/ACRE. MULCH WITH HAY AT 70-90 LB/1000 S.F. 4" OF LOAM SHALL BE APPLIED PRIOR TO SEEDING.
- POND BOTTOMS AND INNER POND SIDESLOPES SHALL BE PERMANENTLY SEEDED WITH THE FOLLOWING MIXTURE: 20 LB/ACRE CREEPING RED FESCUE, 8 LB/ACRE BIRDSFOOT TREFOIL AND 20 LB/ACRE TALL FESCUE FOR A TOTAL OF 48 LB/ACRE. SEE THE ABOVE NOTE FOR FERTILIZER, LIME AND MULCHING RATES.
- TEMPORARY VEGETATION OF ALL DISTURBED AREAS. MATERIAL STOCKPILES AND OTHER SUCH AREAS SHALL BE ESTABLISHED BY SEEDING WITH EITHER WINTER RYE AT A RATE OF 112 LB/ACRE OR ANNUAL RYEGRASS AT A RATE OF 40 LB/ACRE. WINTER RYE SHALL BE USED FOR FALL SEEDING AND ANNUAL RYEGRASS FOR SHORT DURATION SEEDING. SEEDING SHALL BE ACCOMPLISHED BEFORE OCTOBER 1.
- TEMPORARY SEEDING OF DISTURBED AREAS SHALL BE ACCOMPLISHED BEFORE OCTOBER 1. PERMANENT SEEDING SHALL BE ACCOMPLISHED BEFORE SEPTEMBER 15.
- 8. ALL SEEDED AREAS SHALL BE MULCHED WITH HAY AT A RATE OF 2 BALES (70-90 LB) PER 1000 S.F. OF SEEDED AREA.
- 9. SLOPES 2:1 OR STEEPER SHALL BE TREATED WITH POLYJUTE OPEN WEAVE GEOTEXTILE (OR EQUIVALENT) AFTER SEEDING. JUTE MATS SHALL BE ANCHORED PER MANUFACTURER'S SPECIFICATIONS.
- 10. EXCESSIVE DUST CAUSED BY CONSTRUCTION OPERATIONS SHALL BE CONTROLLED BY APPLICATION OF WATER OR CALCIUM CHLORIDE.
- 11. THE CONTRACTOR MAY OPT TO USE EROSION CONTROL MIX BERM AS A SEDIMENT BARRIER IN LIEU OF SILTATION FENCE OR HAY BALE BARRIERS WITH APPROVAL FROM THE INSPECTING ENGINEER.
- 12. MINIMIZE DISTURBED AREAS AND PROTECT NATURAL DOWNGRADIENT BUFFER AREAS TO THE EXTENT PRACTICABLE. CONTROL STORMWATER VOLUME AND VELOCITY WITHIN THE SITE TO MINIMIZE SOIL EROSION. MINIMIZE THE DISTURBANCE OF STEEP SLOPES. CONTROL STORMWATER DISCHARGES, INCLUDING BOTH PEAK FLOW RATES AND VOLUME, TO MINIMIZE EROSION AT OUTLETS. THE DISCHARGE MAY NOT RESULT IN EROSION OF ANY OPEN DRAINAGE CHANNELS, SWALES, STREAM CHANNELS OR STREAM BANKS, UPLAND. OR COASTAL OR FRESHWATER WETLANDS OFF THE PROJECT SITE.

## EROSION & SED. CONTROL NOTES (CONT.)

- 13. WHENEVER PRACTICABLE, NO DISTURBANCE ACTIVITIES SHOULD TAKE PLACE WITHIN 50 FEET OF ANY PROTECTED NATURAL RESOURCE. IF DISTURBANCE ACTIVITIES TAKE PLACE BETWEEN 30 FEET AND 50 FEET OF ANY PROTECTED NATURAL RESOURCE, AND STORMWATER DISCHARGES THROUGH THE DISTURBED AREAS TOWARD THE PROTECTED NATURAL RESOURCE, PERIMETER EROSION CONTROLS MUST BE DOUBLED. IF DISTURBANCE ACTIVITIES TAKE PLACE LESS THAN 30 FEET FROM ANY PROTECTED NATURAL RESOURCE, AND STORMWATER DISCHARGES THROUGH THE DISTURBED AREAS TOWARD THE PROTECTED NATURAL RESOURCE, PERIMETER EROSION CONTROLS MUST BE DOUBLED AND DISTURBED AREAS MUST BE TEMPORARILY OR PERMANENTLY STABILIZED WITHIN 7 DAYS.
- 14. PRIOR TO CONSTRUCTION, PROPERLY INSTALL SEDIMENT BARRIERS AT THE DOWNGRADIENT EDGE OF ANY AREA TO BE DISTURBED AND ADJACENT TO ANY DRAINAGE CHANNELS WITHIN THE DISTURBED AREA. SEDIMENT BARRIERS SHOULD BE INSTALLED DOWNGRADIENT OF SOIL OR SEDIMENT STOCKPILES AND STORMWATER PREVENTED FROM RUNNING ONTO THE STOCKPILE. MAINTAIN THE SEDIMENT BARRIERS BY REMOVING ACCUMULATED SEDIMENT, OR REMOVING AND REPLACING THE BARRIER, UNTIL THE DISTURBED AREA IS PERMANENTLY STABILIZED. WHERE A DISCHARGE TO A STORM DRAIN INLET OCCURS, IF THE STORM DRAIN CARRIES WATER DIRECTLY TO A SURFACE WATER AND YOU HAVE AUTHORITY TO ACCESS THE STORM DRAIN INLET. YOU MUST INSTALL AND MAINTAIN PROTECTION MEASURES THAT REMOVE SEDIMENT FROM THE DISCHARGE.
- 15. PRIOR TO CONSTRUCTION, PROPERLY INSTALL A STABILIZED CONSTRUCTION ENTRANCE (SCE) AT ALL POINTS OF EGRESS FROM THE SITE. THE SCE IS A STABILIZED PAD OF AGGREGATE, UNDERLAIN BY A GEOTEXTILE FILTER FABRIC, USED TO PREVENT TRAFFIC FROM TRACKING MATERIAL AWAY FROM THE SITE ONTO PUBLIC ROW'S. MAINTAIN THE SCE UNTIL ALL DISTURBED AREAS ARE STABILIZED.
- 16. WITHIN 7 DAYS OF THE CESSATION OF CONSTRUCTION ACTIVITIES IN AN AREA THAT WILL NOT BE WORKED FOR MORE THAN 7 DAYS. STABILIZE ANY EXPOSED SOIL WITH MULCH. OR OTHER NON-ERODIBLE COVER. STABILIZE AREAS WITHIN 75 FEET OF A WETLAND OR WATERBODY WITHIN 48 HOURS OF THE INITIAL DISTURBANCE OF THE SOIL OR PRIOR TO ANY STORM EVENT, WHICHEVER COMES FIRST.
- 17. REMOVE ANY TEMPORARY CONTROL MEASURES. SUCH AS SILTATION FENCE, WITHIN 30 DAYS AFTER PERMANENT STABILIZATION IS ATTAINED. REMOVE ANY ACCUMULATED SEDIMENTS AND STABILIZE.
- 18. IF THE AREA WILL NOT BE WORKED FOR MORE THAN ONE YEAR OR HAS BEEN BROUGHT TO FINAL GRADE. THEN PERMANENTLY STABILIZE THE AREA WITHIN 7 DAYS BY PLANTING VEGETATION, SEEDING, SOD, OR THROUGH THE USE OF PERMANENT MULCH. OR RIPRAP. OR ROAD SUB-BASE. IF USING VEGETATION FOR STABILIZATION. SELECT THE PROPER VEGETATION FOR THE LIGHT, MOISTURE, AND SOIL CONDITIONS: AMEND AREAS OF DISTURBED SUBSOILS WITH TOPSOIL, COMPOST, OR FERTILIZERS; PROTECT SEEDED AREAS WITH MULCH OR, IF NECESSARY, EROSION CONTROL BLANKETS; AND SCHEDULE SODDING, PLANTING, AND SEEDING SO TO AVOID DIE-OFF FROM SUMMER DROUGHT AND FALL FROSTS. NEWLY SEEDED OR SODDED AREAS MUST BE PROTECTED FROM VEHICLE TRAFFIC. EXCESSIVE PEDESTRIAN TRAFFIC. AND CONCENTRATED RUNOFF UNTIL THE VEGETATION IS WELL-ESTABLISHED WITH 90% COVER BY HEALTHY VEGETATION. IF NECESSARY, AREAS MUST BE REWORKED AND RESTABILIZED IF GERMINATION IS SPARSE. PLANT COVERAGE IS SPOTTY. OR TOPSOIL EROSION IS EVIDENT. ONE OR MORE OF THE FOLLOWING MAY APPLY TO A PARTICULAR SITE.
- 19. FOR SEEDED AREAS, PERMANENT STABILIZATION MEANS A 90% COVER OF THE DISTURBED AREA WITH MATURE, HEALTHY PLANTS WITH NO EVIDENCE OF WASHING OR RILLING OF THE TOPSOIL.
- 20. FOR SODDED AREAS, PERMANENT STABILIZATION MEANS THE COMPLETE BINDING OF THE SOD ROOTS INTO THE UNDERLYING SOIL WITH NO SLUMPING OF THE SOD OR DIE-OFF.
- 21. FOR MULCHED AREAS, PERMANENT MULCHING MEANS TOTAL COVERAGE OF THE EXPOSED AREA WITH AN APPROVED MULCH MATERIAL. EROSION CONTROL MIX MAY BE USED AS MULCH FOR PERMANENT STABILIZATION ACCORDING TO THE APPROVED APPLICATION RATES AND LIMITATIONS.
- 22. THE CONTRACTOR SHALL BE RESPONSIBLE FOR ADEQUATE HOUSEKEEPING PRACTICES DURING THE CONSTRUCTION OF THE PROJECT, THESE STANDARDS CAN BE FOUND IN THE FOLLOWING DOCUMENT: MDEP CHAPTER 500 (STORMWATER MANAGEMENT), APPENDIX C. HOUSEKEEPING. HOUSEKEEPING PRACTICES INCLUDE, BUT ARE NOT LIMITED TO, SPILL PREVENTION, GROUNDWATER PROTECTION, FUGITIVE SEDIMENT AND DUST, DEBRIS AND OTHER MATERIALS, EXCAVATION DEWATERING, AUTHORIZED NON-STORMWATER DISCHARGES AND UNAUTHORIZED NON-STORMWATER DISCHARGES.

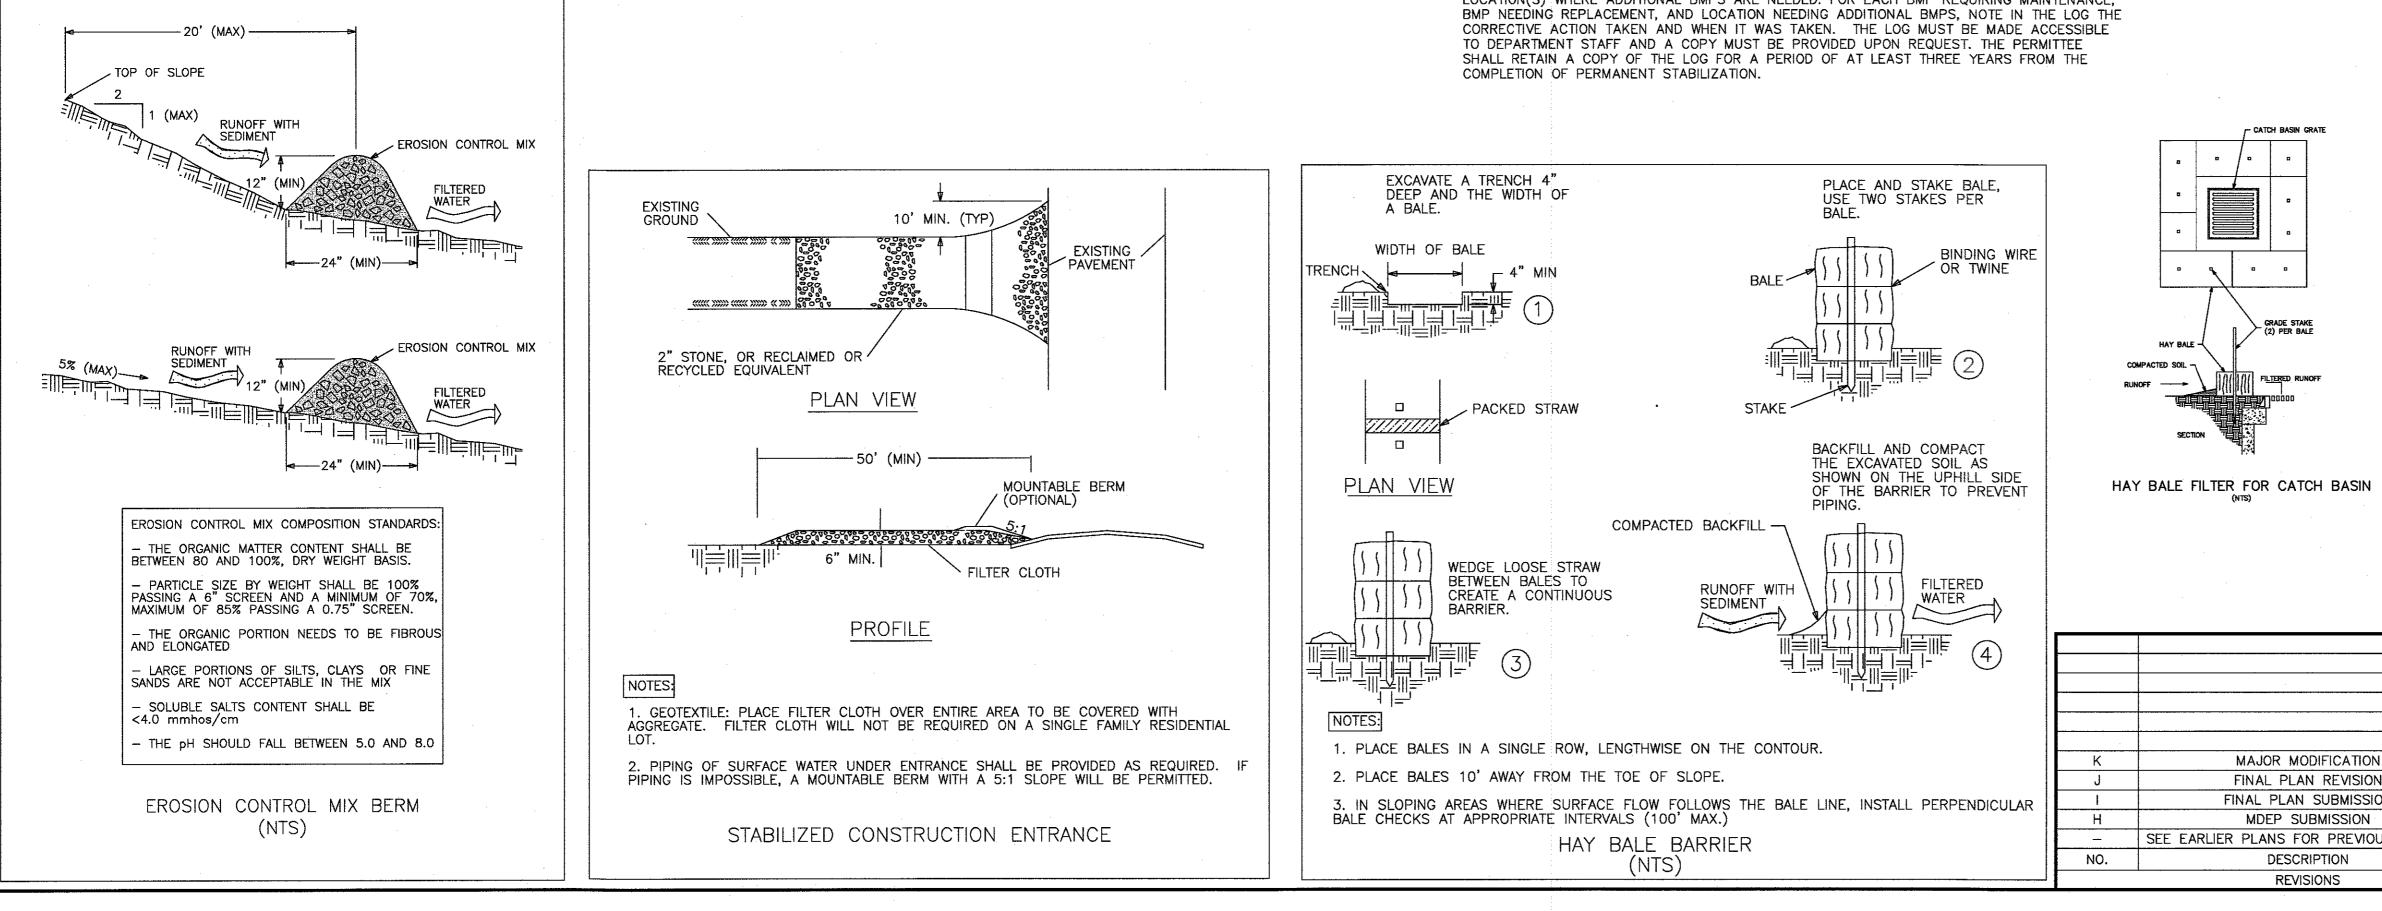

## WINTER CONSTRUCTION NOTES

NOVEMBER 1 - APRIL 15 1. AN AREA SHALL BE CONSIDERED STABILIZED WHEN EXPOSED SURFACES HAVE BEEN EITHER MULCHED WITH HAY AT A RATE OF 100 LB/1000 S.F. OR DORMANT SEEDED. MULCHED AND ADEQUATELY ANCHORED BY AN APPROVED ANCHORING TECHNIQUE. IN ALL CASES, MULCH SHALL BE APPLIED SO THAT THE SOIL SURFACE IS NOT VISIBLE THROUGH THE MULCH.

2. FROM OCTOBER 15 TO APRIL 1, LOAM AND SEED WILL NOT BE REQUIRED. DURING PERIODS OF TEMPERATURES ABOVE FREEZING, DISTURBED AREAS SHALL BE FINE GRADED AND PROTECTED WITH MULCH OR TEMPORARILY SEEDED AND MULCHED UNTIL PERMANENT SEEDING CAN BE APPLIED. AFTER NOVEMBER 1, DISTURBED AREAS MAY BE LOAMED, FINE GRADED AND DORMANT SEEDED AT A RATE 200-300% HIGHER THAN THE SPECIFIED PERMANENT SEEDING RATE. IF CONSTRUCTION CONTINUES DURING FREEZING WEATHER DISTURBED AREAS SHALL BE GRADED BEFORE FREEZING AND TEMPORARILY STABILIZED WITH MULCH. DISTURBED AREAS SHALL NOT BE LEFT OVER THE WINTER OR FOR ANY OTHER EXTENDED PERIOD OF TIME UNLESS STABILIZED WITH MULCH.

3. FROM NOVEMBER 1 TO APRIL 15 ALL MULCH SHALL BE ANCHORED BY EITHER PEG LINE, MULCH NETTING, ASPHALT EMULSION CHEMICAL, TRACK OR WOOD CELLULOSE FIBER. MULCH NETTING SHALL BE USED TO ANCHOR MULCH IN ALL DRAINAGE WAYS WITH SLOPES GREATER THAN 3%, SLOPES EXPOSED TO DIRECT WINDS AND FOR SLOPES GREATER THAN 8%. MULCH NETTING SHALL BE USED TO ANCHOR MULCH IN ALL AREAS WITH SLOPES GREATER THAN 15%. AFTER OCTOBER 1, THE SAME APPLIES TO ALL SLOPES GREATER THAN 8%.

4. SNOW SHALL BE REMOVED FROM AREAS OF SEEDING AND MULCHING PRIOR TO PLACEMENT.

5. FOR WINTER STABILIZATION, HAY MULCH SHALL BE APPLIED AT TWICE THE STANDARD TEMPORARY STABILIZATION RATE. AT THE END OF EACH CONSTRUCTION DAY, AREAS THAT HAVE BEEN BROUGHT TO FINAL GRADE SHALL BE STABILIZED. MULCH SHALL NOT BE SPREAD ON TOP OF SNOW.

6. ALL AREAS WITHIN 75 FEET OF A PROTECTED NATURAL RESOURCE SHALL BE PROTECTED WITH A DOUBLE ROW OF SEDIMENT BARRIERS.

7. ALL VEGETATED DITCH LINES THAT HAVE NOT BEEN STABILIZED BY NOVEMBER 1, OR WILL BE WORKED DURING THE WINTER CONSTRUCTION PERIOD. SHALL BE STABILIZED WITH AN APPROPRIATE STONE LINING BACKED BY AN APPROPRIATE GRAVEL BED OR GEOTEXTILE UNLESS SPECIFICALLY RELEASED FROM THIS STANDARD BY THE MDFP.


8. MULCH NETTING SHALL BE USED TO ANCHOR MULCH ON ALL SLOPES GREATER THAN 8% UNLESS EROSION CONTROL BLANKETS OR EROSION CONTROL MIX IS BEING USED ON SUCH SLOPES.


# E&S INSPECTION/MAINTENANCE DURING CONSTRUCTION


A. INSPECTION AND CORRECTIVE ACTION, INSPECT DISTURBED AND IMPERVIOUS AREAS, EROSION CONTROL MEASURES, MATERIALS STORAGE AREAS THAT ARE EXPOSED TO PRECIPITATION, AND LOCATIONS WHERE VEHICLES ENTER OR EXIT THE SITE. INSPECT THESE AREAS AT LEAST ONCE A WEEK AS WELL AS BEFORE AND WITHIN 24 HOURS AFTER A STORM EVENT (RAINFALL), AND PRIOR TO COMPLETING PERMANENT STABILIZATION MEASURES. A PERSON WITH KNOWLEDGE OF EROSION AND STORMWATER CONTROL, INCLUDING THE STANDARDS AND CONDITIONS IN THE PERMIT, SHALL CONDUCT THE INSPECTIONS.


- MAINTENANCE. IF BEST MANAGEMENT PRACTICES (BMPS) NEED TO BE REPAIRED, THE REPAIR WORK SHOULD BE INITIATED UPON DISCOVERY OF THE PROBLEM BUT NO LATER THAN THE END OF THE NEXT WORKDAY, IF ADDITIONAL BMPS OR SIGNIFICANT REPAIR OF BMPS ARE NECESSARY, IMPLEMENTATION MUST BE COMPLETED WITHIN 7 CALENDAR DAYS AND PRIOR TO ANY STORM EVENT (RAINFALL). ALL MEASURES MUST BE MAINTAINED IN EFFECTIVE OPERATING CONDITION UNTIL AREAS ARE PERMANENTLY STABILIZED.
- C. <u>DOCUMENTATION</u>, KEEP A LOG (REPORT) SUMMARIZING THE INSPECTIONS AND ANY CORRECTIVE ACTION TAKEN. THE LOG MUST INCLUDE THE NAME(S) AND QUALIFICATIONS OF THE PERSON MAKING THE INSPECTIONS, THE DATE(S) OF THE INSPECTIONS, AND MAJOR OBSERVATIONS ABOUT THE OPERATION AND MAINTENANCE OF EROSION AND SEDIMENTATION CONTROLS, MATERIALS STORAGE AREAS, AND VEHICLES ACCESS POINTS TO THE PARCEL. MAJOR OBSERVATIONS MUST INCLUDE BMPS THAT NEED MAINTENANCE, BMPS THAT FAILED TO OPERATE AS DESIGNED OR PROVED INADEQUATE FOR A PARTICULAR LOCATION, AND LOCATION(S) WHERE ADDITIONAL BMPS ARE NEEDED. FOR EACH BMP REQUIRING MAINTENANCE

REVISIONS

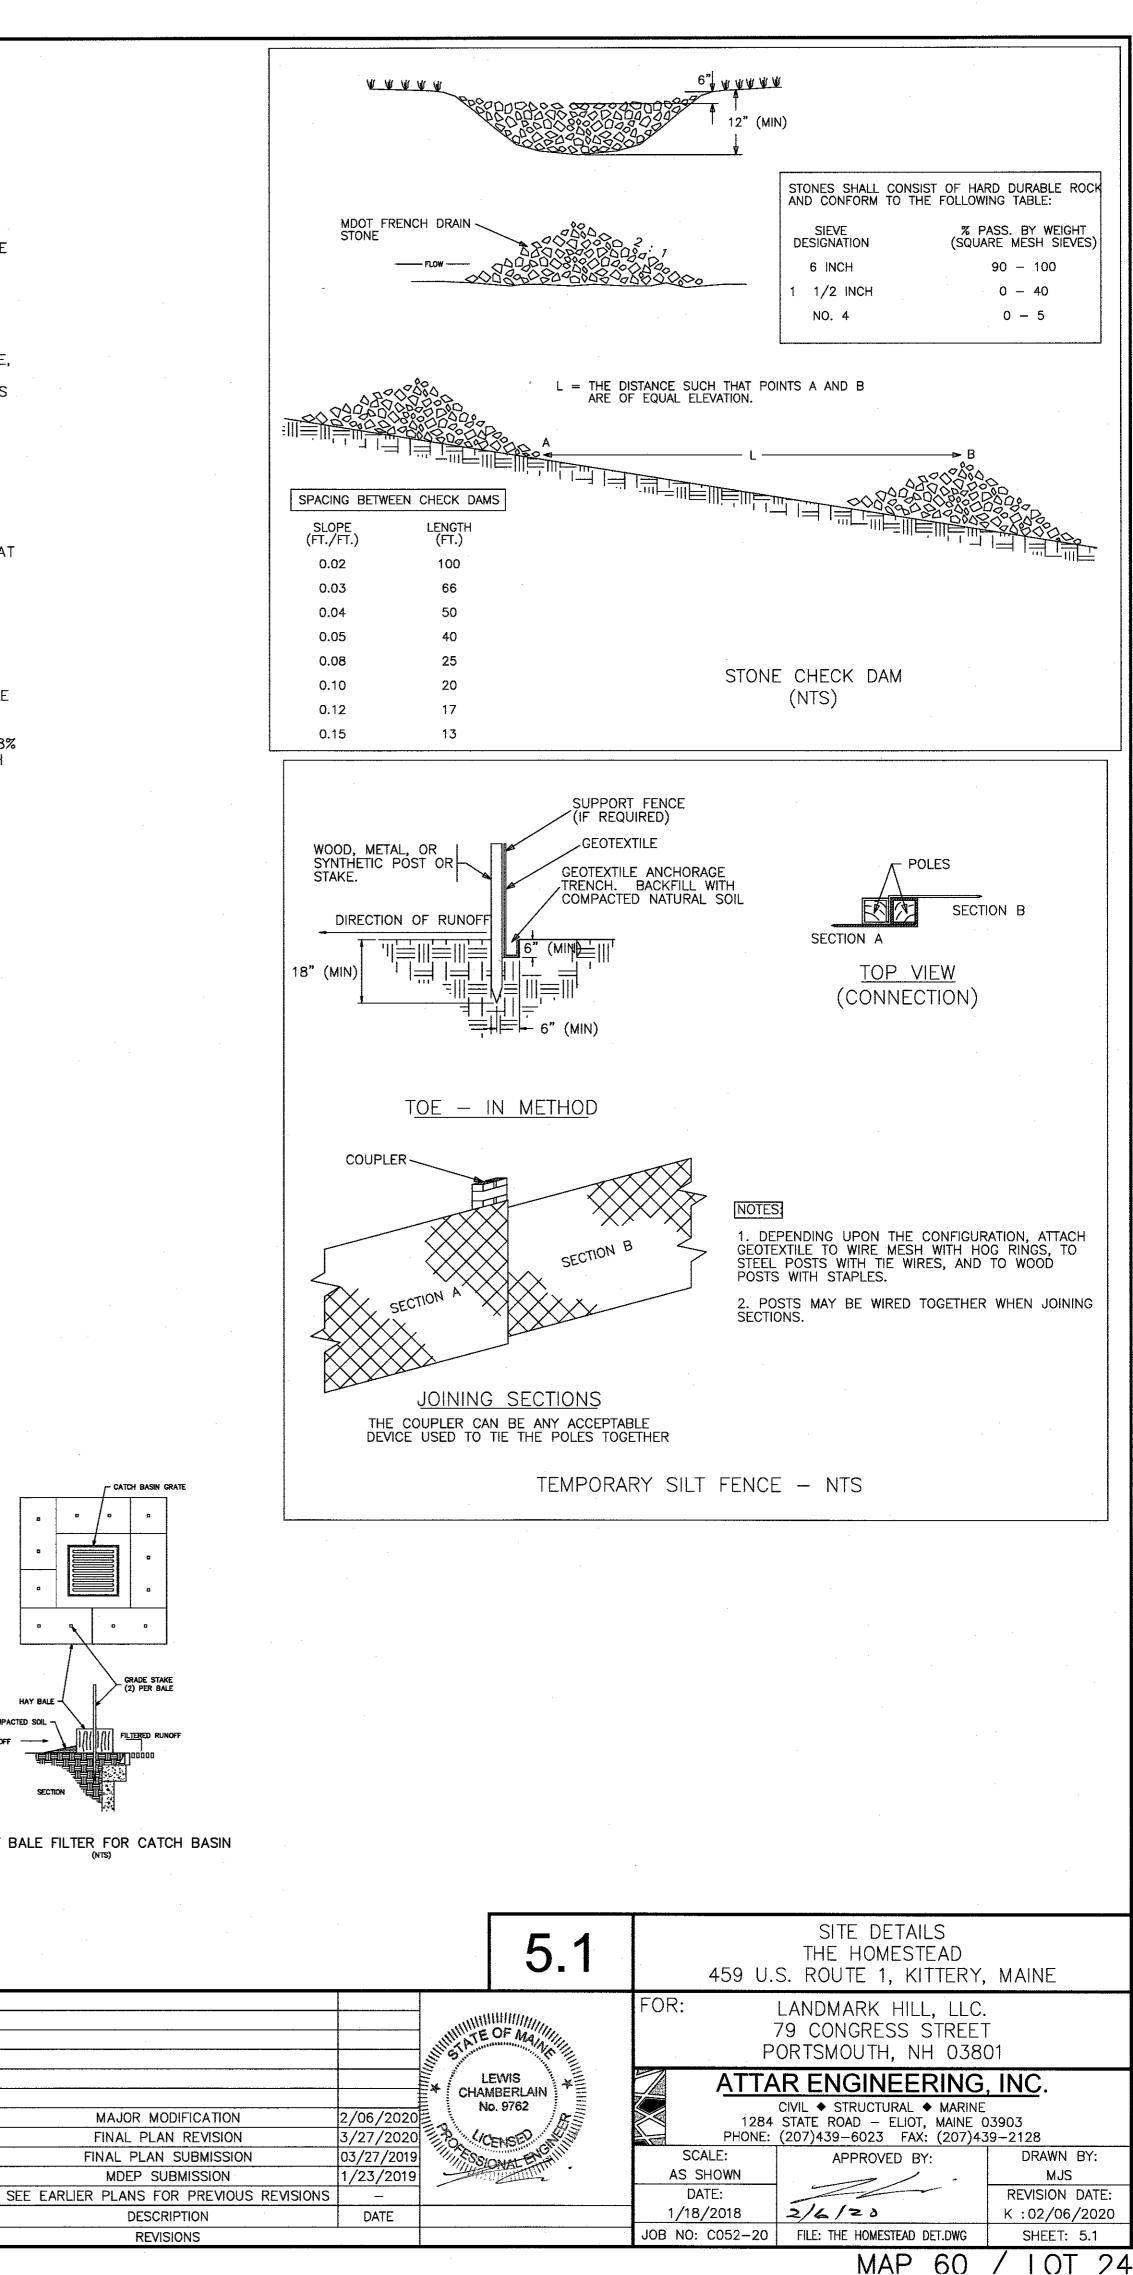


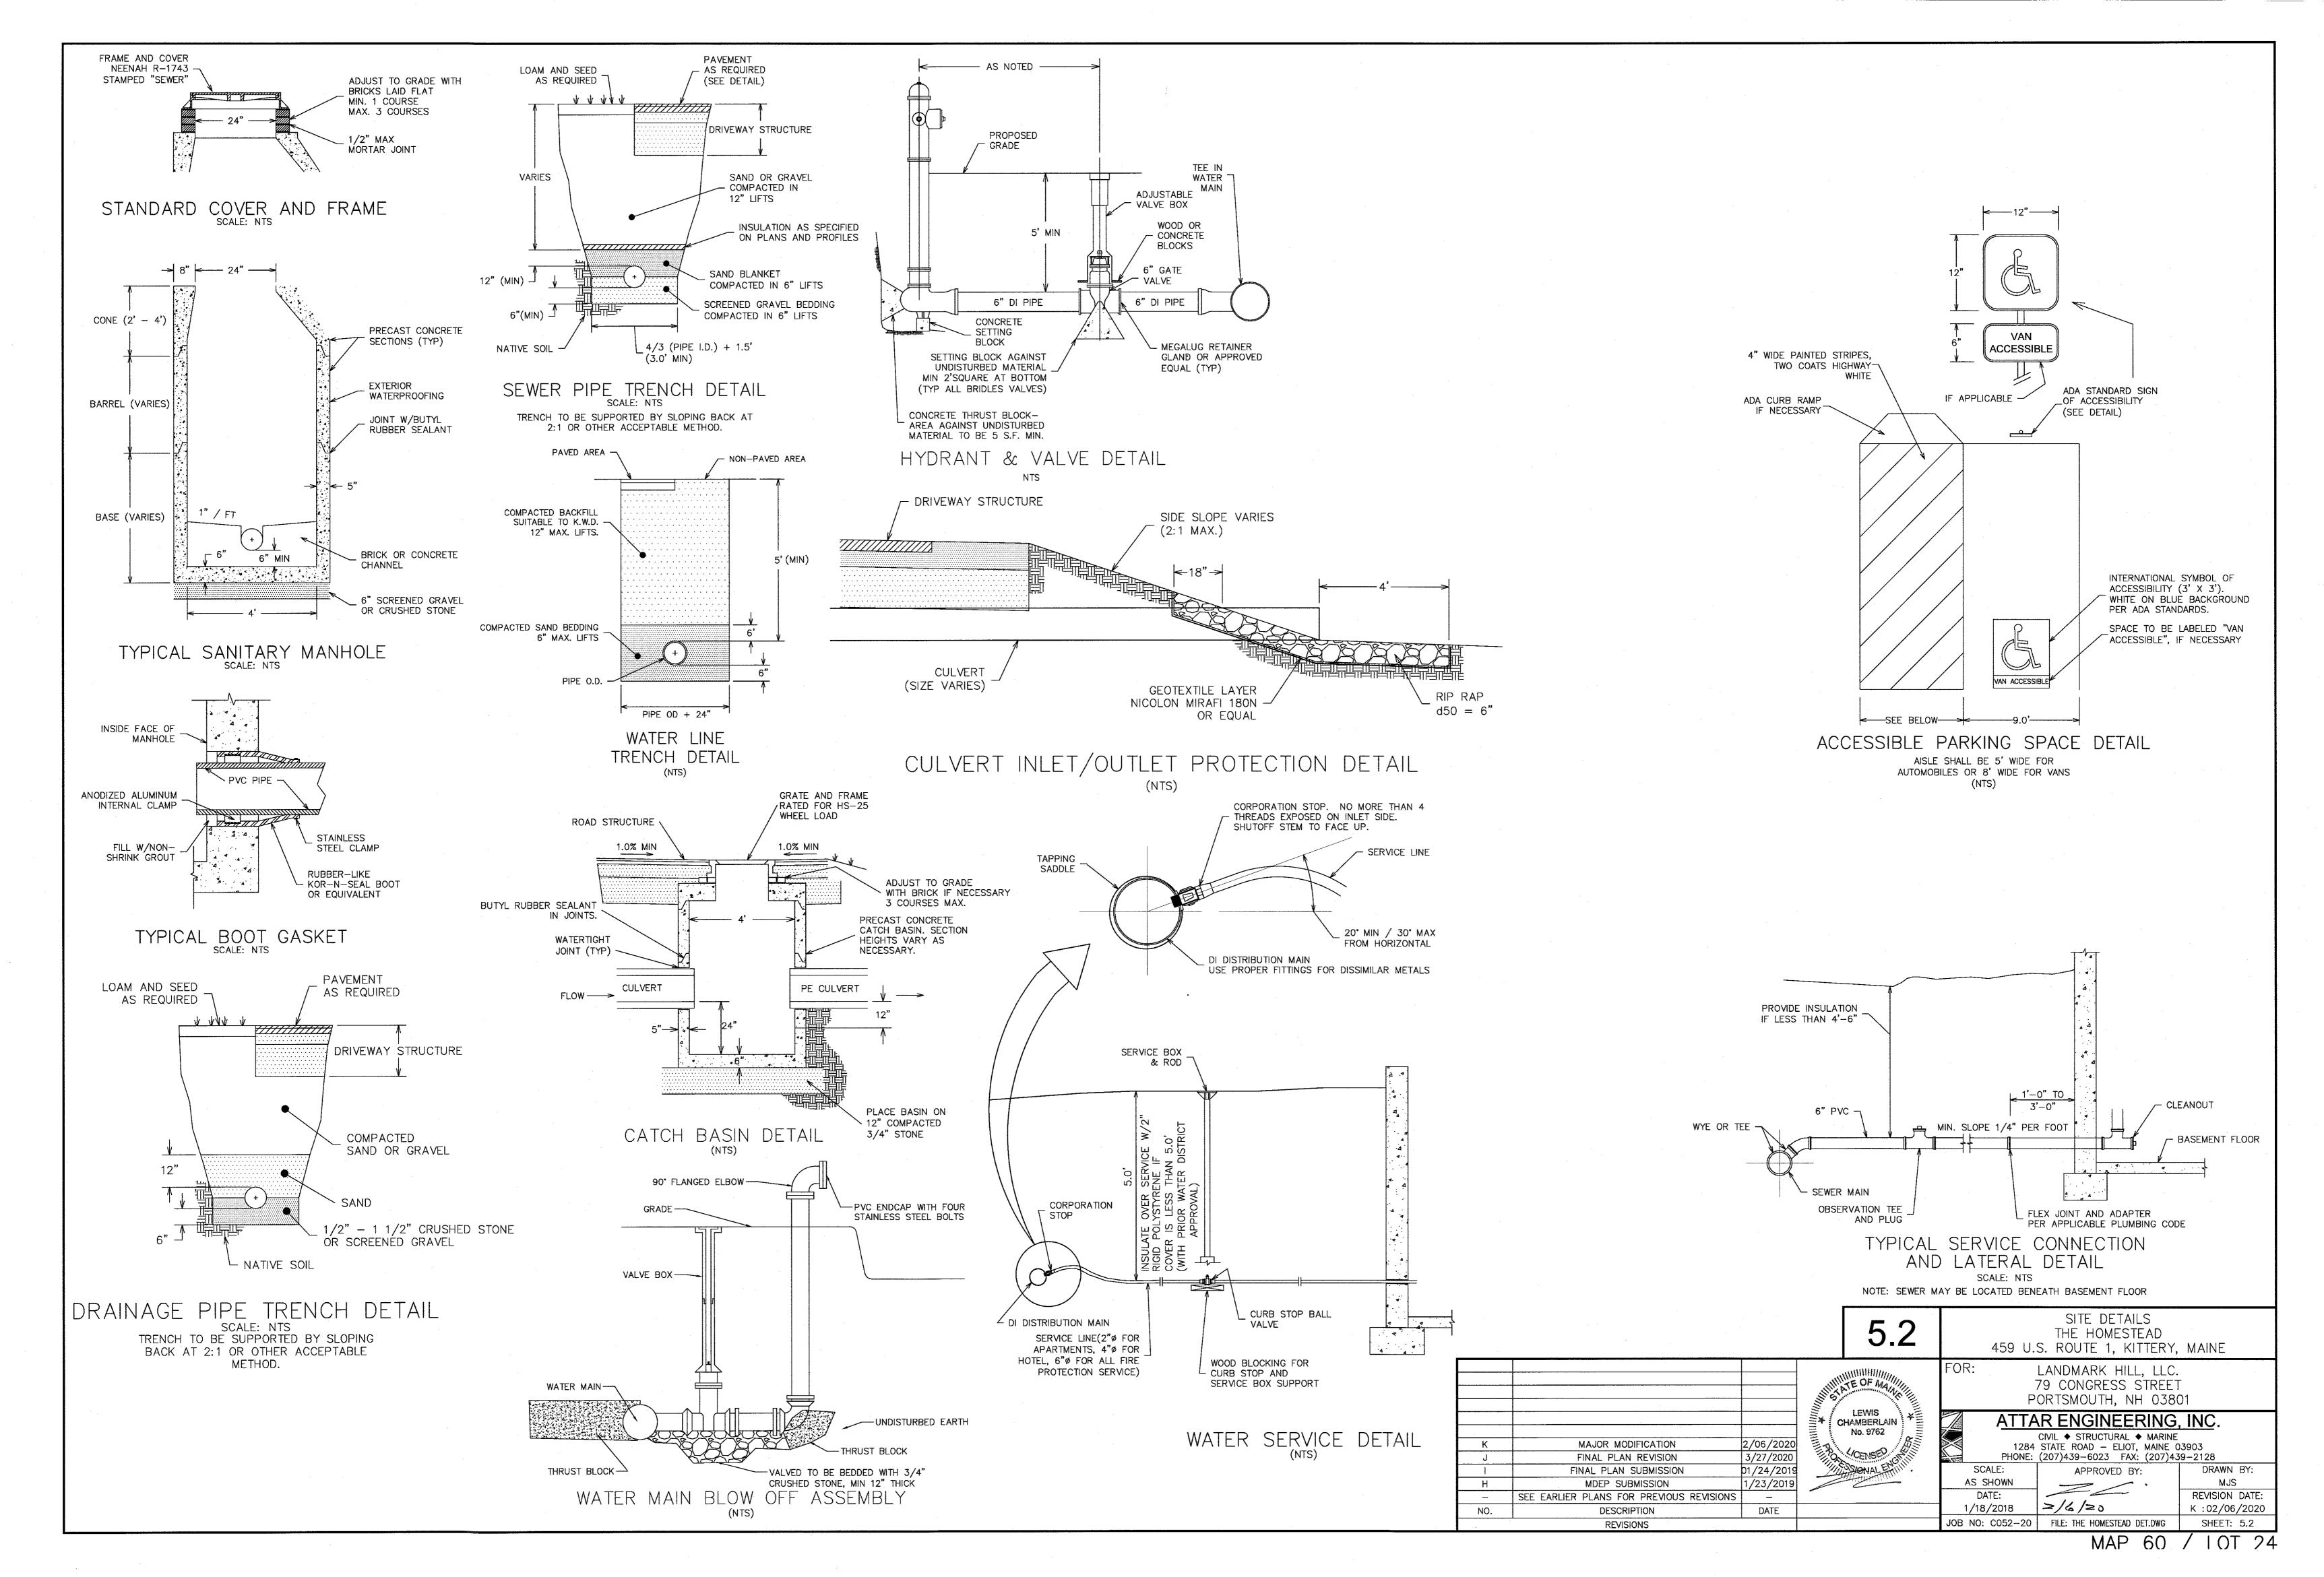


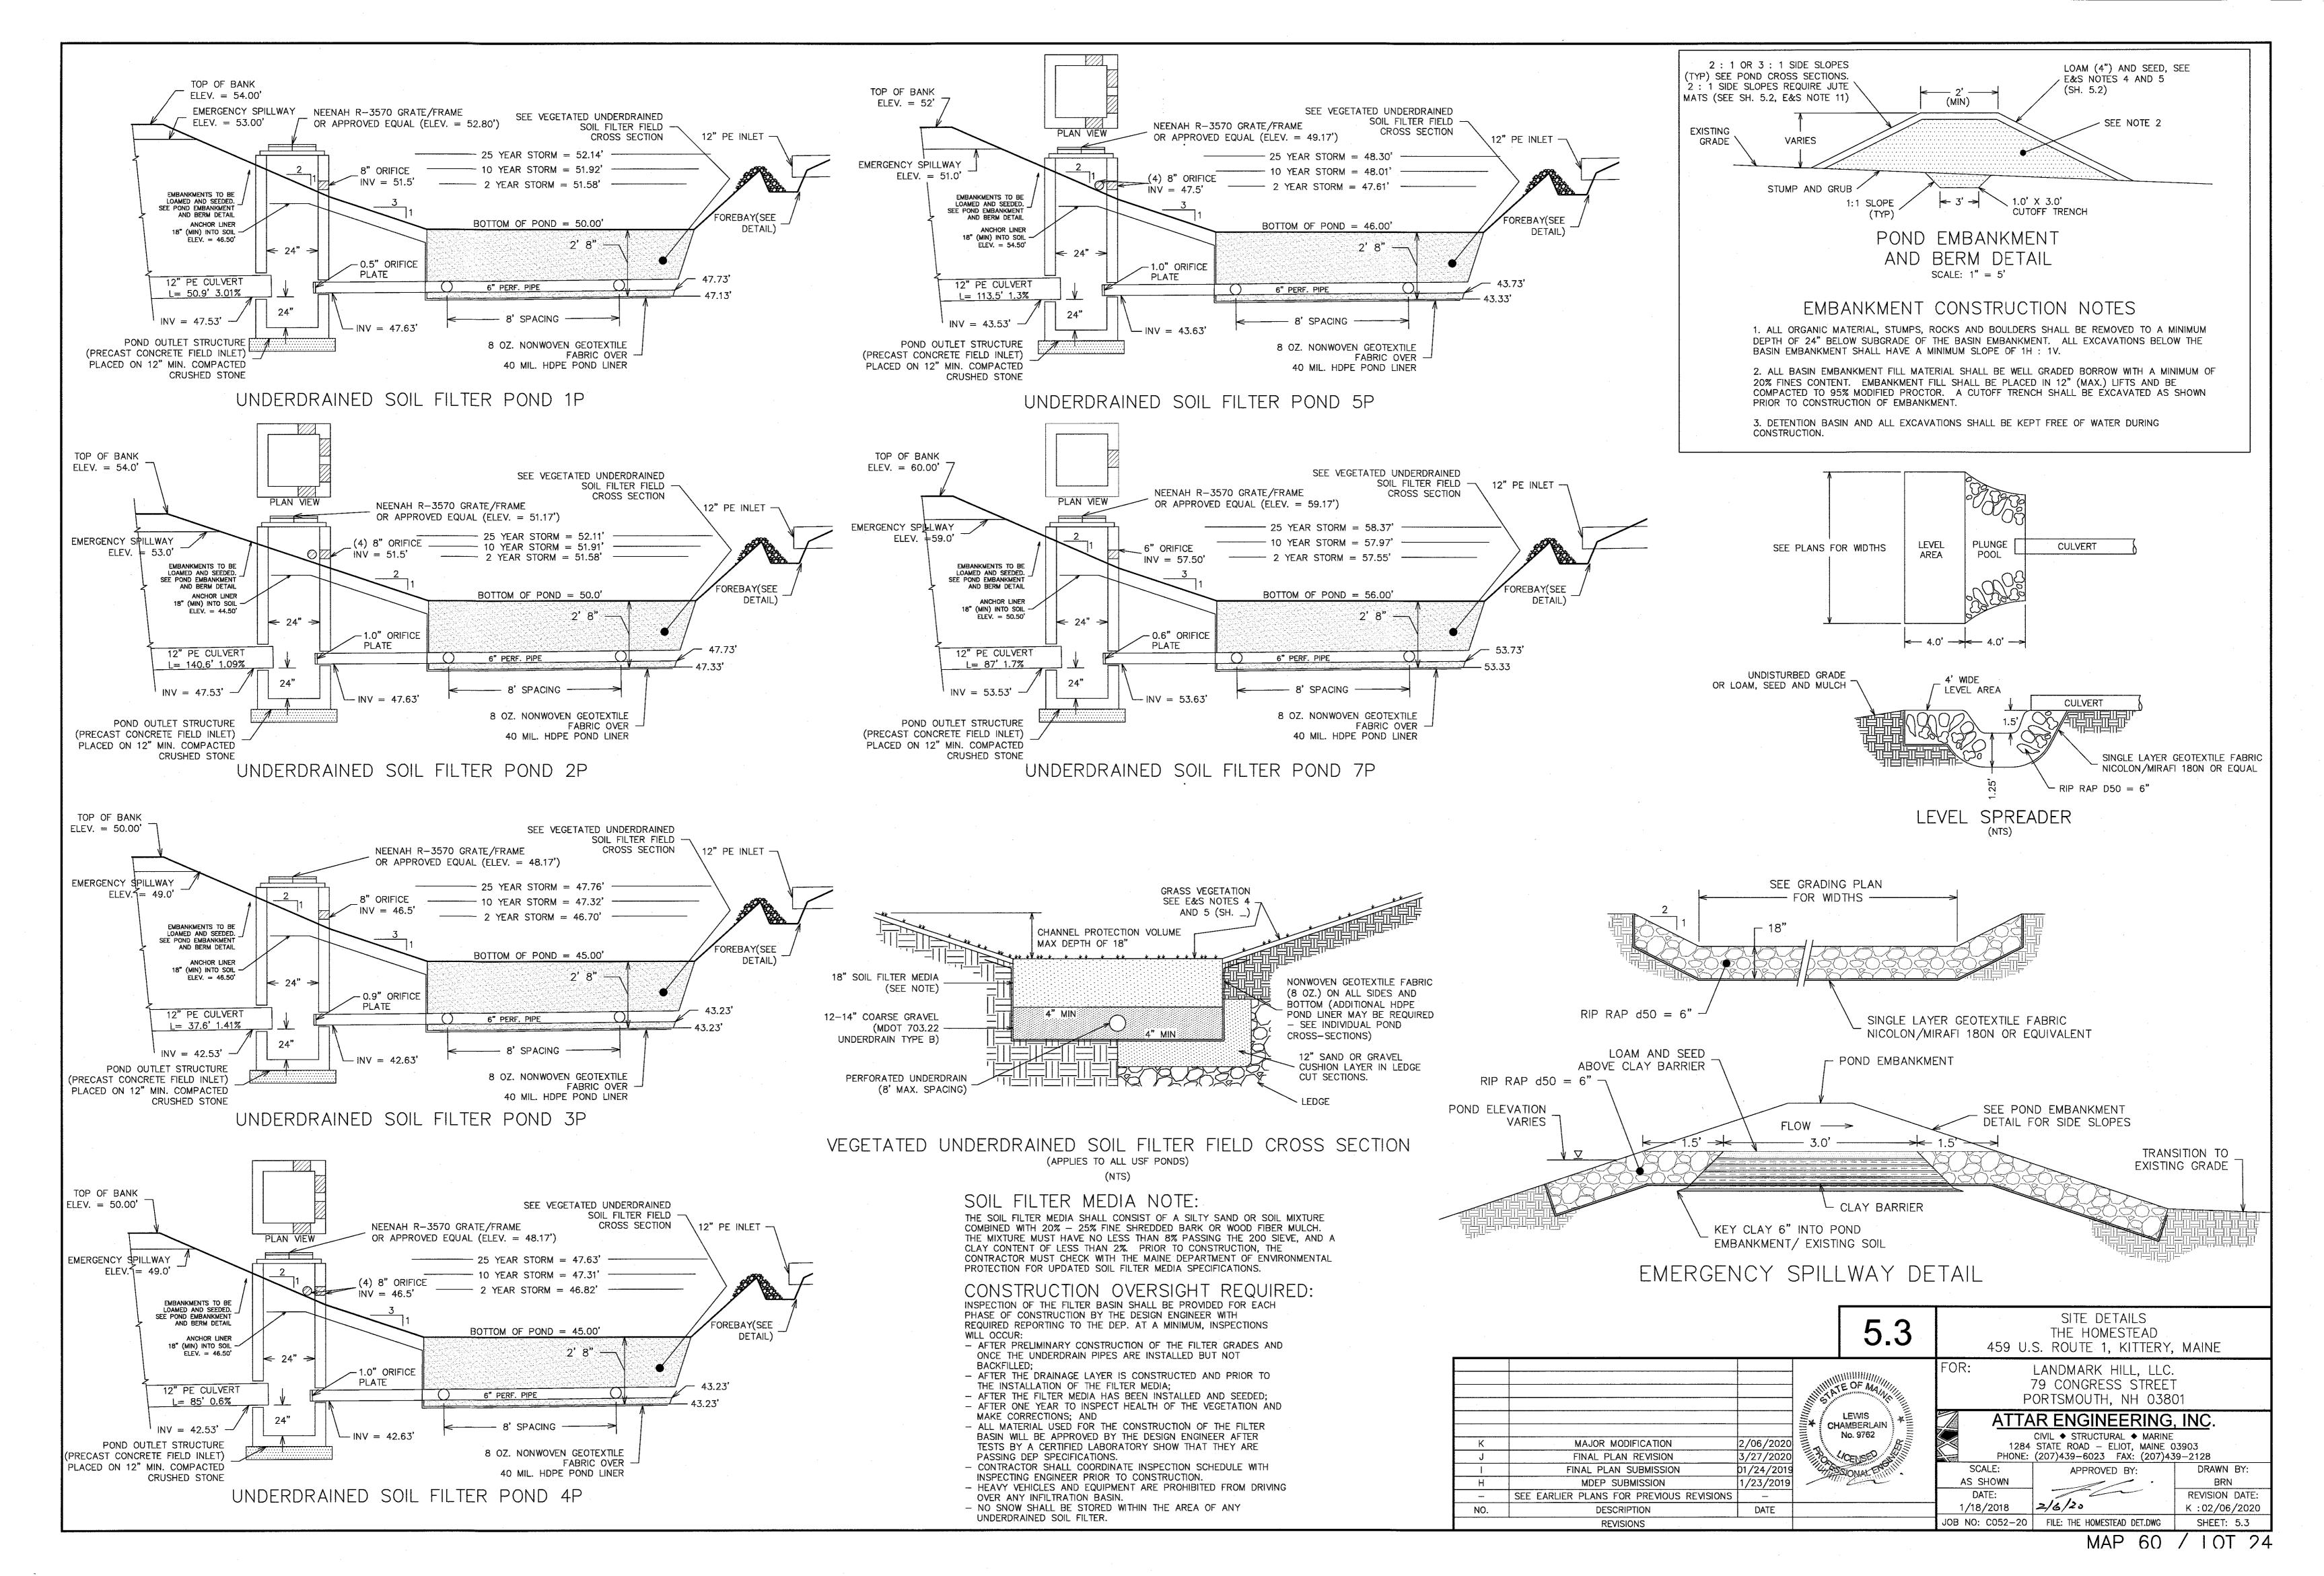

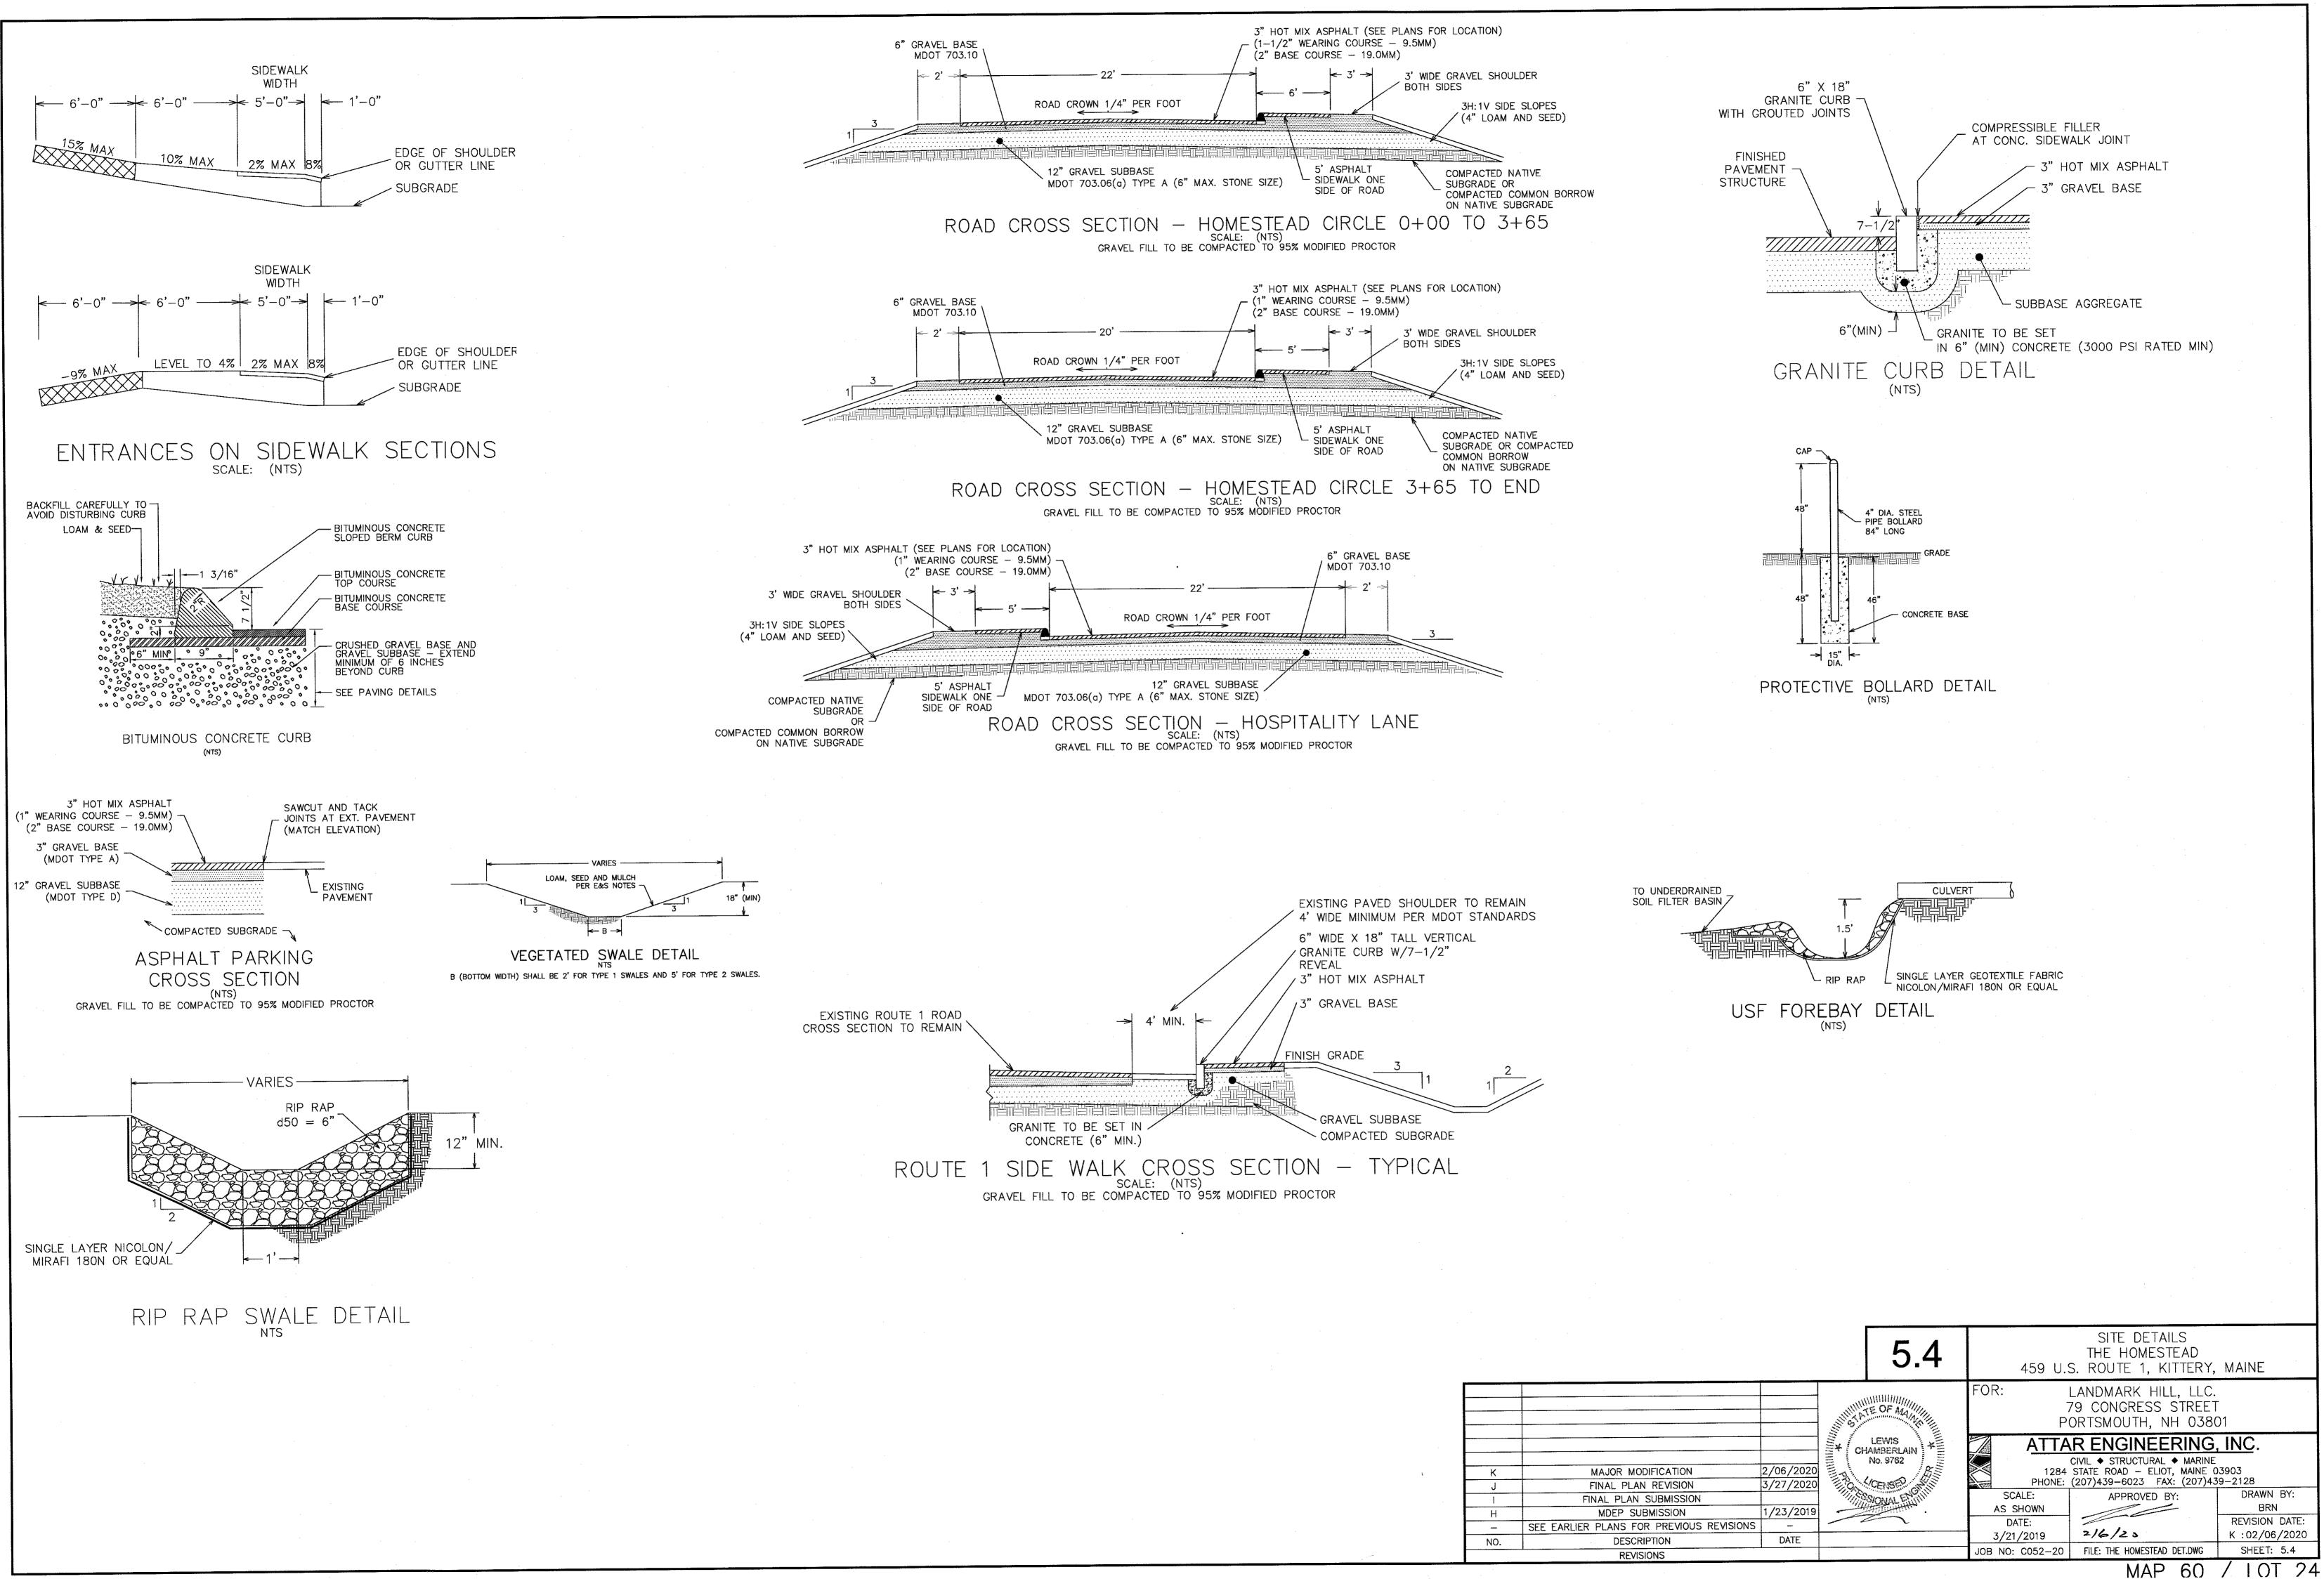

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## VICINITY MAP

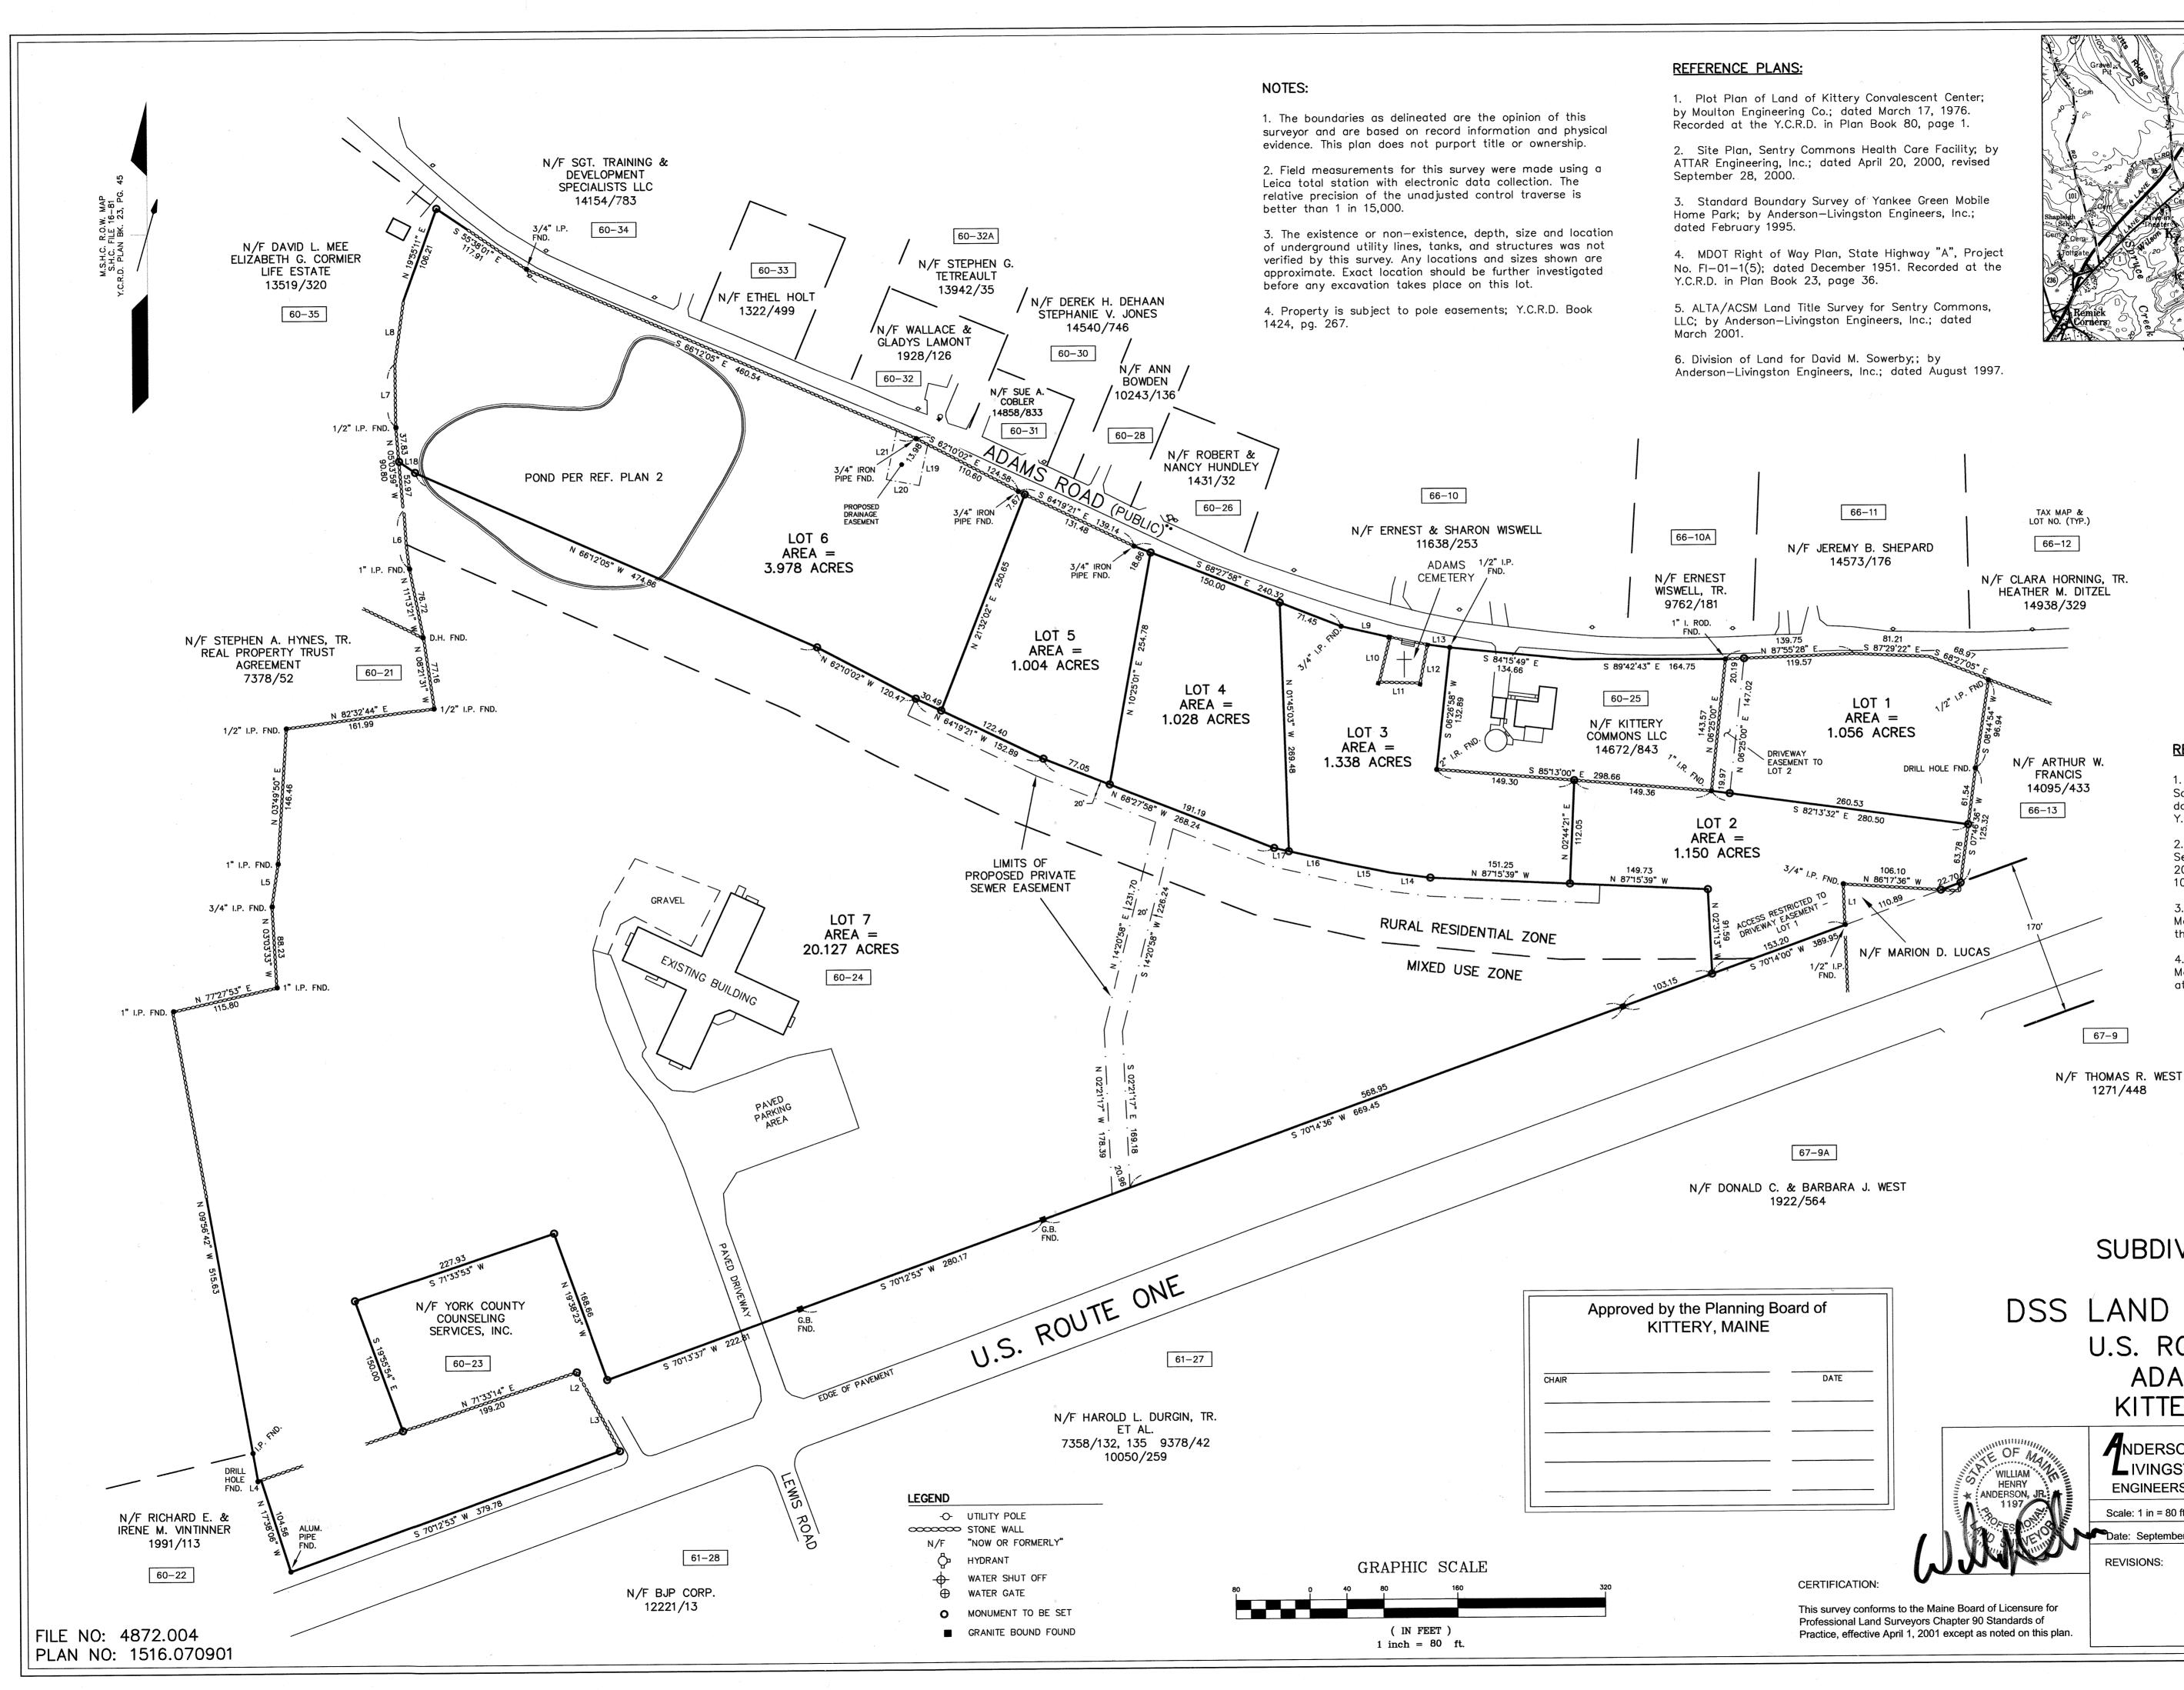BEARING TABLE					
LINE	BEARING	DIST			
L1	S 01°57'16" E	44.39			
L2	S 28'20'00" E	19.58			
L3	S 28°07'30" E	77.88			
L4	S 81'12'20" W	3.43			
L5	N 08'34'48" E	46.62			
L6	N 05°11'57" W	63.24			
L7	N 00°21'24" W	68.54			
L8	N 08°05'53" E	68.69			
L9	S 77°06'20" E	54.19			
L10	S 13*46'22" W	50.12			
L11	S 88"11'01" E	44.40			
L12	N 11'00'33" E	42.51			
L13	S 82°23'52" E	24.39			
L14	N 82°23'52" W	43.83			
L15	N 78'21'23" W	52.97			
L16	N 77°06'20" W	59.39			
L17	N 77°06'20" W	16.40			
L18	N 55'38'01" W	21.06			
L19	S 12°14'31" W	45.25			
L20	N 79'30'24" W	36.02			
L21	N 12°14'31" E	54.72			
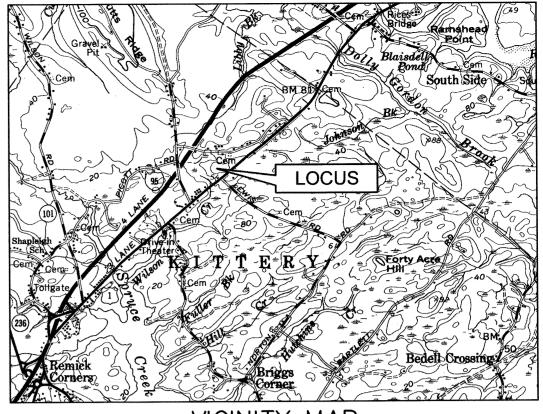
### **REFERENCE DEEDS:**

1. David M. Sowerby and Suzanne Sowerby to DSS Land Holdings, LLC; dated March 28, 1996. Recorded at the Y.C.R.D. in Book 7784, page 66.

2. Arnold F. & Jean S. Dickinson to Sentry Commons, LLC; dated July 28, 2000. Recorded at the Y.C.R.D. in Book 10147, page 184.


3. Marion D. Lucas to the State of Maine; dated April 24, 1952. Recorded at the Y.C.R.D. in Book 1205, page 527.


4. Rose E. Adams to the State of Maine; dated March 13, 1952. Recorded at the Y.C.R.D. in Book 1204, page 324.

		SUBDIVISION	N PLAN		
anning Board of MAINE DATE		DSS LAND HOLDINGS, LLC U.S. ROUTE ONE & ADAMS ROAD KITTERY, MAINE			
	WILLIAM HENRY	NDERSON IVINGSTON ENGINEERS, INC.	Suite 401 Cottage Place 433 II U.S. Route One York, Maine 03909		
	1197	Scale: 1 in = 80 ft.			
	TO ESTERNE	Date: September 14, 2007	OWNER:		
CERTIFICATION:	WWW	REVISIONS:	DSS Land Holdings, LLC P.O. Box 242 York, ME 03909		
	to the Maine Board of Licensure for				
	rrveyors Chapter 90 Standards of ril 1, 2001 except as noted on this plan.		Sheet 1 of 1 6.1		

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### LANDSCAPING NOTES

- 1) THE CONTRACTOR SHAL FOLLOW BEST MANAGEMENT PRACTICES DURING CONSTRUCTION AND SHALL TAKE ALL MEANS NECESSARY TO STABILIZE AND PROTECT THE SITE FROM EROSION.
- 2) EROSION CONTROL SHALL BE IN PLACE PRIOR TO CONSTRUCTION.
- 3) EROSION CONTROL TO CONSIST OF HAY BALES AND EROSION CONTROL FABRIC SHALL BE STAKED IN PLACE BETWEEN THE WORK AND WATER BODIES, WETLANDS AND/OR DRAINAGE WAYS PRIOR TO ANY CONSTRUCTION.
- 4) THE CONTRACTOR SHALL VERIFY LAYOUT AND GRADES AND INFORM THE LANDSCAPE ARCHITECT OR CLIENT'S REPRESENTATIVE OF ANY DISCREPANCIES OR CHANGES IN LAYOUT AND/OR GRADE RELATIONSHIPS PRIOR TO CONSTRUCTION.
- 5) THE CONTRACTOR SHALL VERIFY EXACT LOCATION AND ELEVATION OF ALL UTILITIES WITH RESPECTIVE UTILITY OWNERS PRIOR TO CONSTRUCTION. CALL DIGSAFE AT 1-888-344-7233.
- 6) THE CONTRACTOR SHALL GUARANTEE ALL PLANTS FOR NOT LESS THAN TWO YEARS FROM THE TIME OF ACCEPTANCE.
- 7) ALL LANDSCAPING SHALL BE PROVIDED WITH EITHER OF THE FOLLOWING: 7)1) AN UNDERGROUND SPRINKLER SYSTEM
- 7)2) AN OUTSIDE HOSE ATTACHMENT WITHIN 150 FEET
- 8) TREES, GROUND COVER, AND SHRUB BEDS SHALL BE MULCHED TO A DEPTH OF 2" WITH ONE-YEAR-OLD, WELL-COMPOSTED, SHREDDED NATIVE BARK NOT LONGER THAN 4" IN LENGTH AND 1/2" IN WIDTH, FREE OF WOODCHIPS AND SAW DUST. MULCH FOR FERNS AND HERBACEOUS PERENNIALS SHALL BE NO LONGER THAN 1" IN LENGTH. TREES IN LAWN AREAS SHALL BE MULCHED IN A 5' DIAMETER MIN. SAUCER.
- 9) ALL DISTURBED AREAS WILL BE DRESSED WITH 4" OF TOPSOIL AND PLANTED AS NOTED ON THE PLANS OR SEEDED EXCEPT PLANT BEDS. PLANT BEDS SHALL BE PREPARED TO A DEPTH OF 12" WITH 75% LOAM AND 25% COMPOST.
- 10) NUMBER OF TREES AND PLANTS REQUIRED AT FRONTAGE:

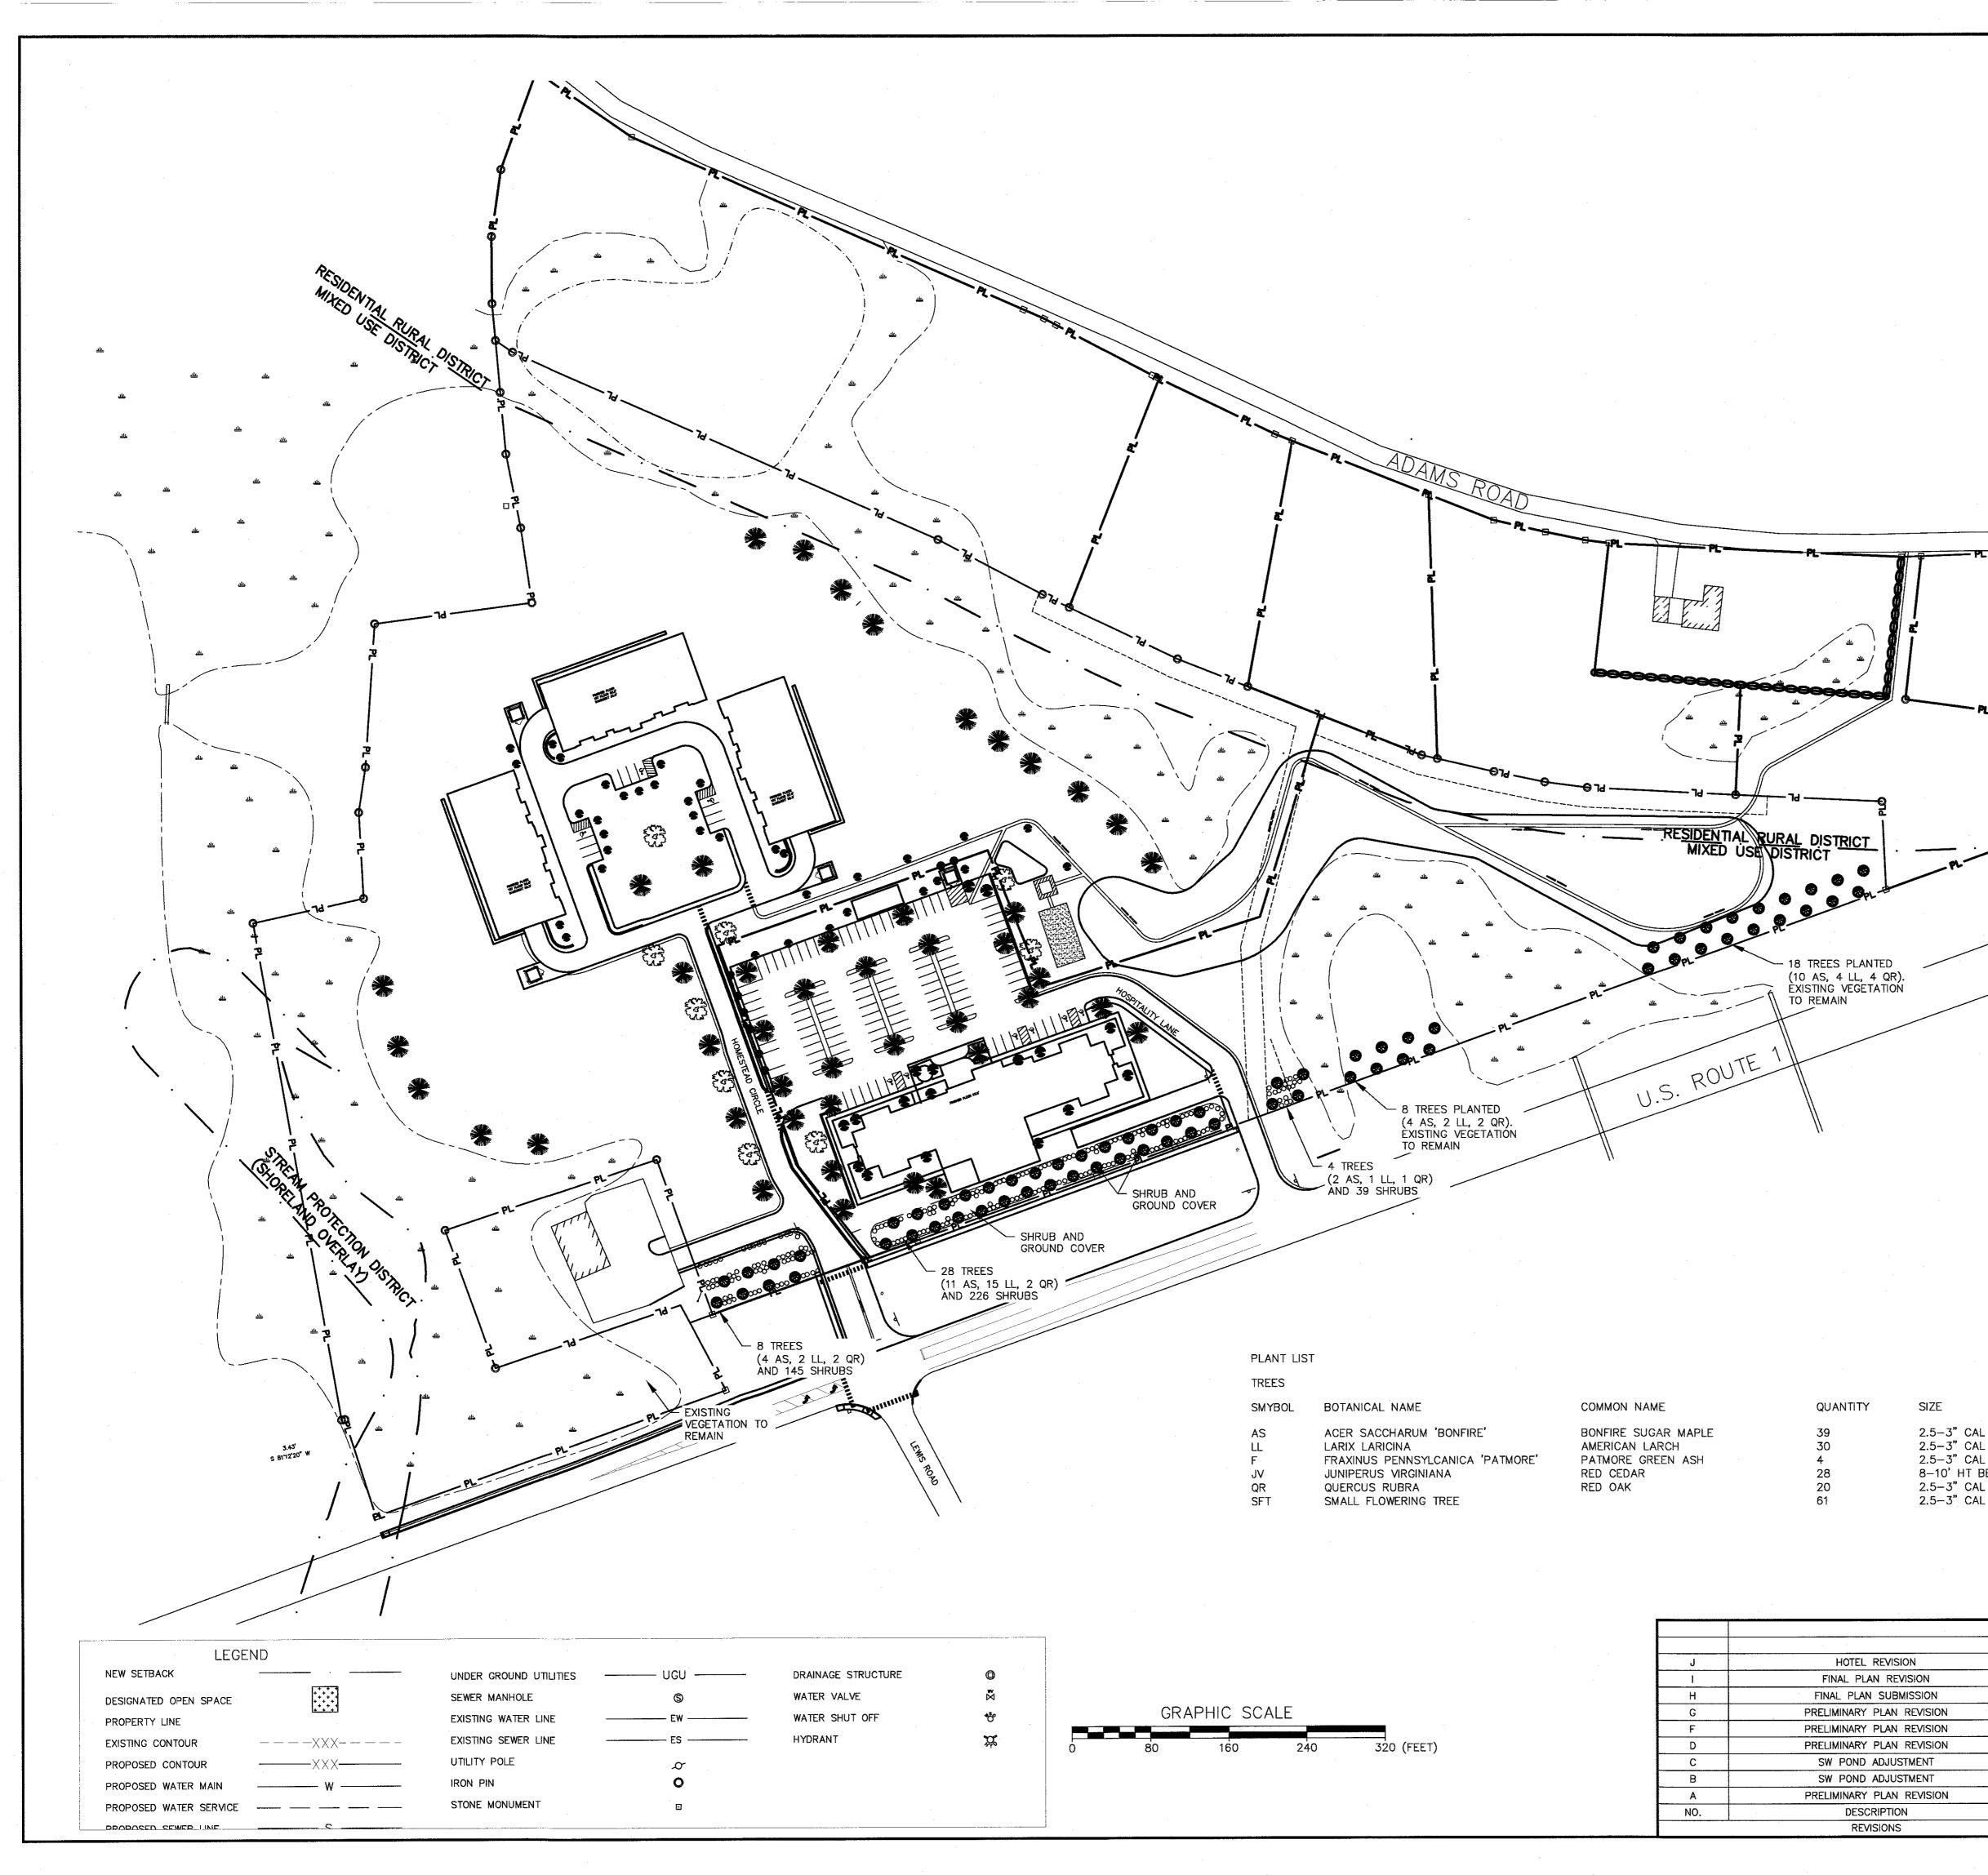	TREES	PLANTS
REQUIRED	60	375
PROPOSED	66	410

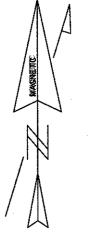
11) NUMBER OF TREES AND PLANTS REQUIRED AT PARKING:

### TREES REQUIRED 1 PER 8 SPACES (13)

PROPOSED 38 12) LANDSCAPED BUFFER TREES TO BE PLANTED AT 25' CL SPACING.

2.5-3" CAL 2.5-3" CAL 2.5-3" CAL 8–10' HT BB 2.5-3" CAL

		6.2	LANDSCAPING PLAN THE HOMESTEAD 459 US ROUTE 1 KITTERY, MAINE			
	11/21/2019 03/27/2019		FOR: LANDMARK HILL, LLC 79 CONGRESS ST PORTSMOUTH, NH 03801			
IN SION SION SION	01/24/2019 5/08/2018 4/19/2018 03/27/2018		ATTAR ENGINEERING, INC. CIVIL • STRUCTURAL • MARINE 1284 STATE ROAD - ELIOT, MAINE 03903 PHONE: (207)439-6023 FAX: (207)439-2128			
T T Sion	02/08/2018 02/06/2018 1/18/2018 DATE	· · · · · · · · · · · · · · · · · · ·	SCALE:         APPROVED BY:         DRAWN BY:           1" = 80'         BRN           DATE:         REVISION : DATE           02/08/2018         J: 11/21/2019			
	DAIL		JOB NO: C052-20 FILE: THE HOMESTEAD BASE SHEET 6.2 TAX MAP 60, LOT 24			

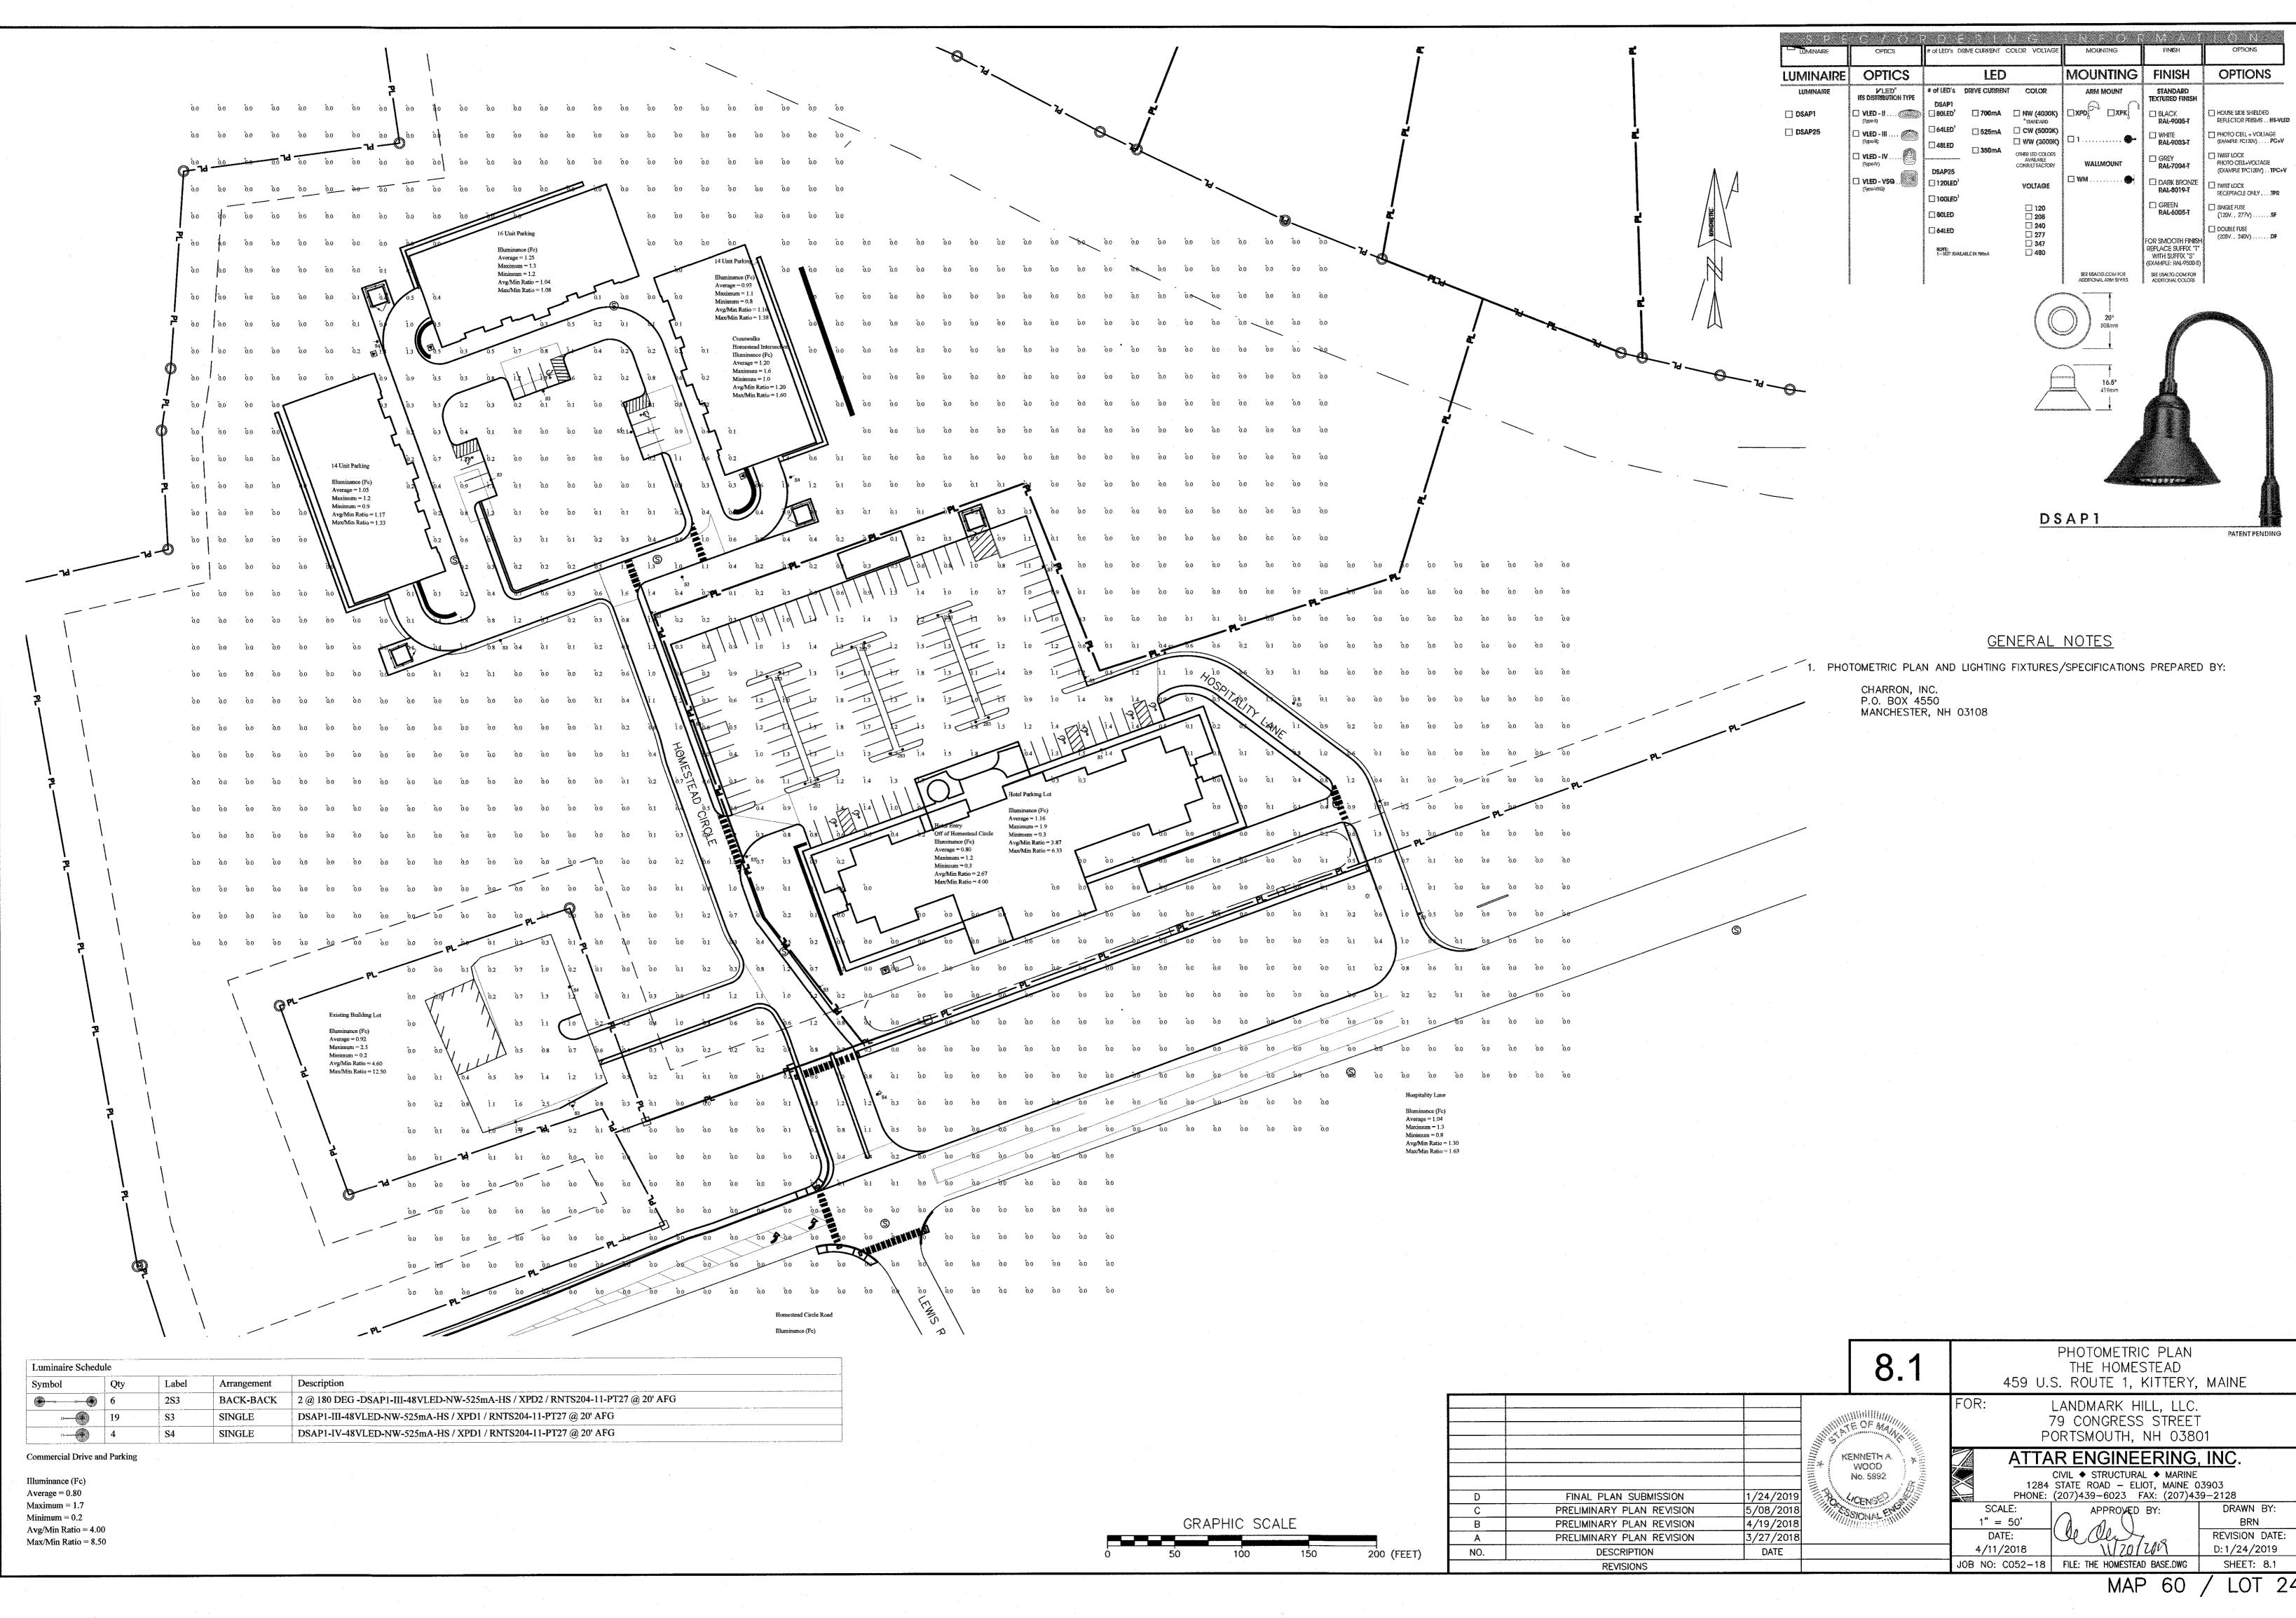

		8.1	459 U.	PHOTOMETRIC PLAN THE HOMESTEAD S. ROUTE 1, KITTERY,	MAINE
		ATE OF MANNE		LANDMARK HILL, LLC. 79 CONGRESS STREET ORTSMOUTH, NH 0380	-
FINAL PLAN SUBMISSION	1/24/2019	KENNETH A. WOOD No. 5992	1284	CIVIL ◆ STRUCTURAL ◆ MARINE STATE ROAD – ELIOT, MAINE ( (207)439-6023 FAX: (207)43	)3903
ELIMINARY PLAN REVISION	5/08/2018		SCALE:	APPROVED BY:	DRAWN BY:
ELIMINARY PLAN REVISION	4/19/2018	· · · · · · · · · · · · · · · · · · ·	1" = 50'	$(\lambda, \lambda, ())$	BRN
ELIMINARY PLAN REVISION	3/27/2018		DATE:	Olly 7- 18	REVISION DATE:
DESCRIPTION	DATE		4/11/2018	<u></u>	D:1/24/2019
REVISIONS		· · · · · · · · · · · · · · · · · · ·	JOB NO: C052-18	FILE: THE HOMESTEAD BASE.DWG	SHEET: 8.1