24 FOYES LANE

KITTERY POINT, MAINE 03905

ARCHITECT:

WINTER HOLBEN architecture + design 7 WALLINGFORD SQUARE, UNIT 2099 KITTERY, MAINE 03904 PHONE: (207) 994-3104

OWNER

MARSHLARK, LLC 4 TENNEY HILL ROAD KITTERY POINT, MAINE 03905 **CIVIL ENGINEER:**

NORTH EASTERLY SURVEYING **1021 GOODWIN ROAD** ELIOT, MAINE 03903 PHONE: (207) 439-6333

STRUCTURAL ENGINEER:

DEC ENTERPRISES

SQUARE FOOTAGE

INDICATES DIRECTION OF PLAN NORTH

ELEVATION HEIGHT

INDICATES DIRECTION OF

MEP ENGINEER:


DEC ENTERPRISES

TIMBER FRAME DESIGNER:


EASTERN RIVER POST & BEAM 19 KENDALL RD. STRAFFORD, VT 05072 802-765-4702

GENERAL CONTRACTOR:

MAINELY RENOVATIONS INC. 384 HL DOW HIGHWAY, UNIT 11 ELIOT, MAINE 03904

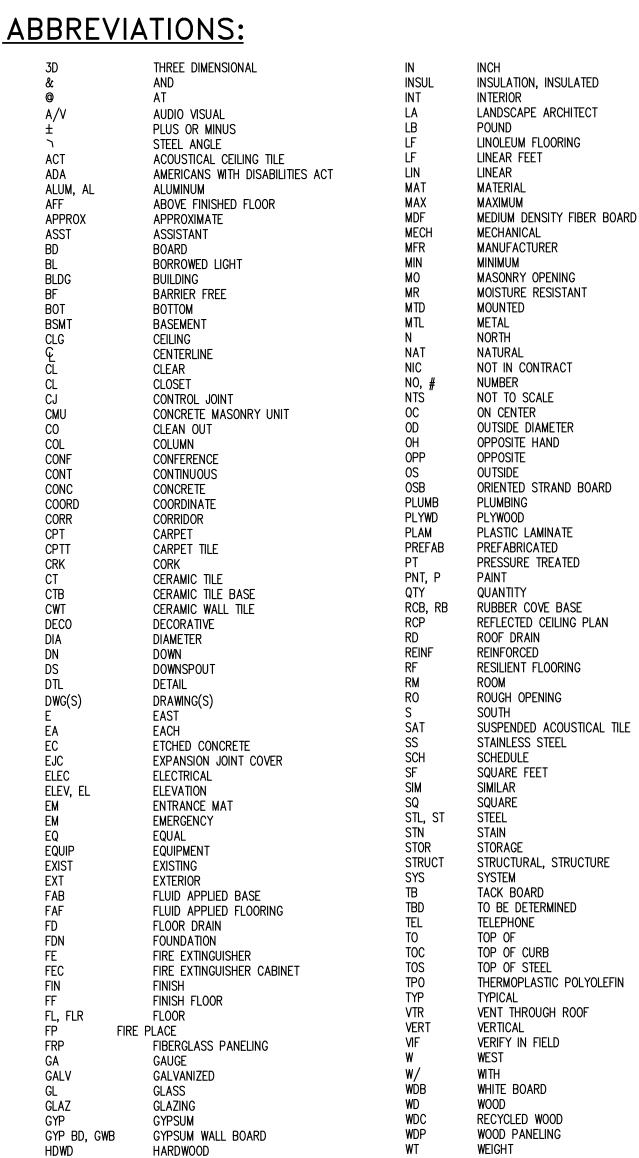

LEGEND:

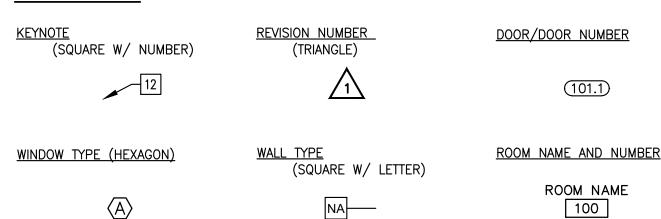

DETAIL INDICATOR NORTH ARROW

IS LOCATED ON

INDICATES DETAIL NUMBER INDICATES SHEET DETAIL IS LOCATED ON EXTERIOR ELEVATION INDICATOR **ELEVATION MARK**

INDICATES ELEVATION NUMBER INDICATES SHEET ELEVATION

DETAIL SECTION CUT INDICATES SECTION NUMBER INDICATES SHEET SECTION IS LOCATED ON


INTERIOR ELEVATION INDICATOR INDICATES DRAWING NUMBER

IS LOCATED ON

ROOM FINISHES TAG ROOM NAME ROOM NO. FLOOR BASE TRIM TRIM INDICATES SHEET ELEVATION

MATCH LINE

DRAWING TITLE

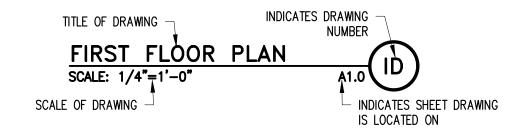


GENERAL NOTES:

- WORK INCLUDED IN THIS CONTRACT SHALL CONFORM TO NATIONAL, STATE, AND LOCAL CODES AND ORDINANCES THAT APPLY TO THE PROJECT.
- 2. DO NOT SCALE DRAWINGS FOR DIMENSIONS. FOR MISSING DIMENSIONS OR DIMENSIONS IN CONFLICT, CONTACT THE ARCHITECT IMMEDIATELY BEFORE CONTINUING WITH THE WORK.
- 3. ANY DISCREPANCIES IN THESE PLANS SHALL BE BROUGHT TO THE ARCHITECT'S ATTENTION IMMEDIATELY.
- 4. REFER TO MECHANICAL, ELECTRICAL, PLUMBING, AND FIRE PROTECTION DRAWINGS AND SPECIFICATIONS FOR LOCATION OF ALL BLOCK OUTS, INSERTS, OPENINGS, CURBS, BASES, AND PADS THAT ARE NOT DIMENSIONED OR SHOWN ON ARCHITECTURAL OR STRUCTURAL DRAWINGS.
- 5. EXTERIOR DIMENSIONS ARE FROM FACE OF SHEATHING TO FACE OF SHEATHING UNLESS NOTED OTHERWISE. INTERIOR DIMENSIONS ARE FROM FACE OF FINISH TO FACE OF FINISH UNLESS OTHERWISE NOTED. DIMENSIONS INDICATED AS "CLEAR" SHALL MAINTAIN A CLEAR OPENING WIDTH FROM FACE OF FINISHES. DIMENSIONS TO EXISTING CONSTRUCTION ARE TO FACE OF FINISH UNLESS NOTED OTHERWISE.
- 6. WORK FROM GIVEN DIMENSIONS AND LARGE SCALE DETAILS ONLY. DO NOT SCALE DRAWINGS.
- ROOM NUMBERS ON PLANS ARE FOR REFERENCE ONLY AND MAY NOT CORRESPOND TO ACTUAL ROOM NUMBERS AT THE
- 8. BEFORE PENETRATING JOISTS, BEAMS, OR OTHER STRUCTURAL MEMBERS, OBTAIN APPROVAL FROM THE ARCHITECT.
- 9. HE LOCATION OF DOOR OPENING NOT DIMENSIONS SHALL BE 6" FROM ADJACENT WALL (FACE OF FRAMING TO ROUGH
- 10. PROVIDE BLOCKING BEHIND SURFACE APPLIED FIXTURES, TRIM, GRAB BARS, SHELVES, CHAIR RAILS, PICTURE RAILS, WOOD TRIM, BASE, AND OTHER ACCESSORIES WHEN MOUNTED ON THE STUD WALLS.
- 12. PERMITS ARE THE RESPONSIBILITY OF THE CONTRACTOR AND SHALL BE COORDINATED WITH PHASING AND THE LOCAL

EXTERIOR PERSPECTIVE



SITE LOCATION MAP:

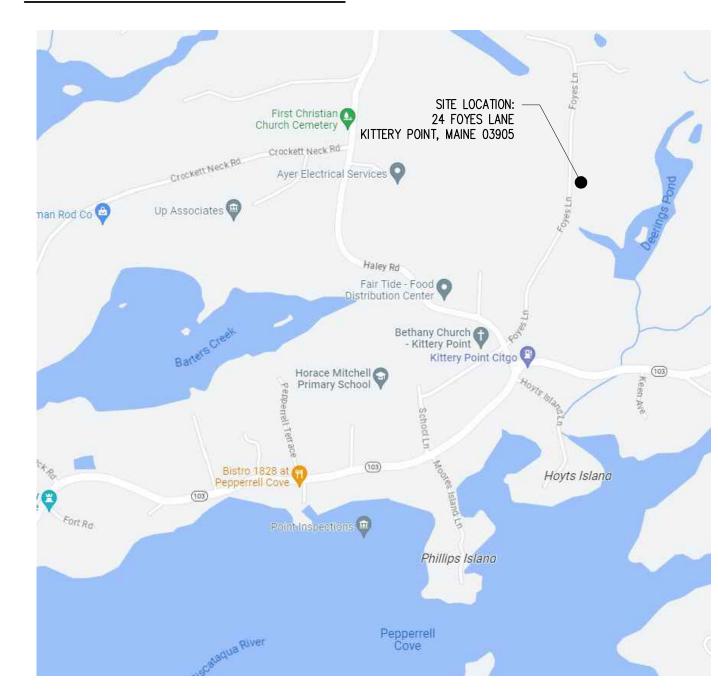

DRAWING INDEX:

<u>GENERAL</u>

TO.1 TITLE SHEET

ARCHITECTURAL DRAWINGS

LOWER LEVEL FLOOR PLAN UPPER LEVEL FLOOR PLAN

A2.0 EXTERIOR ELEVATIONS

A3.0 BUILDING SECTION

A7.0 WINDOW TYPES

A8.0 BUILDING PERSPECTIVES

(207) 439-3788

24 FOYES LANE POINT, MAINE 03905

FOYES

24

AT

RESIDENCE

WINTER HOLBEN architecture + design

7 WALLINGFORD SQ UNIT 209-9 KITTERY, MAINE 03904 207.994.3104

REVISIONS:

RESIDENCE AT 24 FOYES

24 FOYES LANE KITTERY POINT, ME 03905

PROJECT NO.

DRAWN BY: APPROVED BY ISSUE DATE:

RAWING NAME:

TITLE SHEET

07.14.2023

RAWING NO.

© 2023 WINTER HOLBEN DESIGN, LLC

MATERIAL KEY:

HARDWARE

HORIZONTAL

HIGH POINT

HOLLOW METAL

HOLLOW STRUCTURAL SECTION

COARSE GRAVEL CONCRETE

HDWR, HDW

HORIZ

HSS

STONE

GYPSUM/ PLASTER

EARTH/ COMPACT FILL CONCRETE MASONRY BRICK MASONRY SAND/ FINE GRAVEL PLYWOOD RIGID INSULATION BATT INSULATION


FINISH WOOD GLASS ROUGH WOOD BLOCKING WOOD

STONE VENEER SPRAY-FOAM INSULATION

11. WHERE WALLS OR INFILL WALLS ABUT OR INTERSECT EXISTING WALLS, TAPE AND FINISH JOINTS AT INTERSECTIONS SMOOTH

BUILDING COMMISSIONER.

AND CONTINUOUS. USE METAL TRIM WHERE GYPSUM BOARD INTERSECTS OTHER MATERIALS.

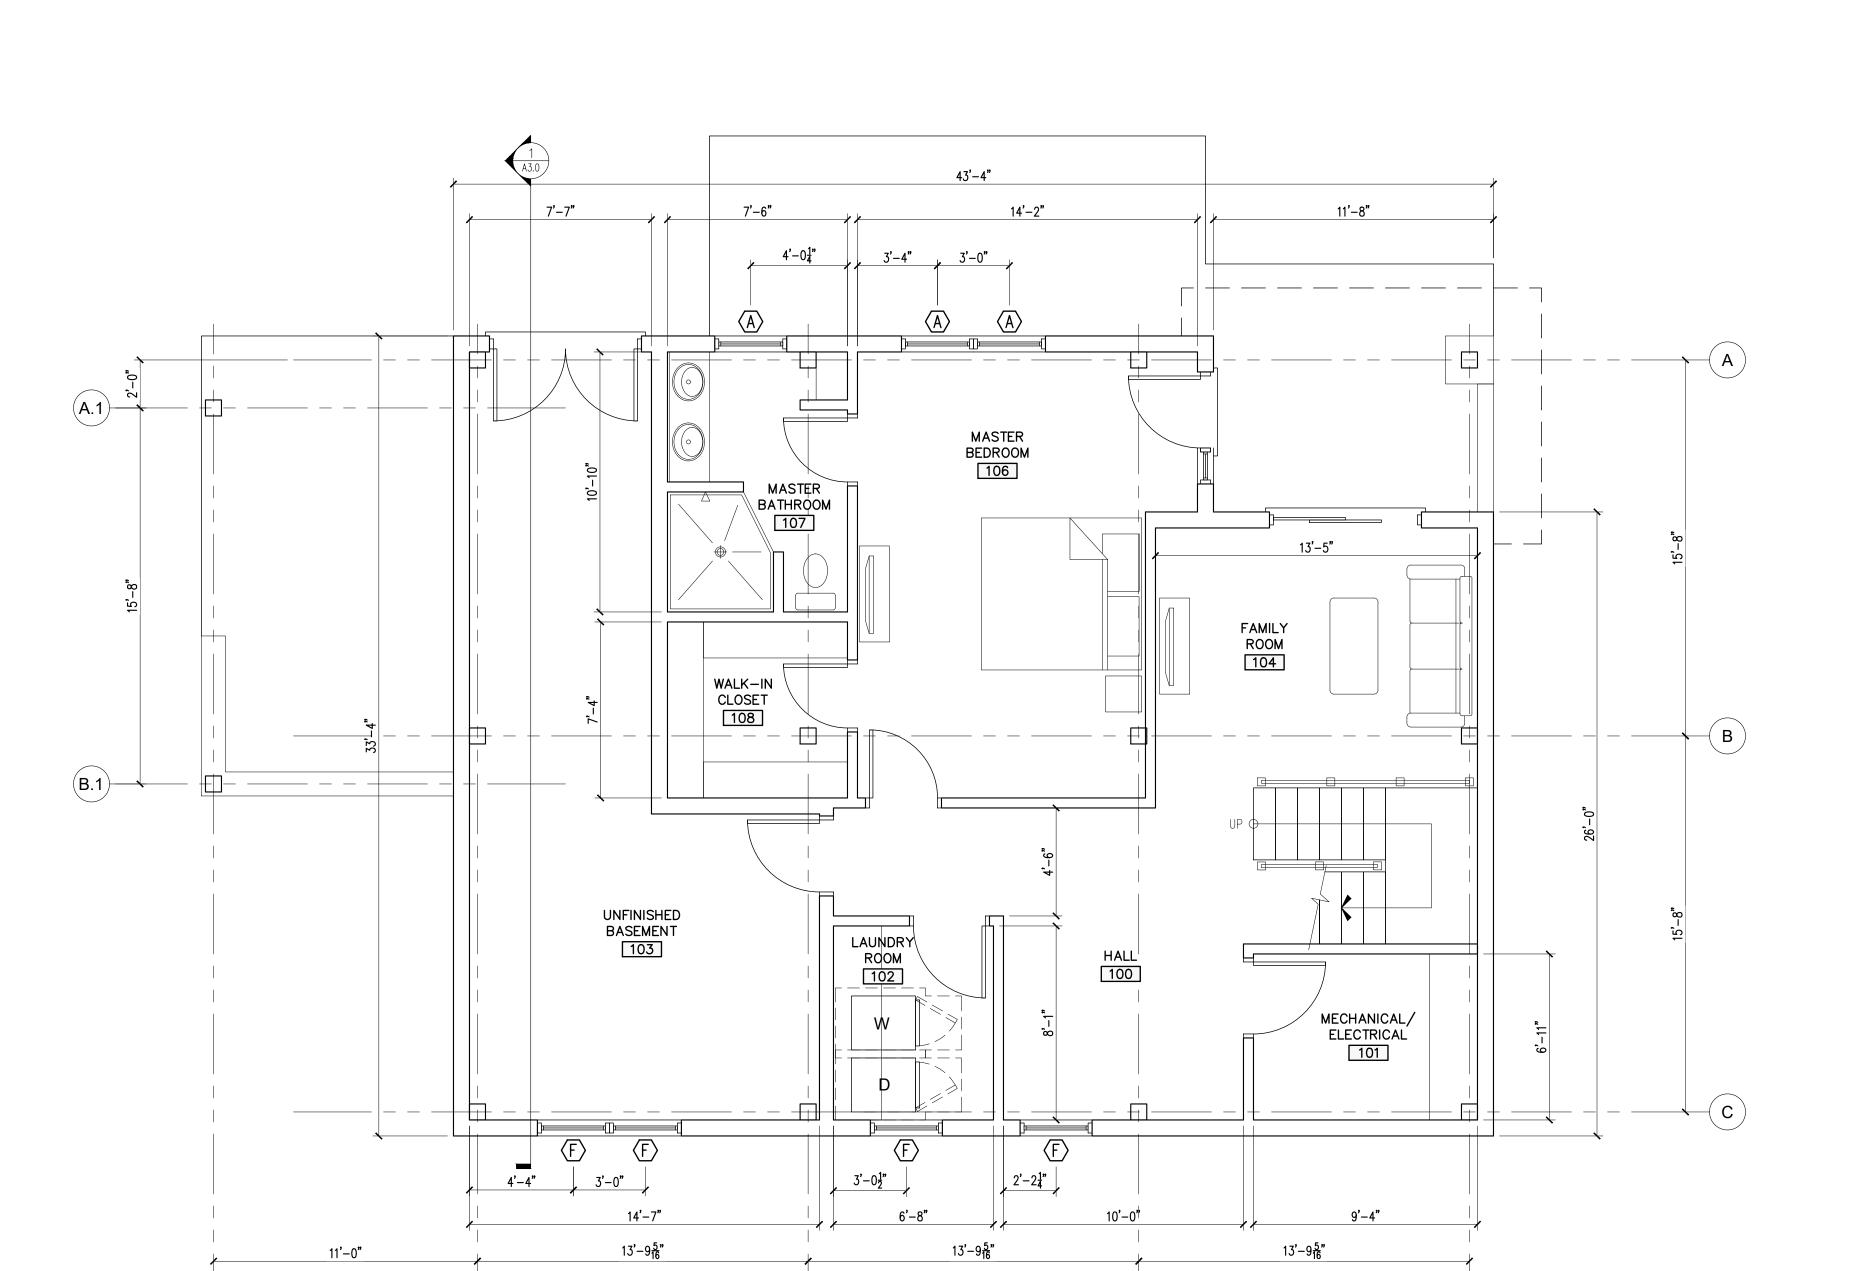

LOWER LEVEL FLOOR PLAN

SCALE: 1/4"=1'-0"

A1.0

RESIDENCE AT 24 FOYES

24 FOYES LANE KITTERY POINT, MAINE 03905

PRO IECT.

STAMP:

WINTER
HOLBEN
architecture + design

7 WALLINGFORD SQ UNIT 209-9 KITTERY, MAINE 03904 207.994.3104

REVISION

PROJECT NAME:

24 FOYES LANE KITTERY POINT, ME 03905

RESIDENCE AT 24 FOYES

 PROJECT NO.:
 23036

 DRAWN BY:
 JF, RW


 APPROVED BY:
 BH

 ISSUE DATE:
 07.14.2023

LOWER LEVEL FLOOR PLAN

DRAWING NO

A1.0

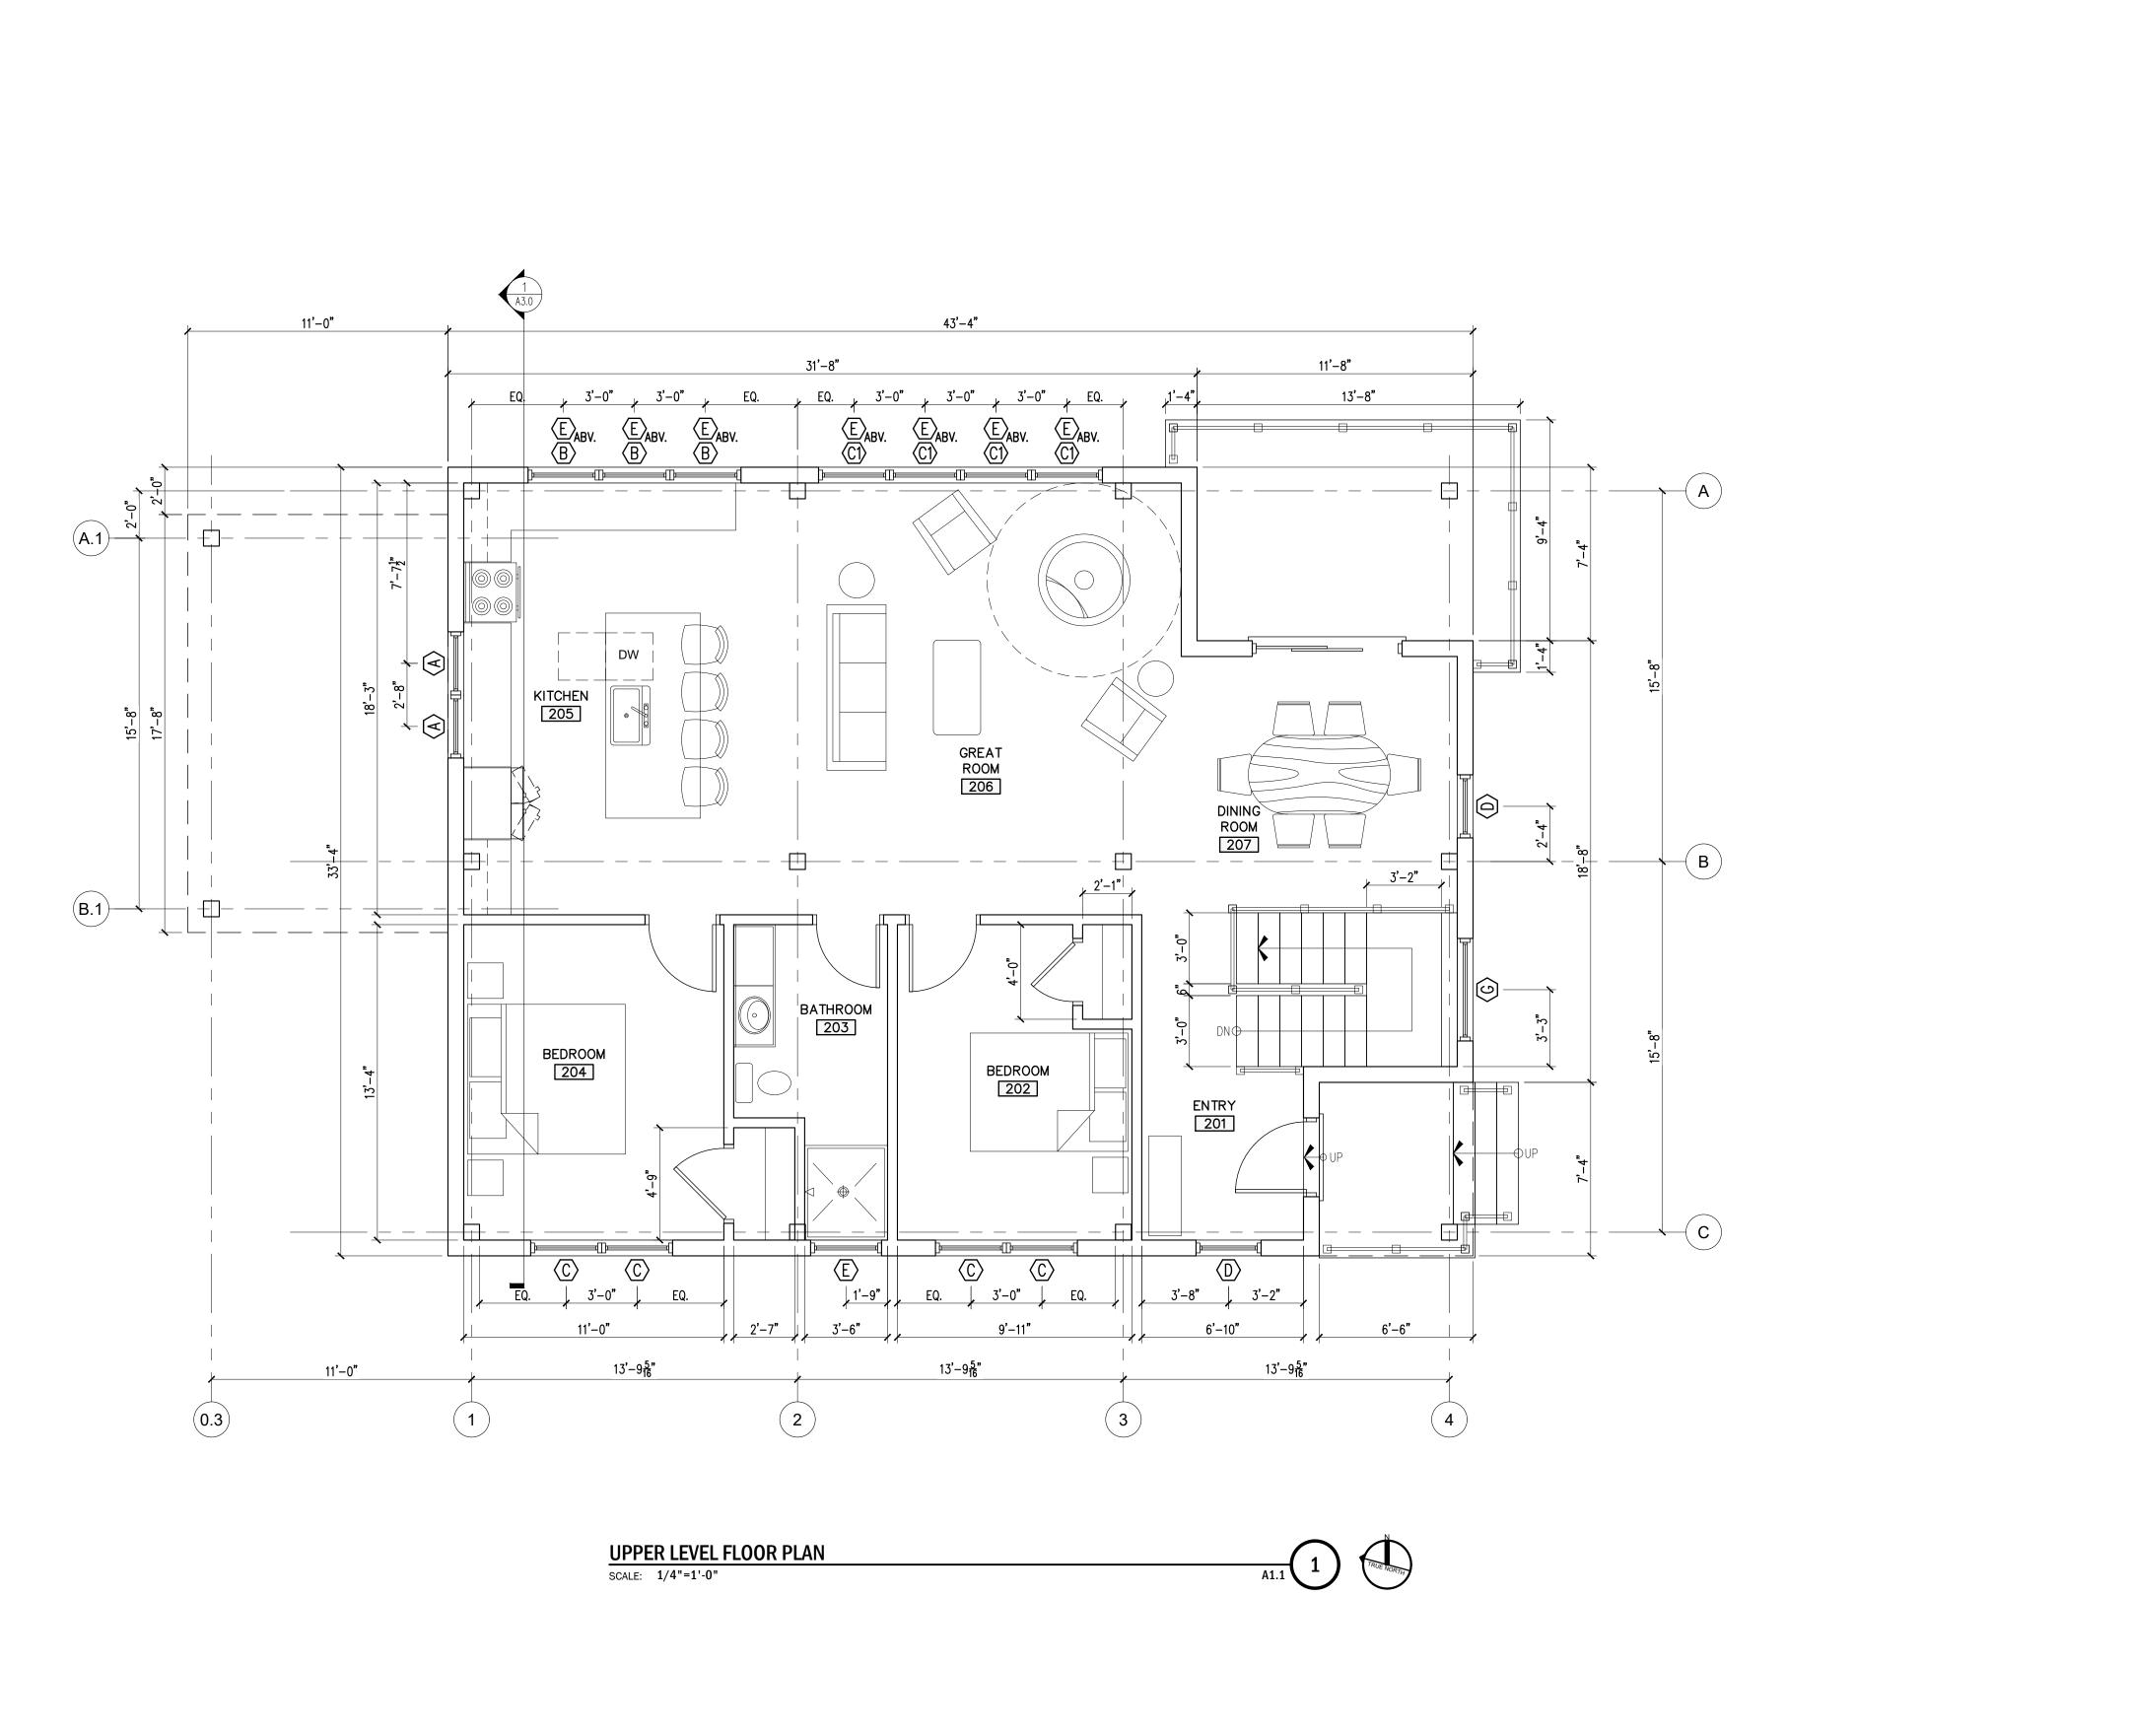

24 FOYES LANE KITTERY POINT, MAINE 03905

PROJECT:

AMP:

WINTER
HOLBEN
architecture + design

7 WALLINGFORD SQ UNIT 209-9 KITTERY, MAINE 03904 207.994.3104

REVISIONS:

PROJECT NAME:

RESIDENCE AT 24 FOYES

24 FOYES LANE KITTERY POINT, ME 03905

 PROJECT NO.:
 23036

 DRAWN BY:
 JF, RW

 APPROVED BY:
 BH


 ISSUE DATE:
 07.14.2023


UPPER LEVEL

FLOOR PLAN

DRAWING NO

A1.1

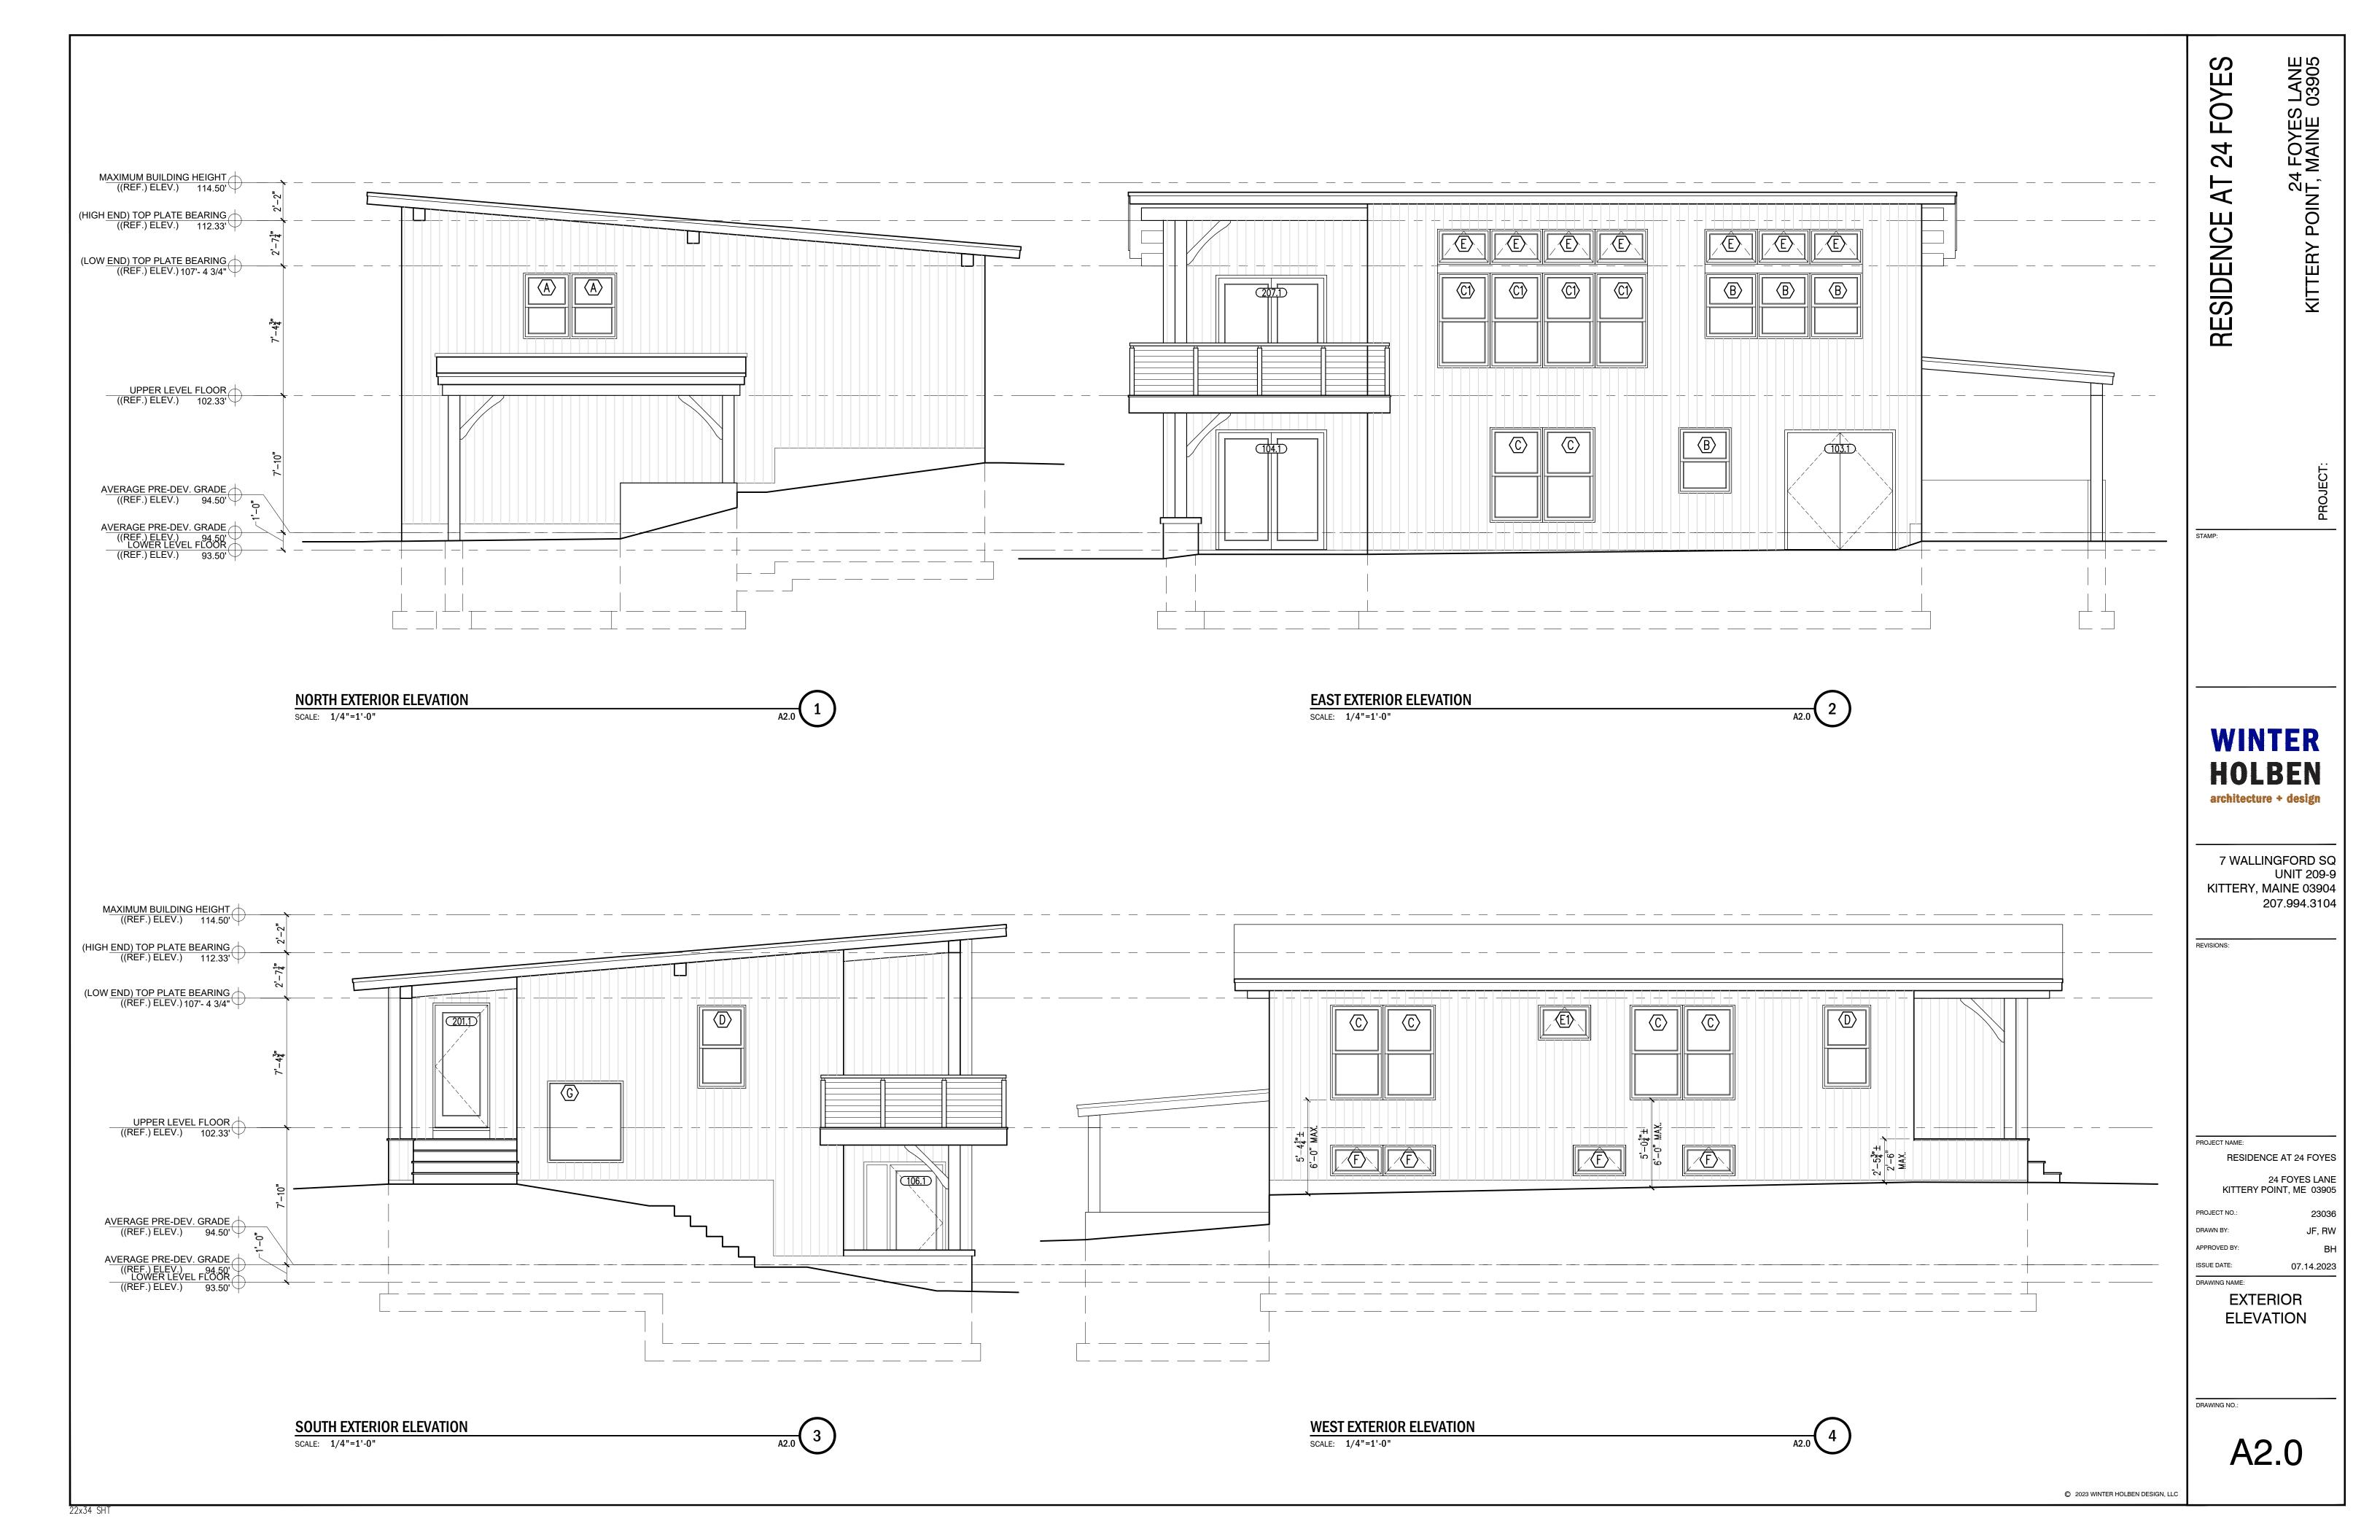

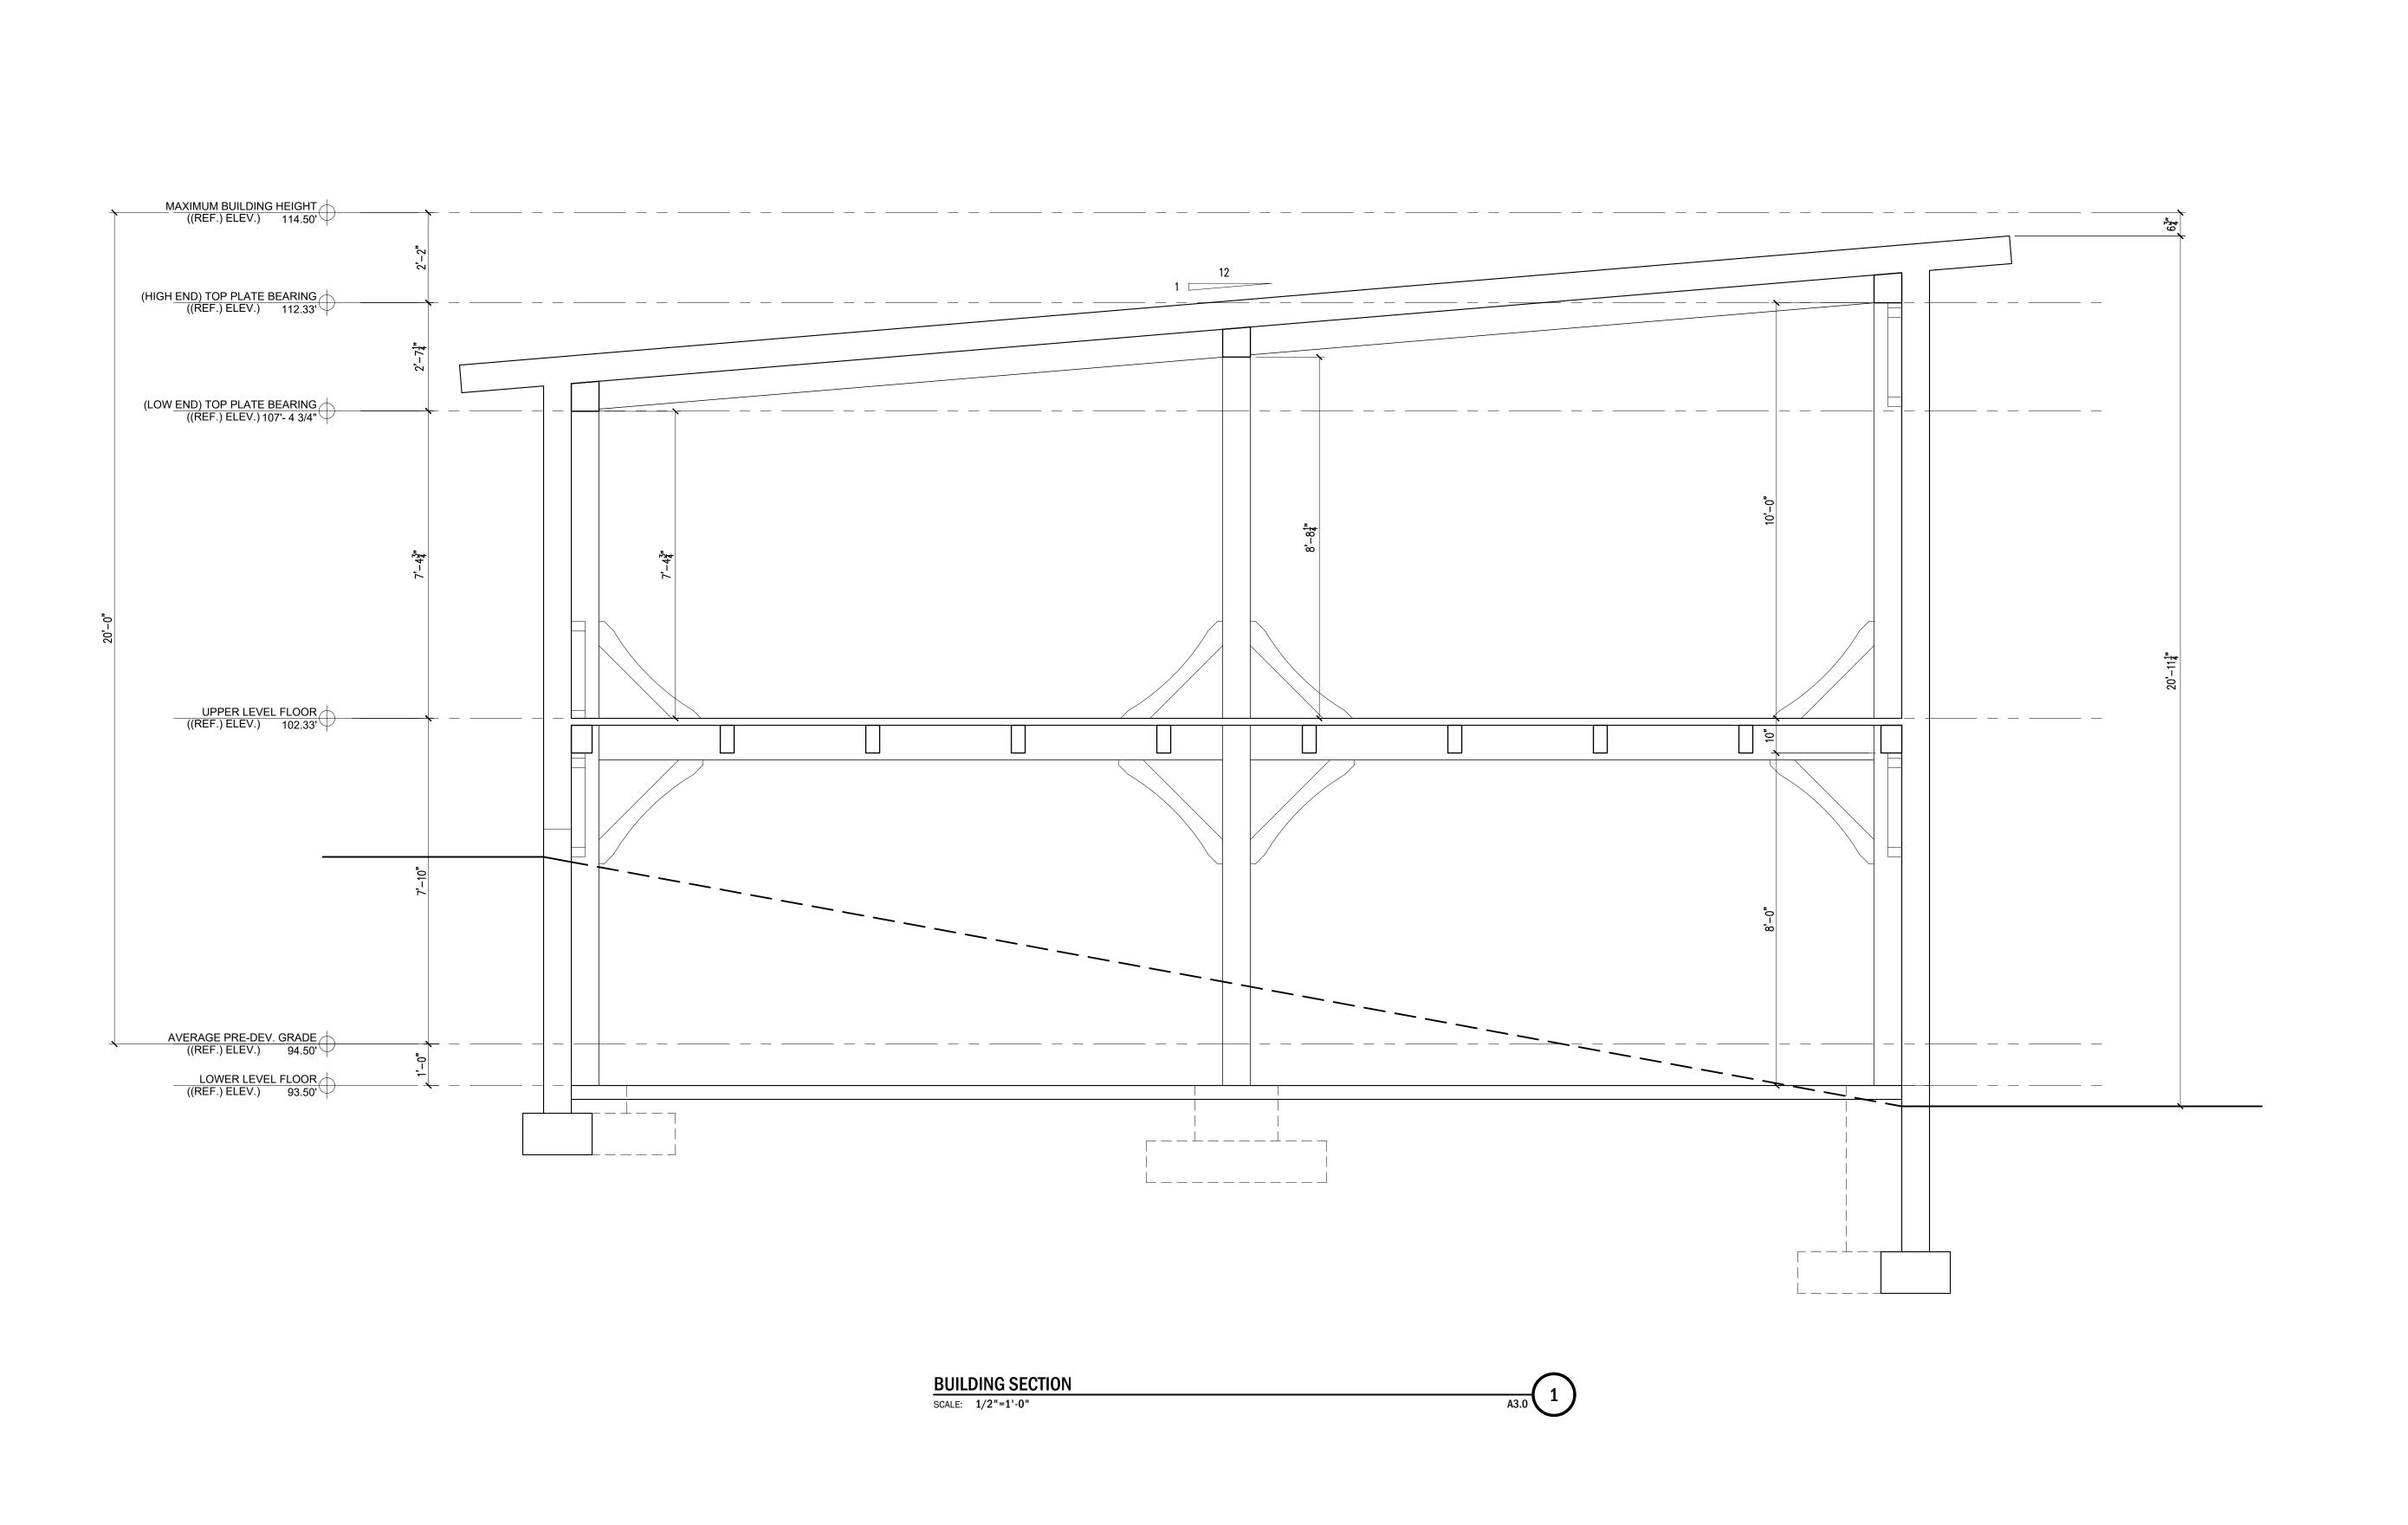

24 FOYES LANE KITTERY POINT, MAINE 03905

PROJECT:

P:

WINTER
HOLBEN
architecture + design

7 WALLINGFORD SQ UNIT 209-9 KITTERY, MAINE 03904 207.994.3104

REVISIONS:

PROJECT NAME:

24 FOYES LANE KITTERY POINT, ME 03905

RESIDENCE AT 24 FOYES

 PROJECT NO.:
 23036

 DRAWN BY:
 JF, RW

 APPROVED BY:
 BH

 ISSUE DATE:
 07.14.2023


BUILDING SECTION

DRAWING NO.:

DRAWING NAME:

A3.0

© 2023 WINTER HOLBEN DESIGN, LLC

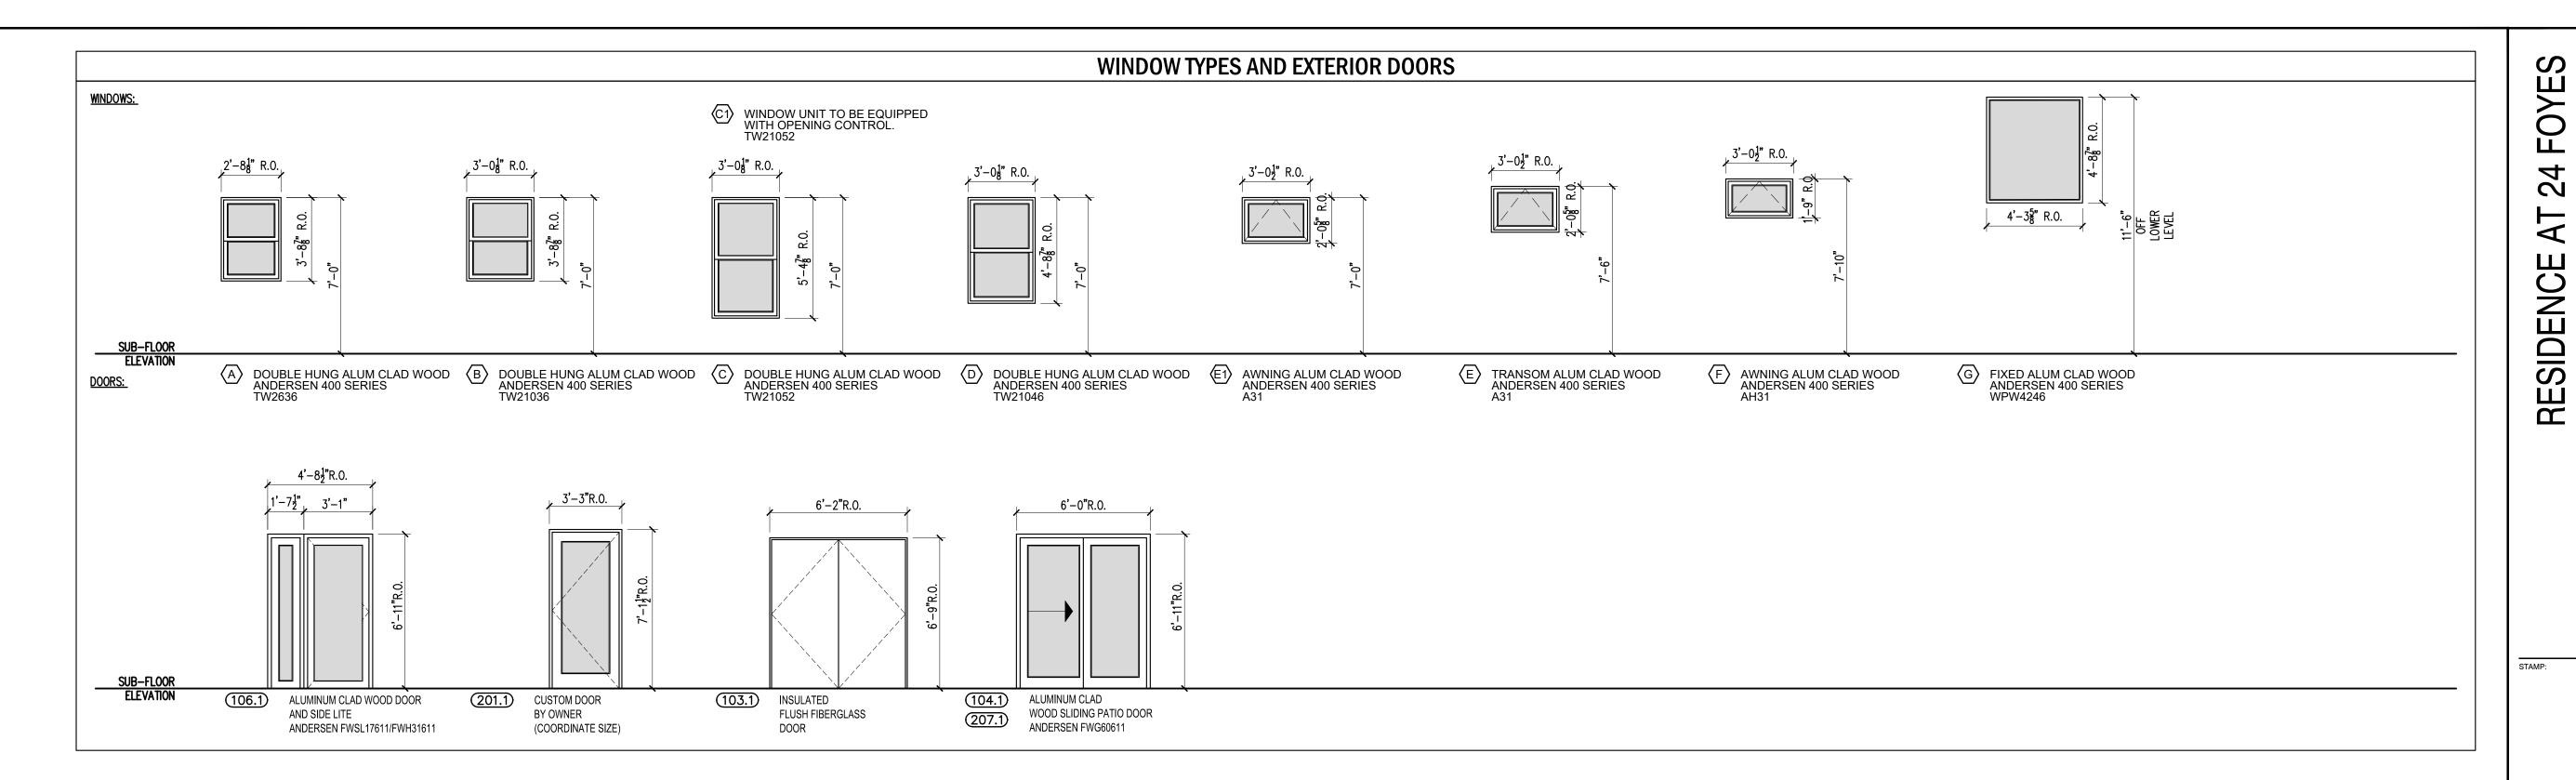

DOOR NOTES:

- 1.) ALL EXTERIOR GLAZING TO BE LOW—E ARGON FILLED INSULATED GLAZING UNITS
- 2.) FRAME ALL OPENINGS WITH ELEVATIONS
- 3.) SEAL EXTERIOR DOORS TO ROUGH OPENING WITH LOW EXPANDING FOAM INSULATION SEE DETAILS
- 4.) ALL EXTERIOR DOORS TO BE WEATHER STRIPPED
- 5.) ALL DOORS TO HAVE SOLID CORES

WINDOW NOTES:

1.) ALL WINDOW UNITS AND MULTI-WINDOW UNIT COMBINATIONS TO MEET OR EXCEED DP-50 RATINGS FOR BOTH STRUCTURAL AND WATER

2.) PROVIDE MULL REINFORCING AT ALL MULTI-UNIT WINDOWS AS REQUIRED TO ACHIEVE DP-50 RATING, WITH INSTALLATION BRACKETS

3.) FULL SCREENS ALL OPENINGS

4.) CONTRACTOR TO VERIFY THAT ALL EGRESS OPENINGS MEET EGRESS REQUIREMENTS

5.) ALL GLAZING LOCATED WITHIN 18" OF FINISHED FLOOR TO BE TEMPERED GLASS

6.) ALL EXTERIOR GLAZING TO BE INSULATED

7.) FRAME ALL OPENINGS WITH ELEVATIONS

8.) SEAL WINDOW TO ROUGH OPENING WITH LOW EXPANDING FOAMINSULATION - SEE DETAILS

WINTER
HOLBEN
architecture + design

24 FOYES LANE POINT, MAINE 03905

KITTERY

7 WALLINGFORD SQ UNIT 209-9 KITTERY, MAINE 03904 207.994.3104

REVISIONS:

PROJECT NAME:

RESIDENCE AT 24 FOYES

24 FOYES LANE KITTERY POINT, ME 03905

PROJECT NO.: 23036

AWN BY: JF, RW
PROVED BY: BH
UE DATE: 07.14.2023

DRAWING NAME:

WINDOW SCHEDULE

DRAWING NO.:

A7.0





24 FOYES LANE KITTERY POINT, MAINE 03905

PROJECT:

STAMP:

WINTER
HOLBEN
architecture + design

7 WALLINGFORD SQ UNIT 209-9 KITTERY, MAINE 03904 207.994.3104

REVISION

CT NAME:

RESIDENCE AT 24 FOYES

24 FOYES LANE
KITTERY POINT, ME 03905

 JECT NO.:
 2300

 WN BY:
 JF, R

 ROVED BY:
 E

BUILDING PERSPECTIVES

DRAWING NO.:

ISSUE DATE:

A8.0